DEVELOPMENT CONTACTS

PROJECT LEAD

SOUTH SUBURBAN PARK AND RECREATION DISTRICT 4810 E. COUNTY LINE RD. LITTLETON, CO 80126 (303) 483-7025 WBarringer@ssprd.org CONTACT: MR. WILL BARRINGER

LANDSCAPE ARCHITECT

STERLING DESIGN ASSOCIATES, LLC 2009 W. LITTLETON BLVD., #300 LITTLETON, CO 80120 (303) 794-4727 joe@sterlingdesignassociates.com CONTACT: MR. JOE WILSON, PLA, CID, QWEL

ELECTRICAL ENGINEER

ACKERMAN ENGINEERING, INC. 3000 YOUNGFIELD ST, SUITE 264 WHEAT RIDGE, CO 80215 (303) 278-7297 hreschl@aeiconsulting.com CONTACT: HELEN RESCHL, MIES, LEED AP

STRUCTURAL ENGINEER

KWS ENGINEERING (303) 728-9929 kwsengineering@gmail.com CONTACT: MR. KEN SCHMIDT

BENCHMARK

AS DESCRIBED ON THE TOPOGRAPHIC SURVEY FOR LONE TREE RECREATIONAL CENTER PICKLE BALL COURTS, PREPARED BY AZTEC CONSULTANTS, INC. ON 06/08/2021:

DOUGLAS COUNTY GIS MONUMENT NUMBER 2.100020 BEING A 3-1/4" ALUMINUM ALLOY CAP IN NORTHEAST CORNER OF INLET BOX LOCATED SOUTH OF THE NORTHBOUND I-25 ONRAMP AND NORTH SIDE LINCOLN AVE AND THE EAST END OF BRIDGE OVER I-25.

NAVD88 ELEV=5988.517'

PROJECT COORDINATES

AS DESCRIBED ON THE TOPOGRAPHIC SURVEY FOR LONE TREE RECREATIONAL CENTER PICKLE BALL COURTS, PREPARED BY AZTEC CONSULTANTS, INC. ON 06/08/2021:

PROJECT COORDINATES ARE MODIFIED COLORADO STATE PLANE CENTRAL ZONE 83(2011) COORDINATES. PROJECT COORDINATES ARE DERIVED FROM STATE PLANE COORDINATES USING THE FOLLOWING FORMULAS:

PROJECT NORTHING = (STATE PLANE NORTHING * 1.00000000) - 1,000,000.00 PROJECT EASTING = (STATE PLANE EASTING * 1.00000000) - 3,000,000.00

CITY OF LONE TREE GENERAL NOTES

THE CITY OF LONE TREE ENGINEER'S SIGNATURE AFFIXED TO THIS DOCUMENT INDICATES THE ENGINEERING DIVISION HAS REVIEWED THE DOCUMENT AND FOUND IT IN GENERAL CONFORMANCE WITH THE CITY OF LONE TREE SUBDIVISION RESOLUTION OR APPROVED VARIANCES TO THOSE REGULATIONS. THE CITY OF LONE TREE ENGINEER, THROUGH ACCEPTANCE OF THIS DOCUMENT, ASSUMES NO RESPONSIBILITY, OTHER THAN STATED ABOVE, FOR THE COMPLETENESS AND/OR ACCURACY OF THESE DOCUMENTS. THE OWNER AND ENGINEER UNDERSTAND THAT THE RESPONSIBILITY FOR THE ENGINEERING ADEQUACY OF THE FACILITIES DEPICTED IN THIS DOCUMENT LIES SOLELY WITH THE REGISTERED PROFESSION ENGINEER WHOSE STAMP AND SIGNATURE IS AFFIXED TO THIS DOCUMENT.

- 2. ALL ROADWAY CONSTRUCTION SHALL CONFORM TO CURRENT DOUGLAS COUNTY ROADWAY DESIGN AND CONSTRUCTION STANDARDS.
- 3. ALL MATERIALS AND WORKMANSHIP SHALL BE SUBJECT TO INSPECTION BY THE CITY OF LONE TREE ENGINEERING DIVISION. THE CITY RESERVES THE RIGHT TO ACCEPT OR REJECT ANY SUCH MATERIALS AND WORKMANSHIP THAT DOES NOT CONFORM TO ITS STANDARDS AND SPECIFICATIONS.
- 4. THE CONTRACTOR SHALL NOTIFY THE CITY OF LONE TREE PUBLIC WORKS, INSPECTION SECTION, (303) 662-8112, A MINIMUM OF 48 HOURS AND A MAXIMUM OF 96 HOURS PRIOR TO STARTING CONSTRUCTION, AND/OR BEFORE RESTARTING CONSTRUCTION AFTER A SHUTDOWN OF MORE THAN 10 DAYS.
- 5. LOCATION OF EXISTING UTILITIES SHALL BE VERIFIED BY THE CONTRACTOR PRIOR TO ACTUAL CONSTRUCTION. FOR INFORMATION, CONTACT: UTILITY NOTIFICATION CENTER OF COLORADO (UNCC) AT (800) 922-1987 OR 811.
- 6. THE CONTRACTOR SHALL HAVE ONE (1) SIGNED COPY (SIGNED BY BOTH DESIGN ENGINEER AND CITY OF LONE TREE) OF THE CONSTRUCTION PLANS AND GESC REPORT AND PLAN, AND ONE (1) COPY OF THE DOUGLAS COUNTY ROADWAY DESIGN AND CONSTRUCTION STANDARDS AT THE JOB SITE AT ALL TIMES.

CIVIL ENGINEER

STERLING DESIGN ASSOCIATES, LLC 2009 W. LITTLETON BLVD., #300 LITTLETON, CO 80120 (303) 794-4727 ryan@sterlingdesignassociates.com CONTACT: MR. RYAN LOFTUS, PE

SURVEYOR

AZTEC CONSULTANTS, INC. 300 EAST MINERAL AVE., SUITE 1 LITTLETON, CO 80122 (303) 713-1898

CITY NOTE:


• THE PROPERTY HEREIN IS SUBJECT TO ALL APPLICABLE REQUIREMENTS OF THE LONE TREE ZONING CODE, INCLUDING, BUT NOT LIMITED TO, MAINTENANCE, LIGHTING, PARKING, SIGNAGE, AND OUTDOOR STORAGE, EXCEPT AS MAY OTHERWISE BE ADDRESSED IN AN APPROVED DEVELOPMENT PLAN OR SUB-AREA PLAN.

• THE APPLICANT ASSUMES RESPONSIBILITY TO ENSURE THE PROJECT IS COMPLETED IN ACCORDANCE WITH THE APPROVED SIP AND ANY ASSOCIATED MATERIALS SAMPLE BOARDS AND FURTHER ASSUMES THE RISK ASSOCIATED WITH ANY CHANGES OR OMISSIONS MADE WITHOUT PRIOR CITY APPROVAL. MODIFICATIONS TO STRUCTURES OR SITES MAY REQUIRE AN AMENDMENT TO THE SIP AS DETERMINED BY THE DIRECTOR. UNAUTHORIZED CHANGES OR OMISSIONS MAY RESULT IN CORRECTIVE ACTIONS, DELAY OF PERMITS OR CITATIONS FOR ZONING VIOLATIONS WITH ASSOCIATED FINES AND LEGAL MEASURES. BUILDING PLANS SHALL CONFORM TO THE APPROVED SIP.

- 7. A ROW/CONSTRUCTION PERMIT MUST BE OBTAINED BEFORE ANY WORK WITHIN PRIOR TO REQUESTED START FOR THE WORK IN THE ROW.
- WITHOUT AN APPROVED TRAFFIC CONTROL PLAN FOR TRAFFIC CONTROL DURING CONSTRUCTION.
- 9. THE CONSTRUCTION PLANS SHALL BE CONSIDERED VALID FOR TWO (2) YEARS FROM THE DATE OF CITY OF LONE TREE ACCEPTANCE/APPROVAL. IF APPLICABLE CONSTRUCTION PERMITS HAVE NOT BEEN OBTAINED, AND CONSTRUCTION STARTED AND RE-ACCEPTANCE BY THE CITY OF LONE TREE.
- WORKING OUTSIDE OF THE PUBLIC RIGHT-OF-WAY ON ANY FACILITY WHICH WILL BE SPECIAL DISTRICT FOR MAINTENANCE (STORM SEWER, ENERGY DISSIPATERS, MAY RESULT IN NON-ACCEPTANCE OF THE FACILITIES/INFRASTRUCTURE BY CITY AND/OR URBAN DRAINAGE.

RIDGEGATE - SECTION 15 FILING NO. 3 PLANNING AREA OS NO. 21

MAJOR AMENDMENT SITE IMPROVEMENT PLANS SIP #SP22-33R

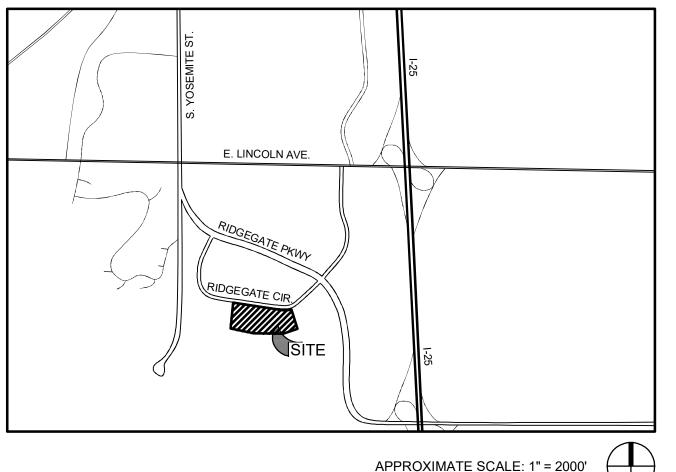

COVER SHEET

GRADING PLAN

UTILITY PLAN SITE DETAILS

SITE DETAILS

SHELTER DETAILS

LANDSCAPE PLAN

IRRIGATION PLAN

LANDSCAPE NOTES & DETAILS

IRRIGATION NOTES & DETAILS

SITE PHOTOMETRIC PLAN

LIGHTING CUT SHEETS

SITE PLAN

SHEET INDEX

01 OF 13

02 OF 13

03 OF 13

04 OF 13

05 OF 13 06 OF 13

07 OF 13

08 OF 13

09 OF 13

10 OF 13

11 OF 13

12 OF 13

13 OF 13

NORTH

(Name of Owner)

APPROVAL CERTIFICATE

EXISTING OR PROPOSED PUBLIC ROW. THE PERMIT APPLICATION MUST BE SUBMITTED TO THE CITY OF LONE TREE ENGINEER FOR REVIEW/PROCESSING A MINIMUM OF 7 DAYS


8. A PLAN FOR TRAFFIC CONTROL DURING CONSTRUCTION SHALL BE SUBMITTED TO THE CITY OF LONE TREE ENGINEER FOR ACCEPTANCE WITH THE PERMIT APPLICATION. AN EXCAVATION OR PUBLIC IMPROVEMENTS CONSTRUCTION PERMIT WILL NOT BE ISSUED

WITHIN THAT TIME, THESE PLANS SHALL BE VOID AND WILL BE SUBJECT TO RE-REVIEW

10. CONTRACTOR SHALL NOTIFY THE CITY OF LONE TREE ENGINEER INSPECTOR WHEN CONVEYED TO THE CITY, URBAN DRAINAGE AND FLOOD CONTROL DISTRICT, OR OTHER DETENTION OUTLET STRUCTURES, OR OTHER DRAINAGE INFRASTRUCTURES). FAILURE TO NOTIFY ENGINEERING INSPECTOR TO ALLOW THEM TO INSPECT THE CONSTRUCTION

SIGNATURE BLOCK

APPROVAL CERTIFICATE
THIS SIP HAS BEEN REVIEWED AND FOUND TO BE COMPLETE AND IN ACCORD WITH CITY REGULATIONS, AS APPROVED BY THE CITY ON
REGULATIONS, AS APPROVED BY THE CITY ON (DATE)
Ву:
Name:
Title: Planning Manager
Date:
By:
Name:
Director of Public Works or his/her designated representative
Date:
The owner(s) of the lands described herein, hereby agree(s) (1) to develop and maintain the property described hereon in accordance with this approved Site Improvement Plan and in compliance with Chapter 16 of the Lone Tree Municipal Code and that (2) the heirs, successors and assigns of the owner(s) shall also be bound. The signatures of the owner(s)'(s) representative(s) below indicate that any required authorizations to enter this agreement, including any corporate authorizations, have been obtained.
(Name of Owner)
(Signature of Owner)
(Printed Name & Title)
State of)) SS
County of)
Subscribed and sworn to before me this day of, 20, by
Witness my hand and official seal.
My commission expires:
Notary Public
Approval by the City of Lone Tree does not signify that the requirements of the Americans with Disabilities Act (ADA) have been satisfied. The applicant is responsible to ensure that said ADA requirements have been met.

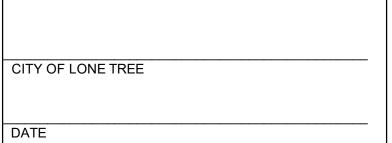

THESE CONSTRUCTION PLANS HAVE BEEN REVIEWED BY THE CITY OF LONE TREE FOR GRADING AND EROSION CONTROL ONLY.

ENGINEERING DIVISION ACCEPTANCE BLOCK



PREPARED UNDER THE DIRECT SUPERVISION OF RYAN J. LOFTUS, PE COLORADO REGISTRATION NO. 48224 FOR & ON BEHALF OF STERLING DESIGN ASSOCIATES, LLC

303.794.4727 | www.SterlingDesignAssociates.com

PRELIMINARY	
NOT FOR CONSTRUCTION	

STERLING DESIGN ASSOCIATES, LLC

ISSUES & REVISIONS		
NO.: 1 DATE: 04/29/2022	BY:	JLW
DESCRIPTION: 1ST SIP REVISION PER CITY COMMEN	TS	
NO.: 2 DATE: -	BY:	-
DESCRIPTION: -		
NO.: 3 DATE: -	BY:	-
DESCRIPTION: -		
NO.: 4 DATE: -	BY:	-
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NO.: 5 DATE: -	BY:	-
DESCRIPTION: -		
NO.: 6 DATE: -	BY:	-
DESCRIPTION: -		

DATE:	SCALE:
03/28/2022	-
PROJECT MANAGER:	PROJECT NO.:
JLW	-
DRAWN BY:	DRAWING FILE:
RJL	-

LONE TREE RECREATION **CENTER PICKLE BALL COURTS 10249 RIDGEGATE CIRCLE** LONE TREE, CO 80124








4810 E. COUNTY LINE RD. LITTLETON, CO 80126

TEL: (303) 798-5131

SHEET TITLE: **COVER SHEET**

SHEET NUMBER:

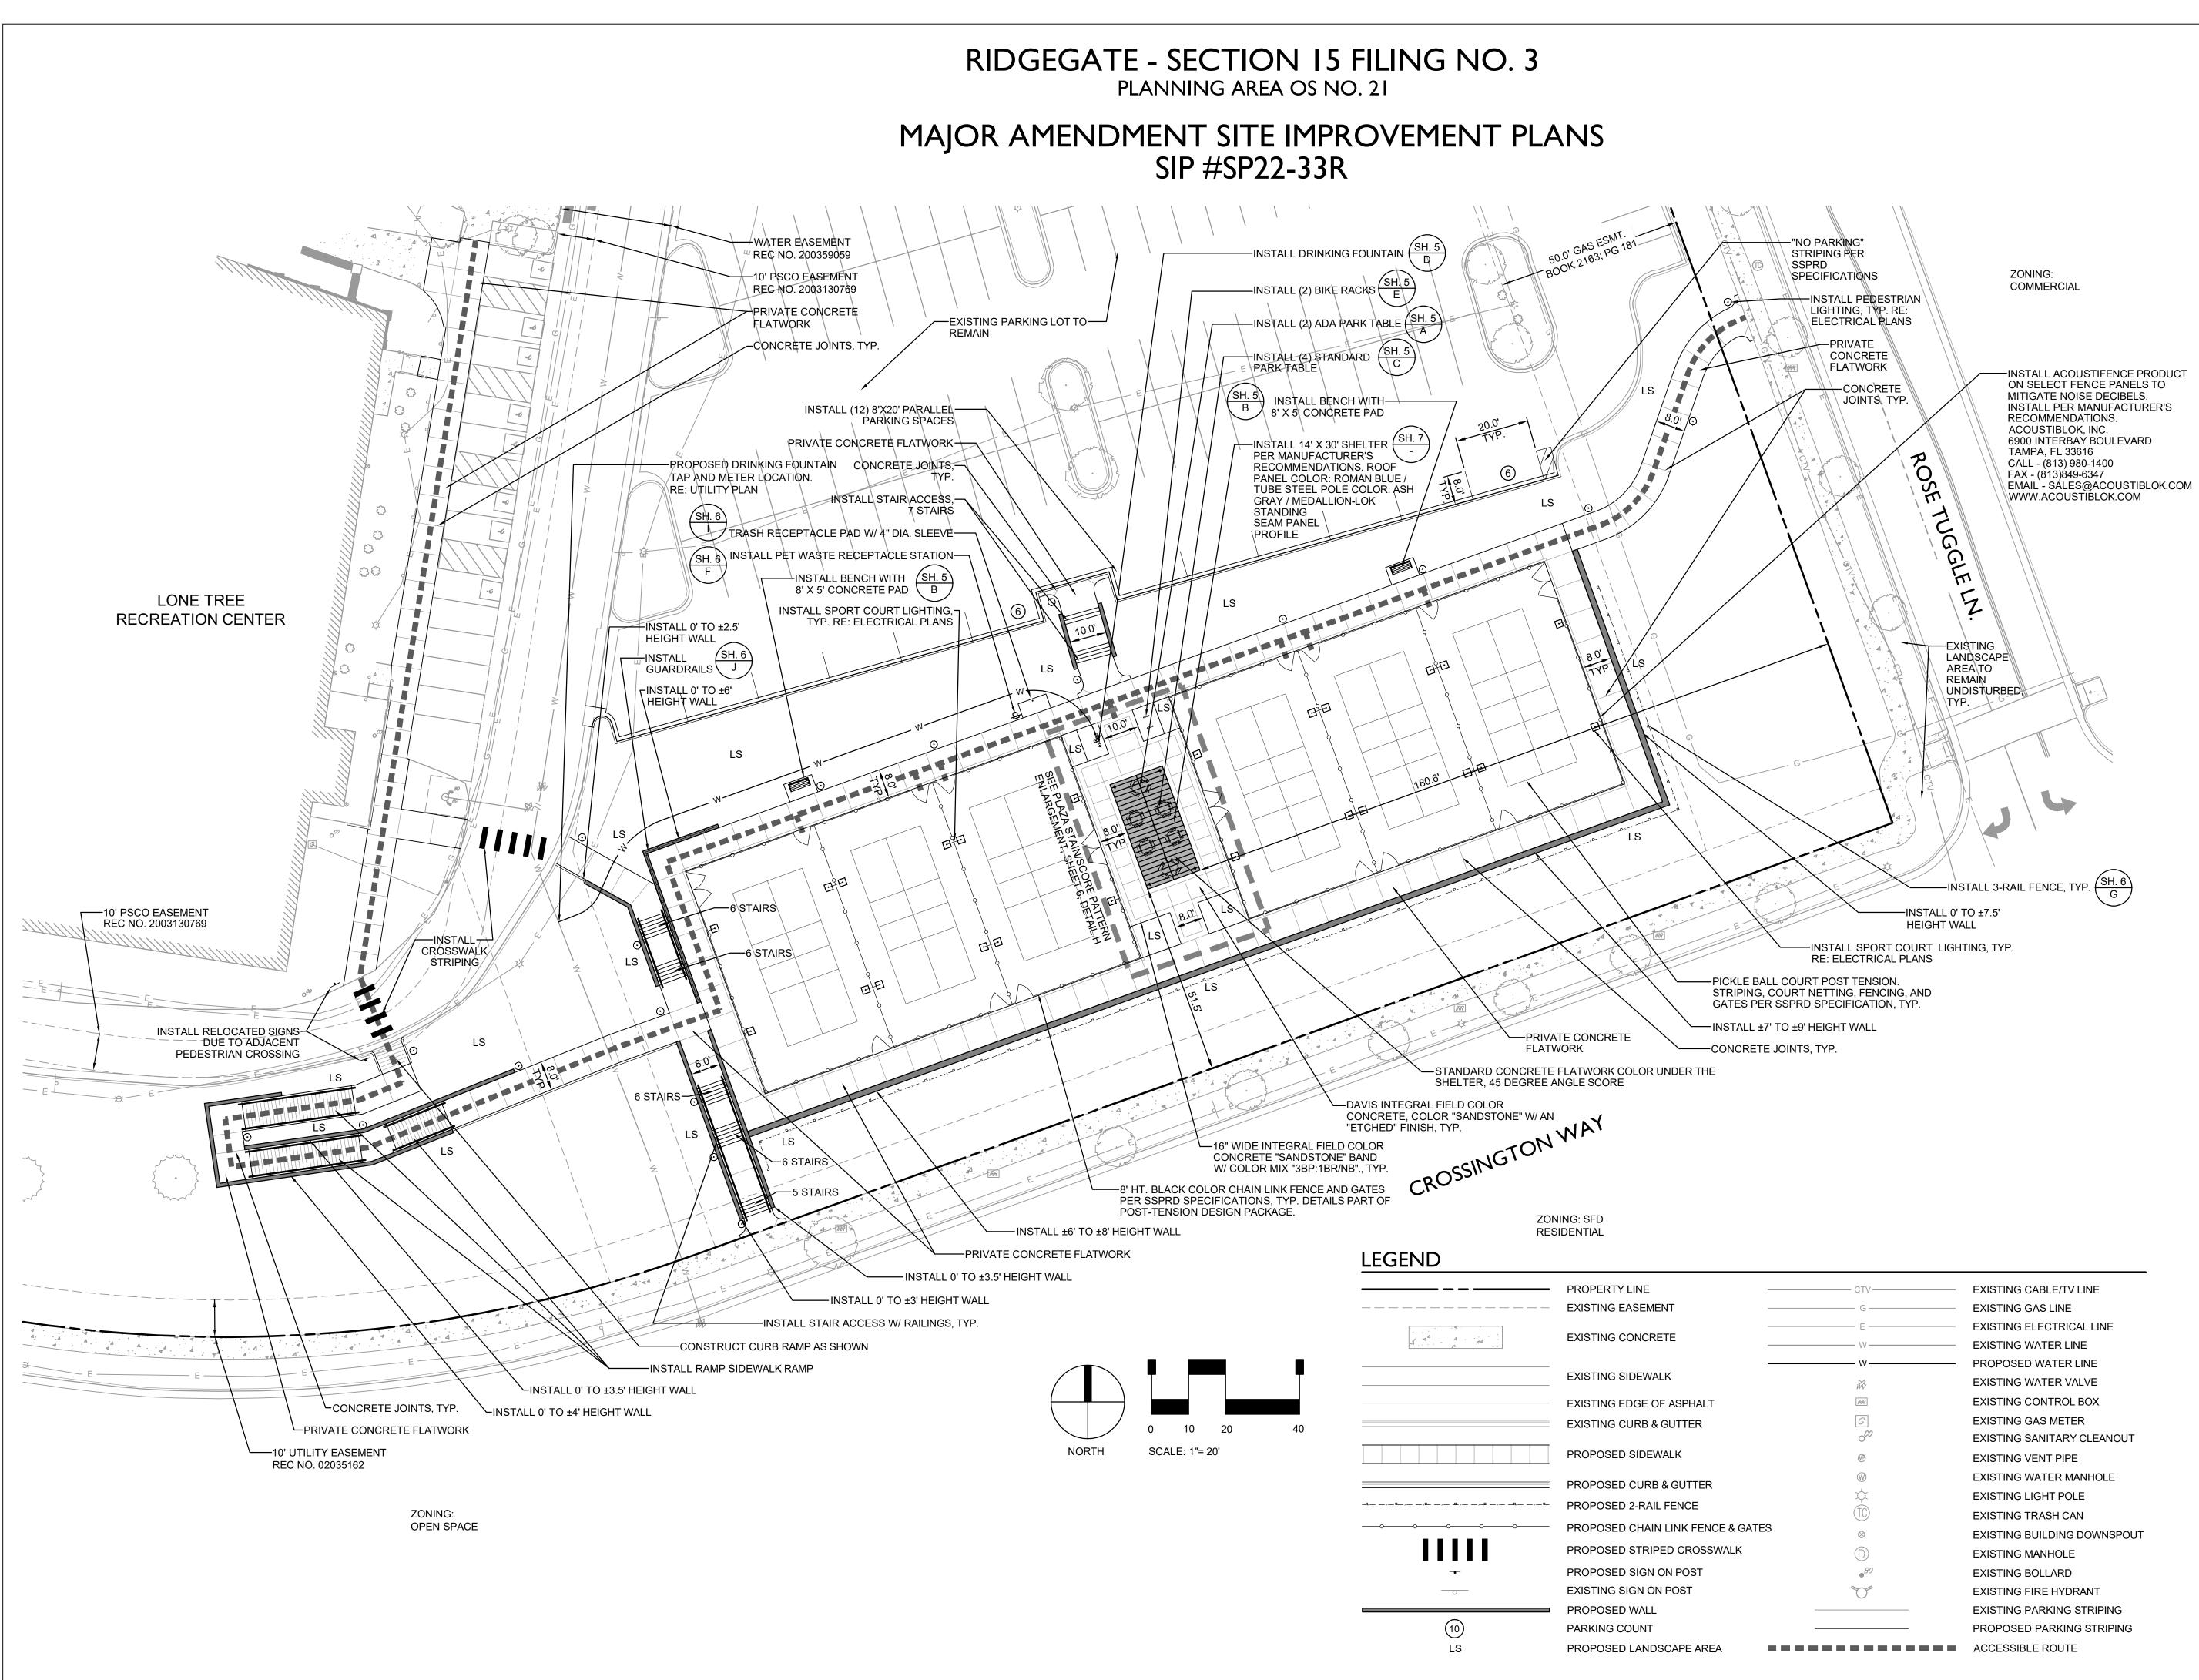



PREPARED UNDER THE DIRECT SUPERVISION OF RYAN J. LOFTUS, PE COLORADO REGISTRATION NO. 48224

FOR & ON BEHALF OF STERLING DESIGN ASSOCIATES, LLC



STERLING DESIGN ASSOCIATES, LLC

ISSUES &	REVISION	IS		
NO.: 1	DATE:	04/29/2022	BY:	JLW
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JLW	-
DRAWN BY:	DRAWING FILE:
RJL	-

LONE TREE RECREATION **CENTER PICKLE BALL COURTS 10249 RIDGEGATE CIRCLE** LONE TREE, CO 80124




4810 E. COUNTY LINE RD. LITTLETON, CO 80126 TEL: (303) 798-5131

SHEET TITLE: SITE PLAN

PROJECT

SHEET NUMBER:

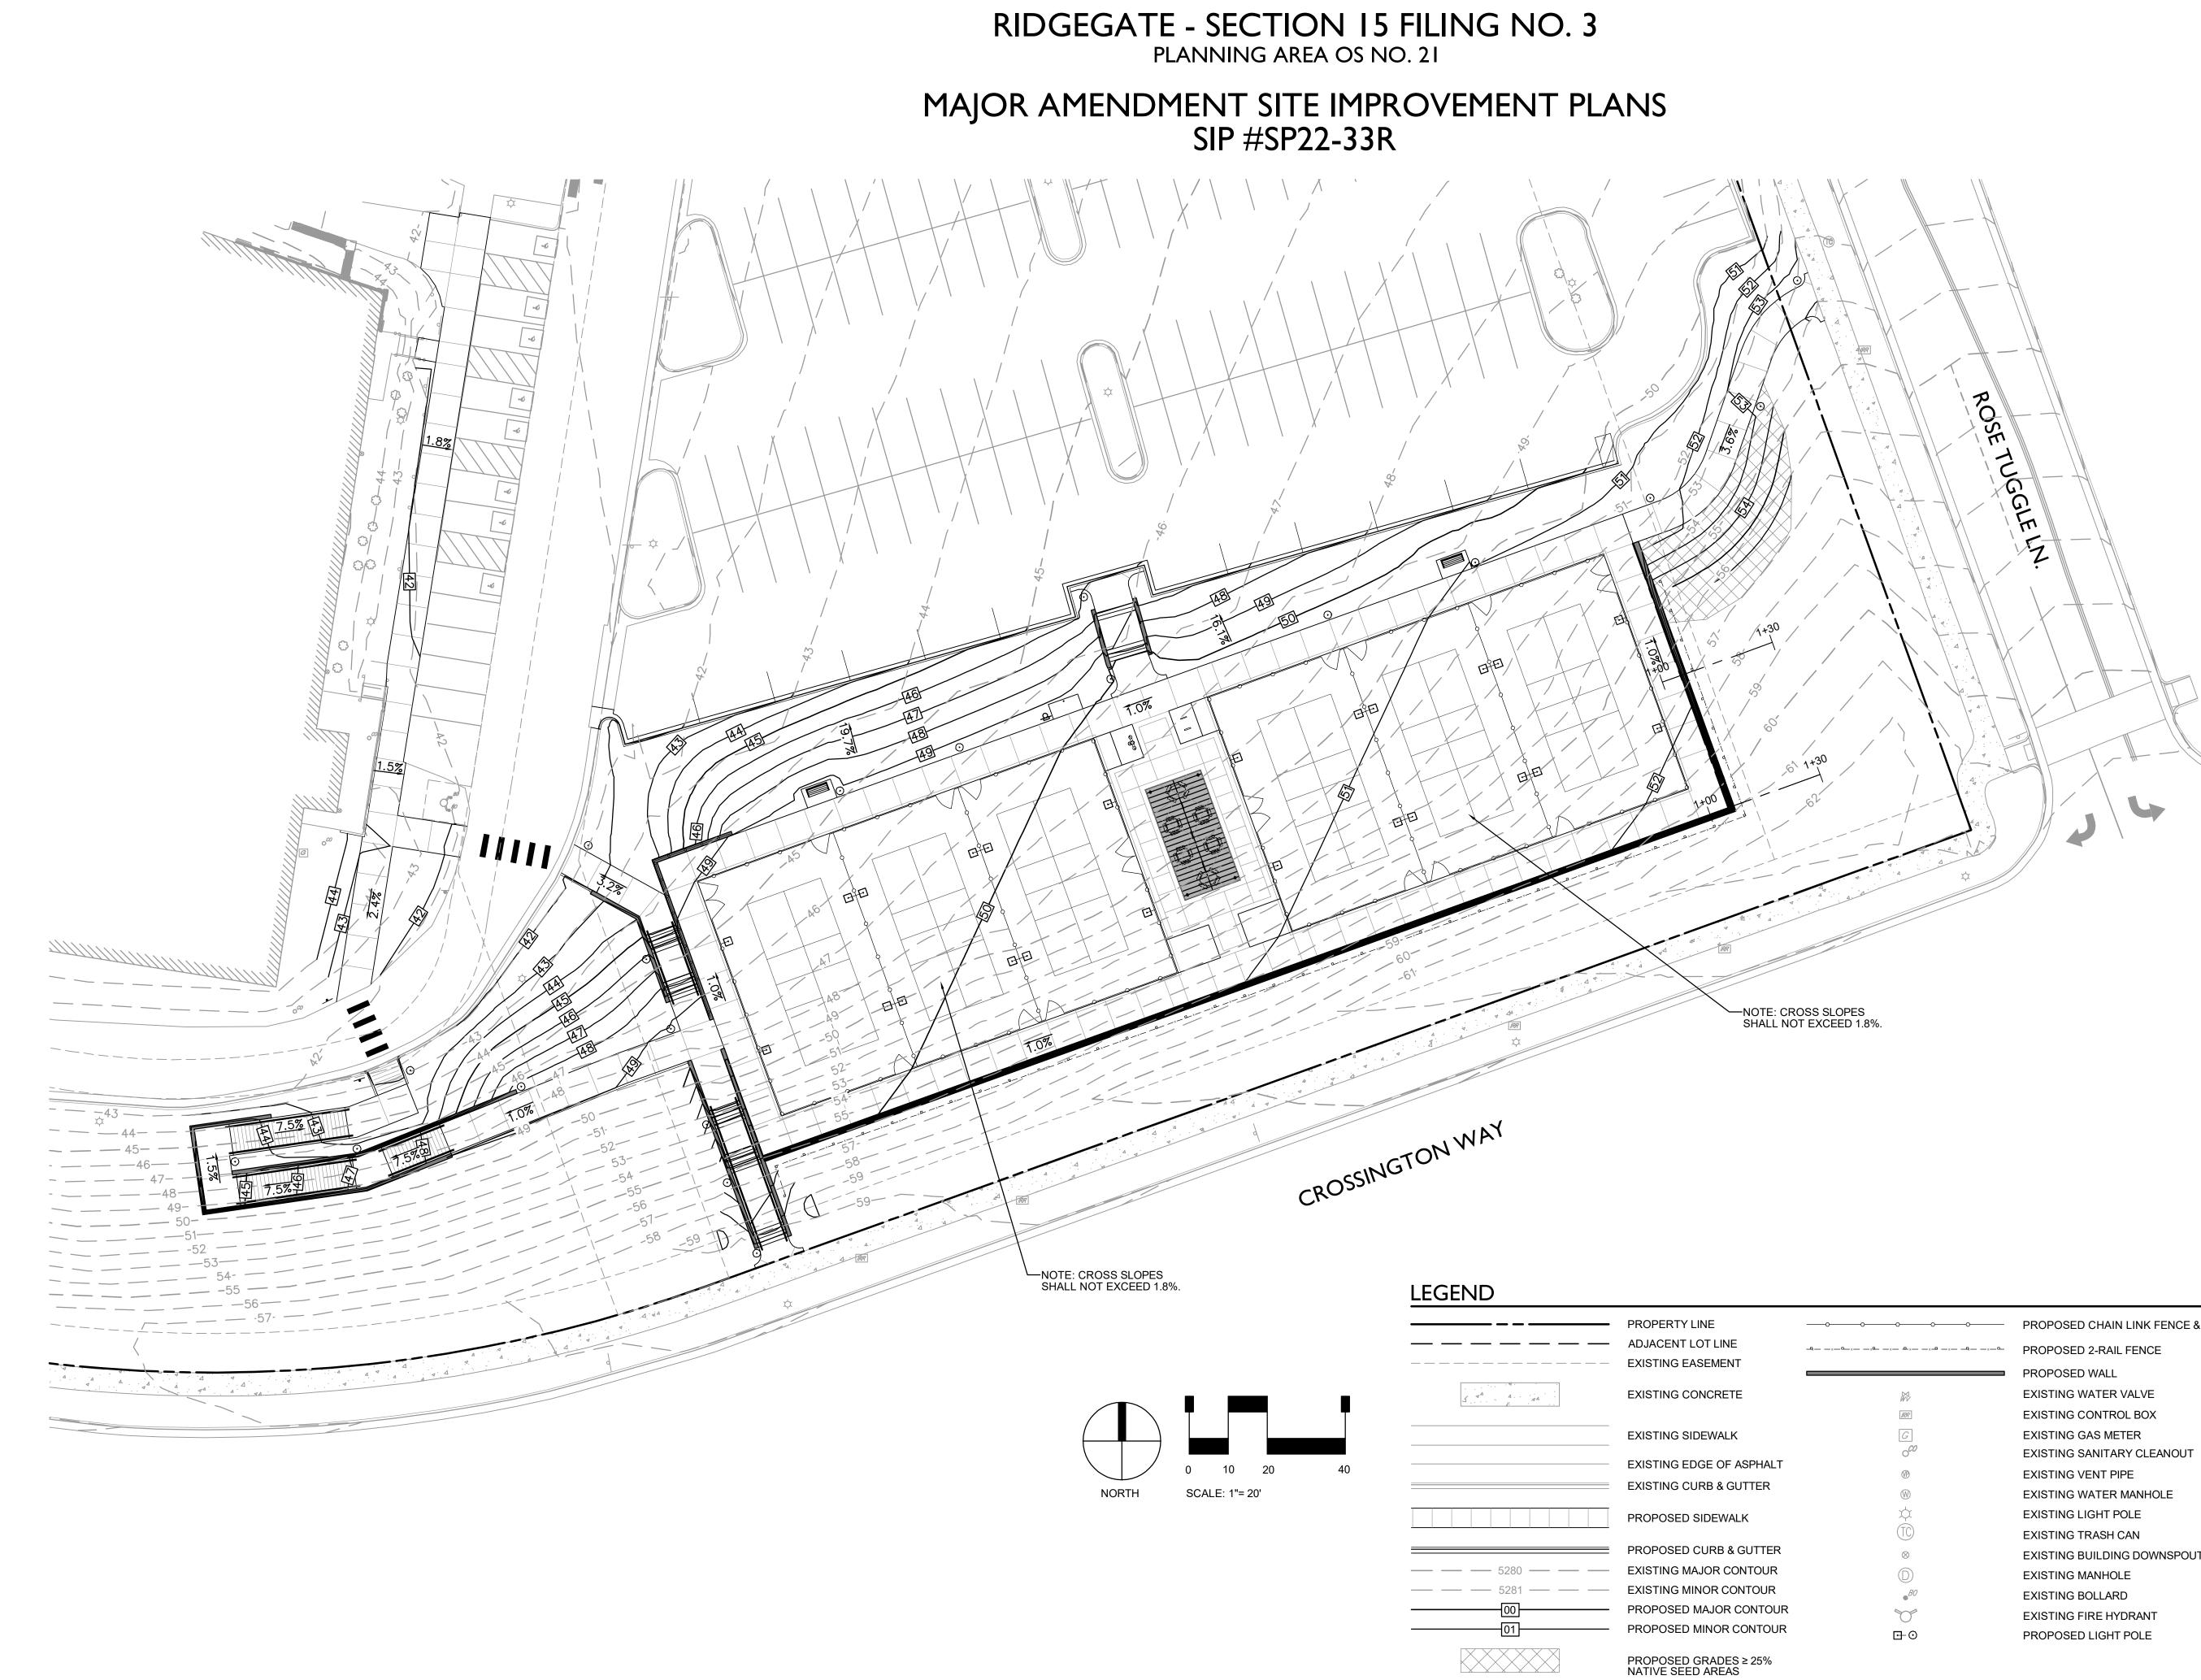

1.00%

PROPOSED SLOPE

-oooo	PROPOSED CHAIN LINK FENCE & GATES
xxxxxx	PROPOSED 2-RAIL FENCE
	PROPOSED WALL
22	EXISTING WATER VALVE
[IRR]	EXISTING CONTROL BOX
G	EXISTING GAS METER
° ^{C0}	EXISTING SANITARY CLEANOUT
®	EXISTING VENT PIPE
\otimes	EXISTING WATER MANHOLE
<u>¢</u>	EXISTING LIGHT POLE
(TC)	EXISTING TRASH CAN
\otimes	EXISTING BUILDING DOWNSPOUT
\square	EXISTING MANHOLE
BO	EXISTING BOLLARD
T.	EXISTING FIRE HYDRANT
⊡⊙	PROPOSED LIGHT POLE



PREPARED UNDER THE DIRECT SUPERVISION OF RYAN J. LOFTUS, PE COLORADO REGISTRATION NO. 48224 FOR & ON BEHALF OF STERLING DESIGN ASSOCIATES, LLC



STERLING DESIGN ASSOCIATES, LLC

NO.: 1	DATE:	04/29/2022	BY:	JLW
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DATE: 03/28/2022	SCALE: 1" = 20'	
PROJECT MANAGER: RJL	PROJECT NO.:	
DRAWN BY: RJL	DRAWING FILE:	


PROJECT: LONE TREE RECREATION CENTER PICKLE BALL COURTS 10249 RIDGEGATE CIRCLE LONE TREE, CO 80124



4810 E. COUNTY LINE RD. LITTLETON, CO 80126 TEL: (303) 798-5131

SHEET TITLE: **GRADING PLAN**

SHEET NUMBER:

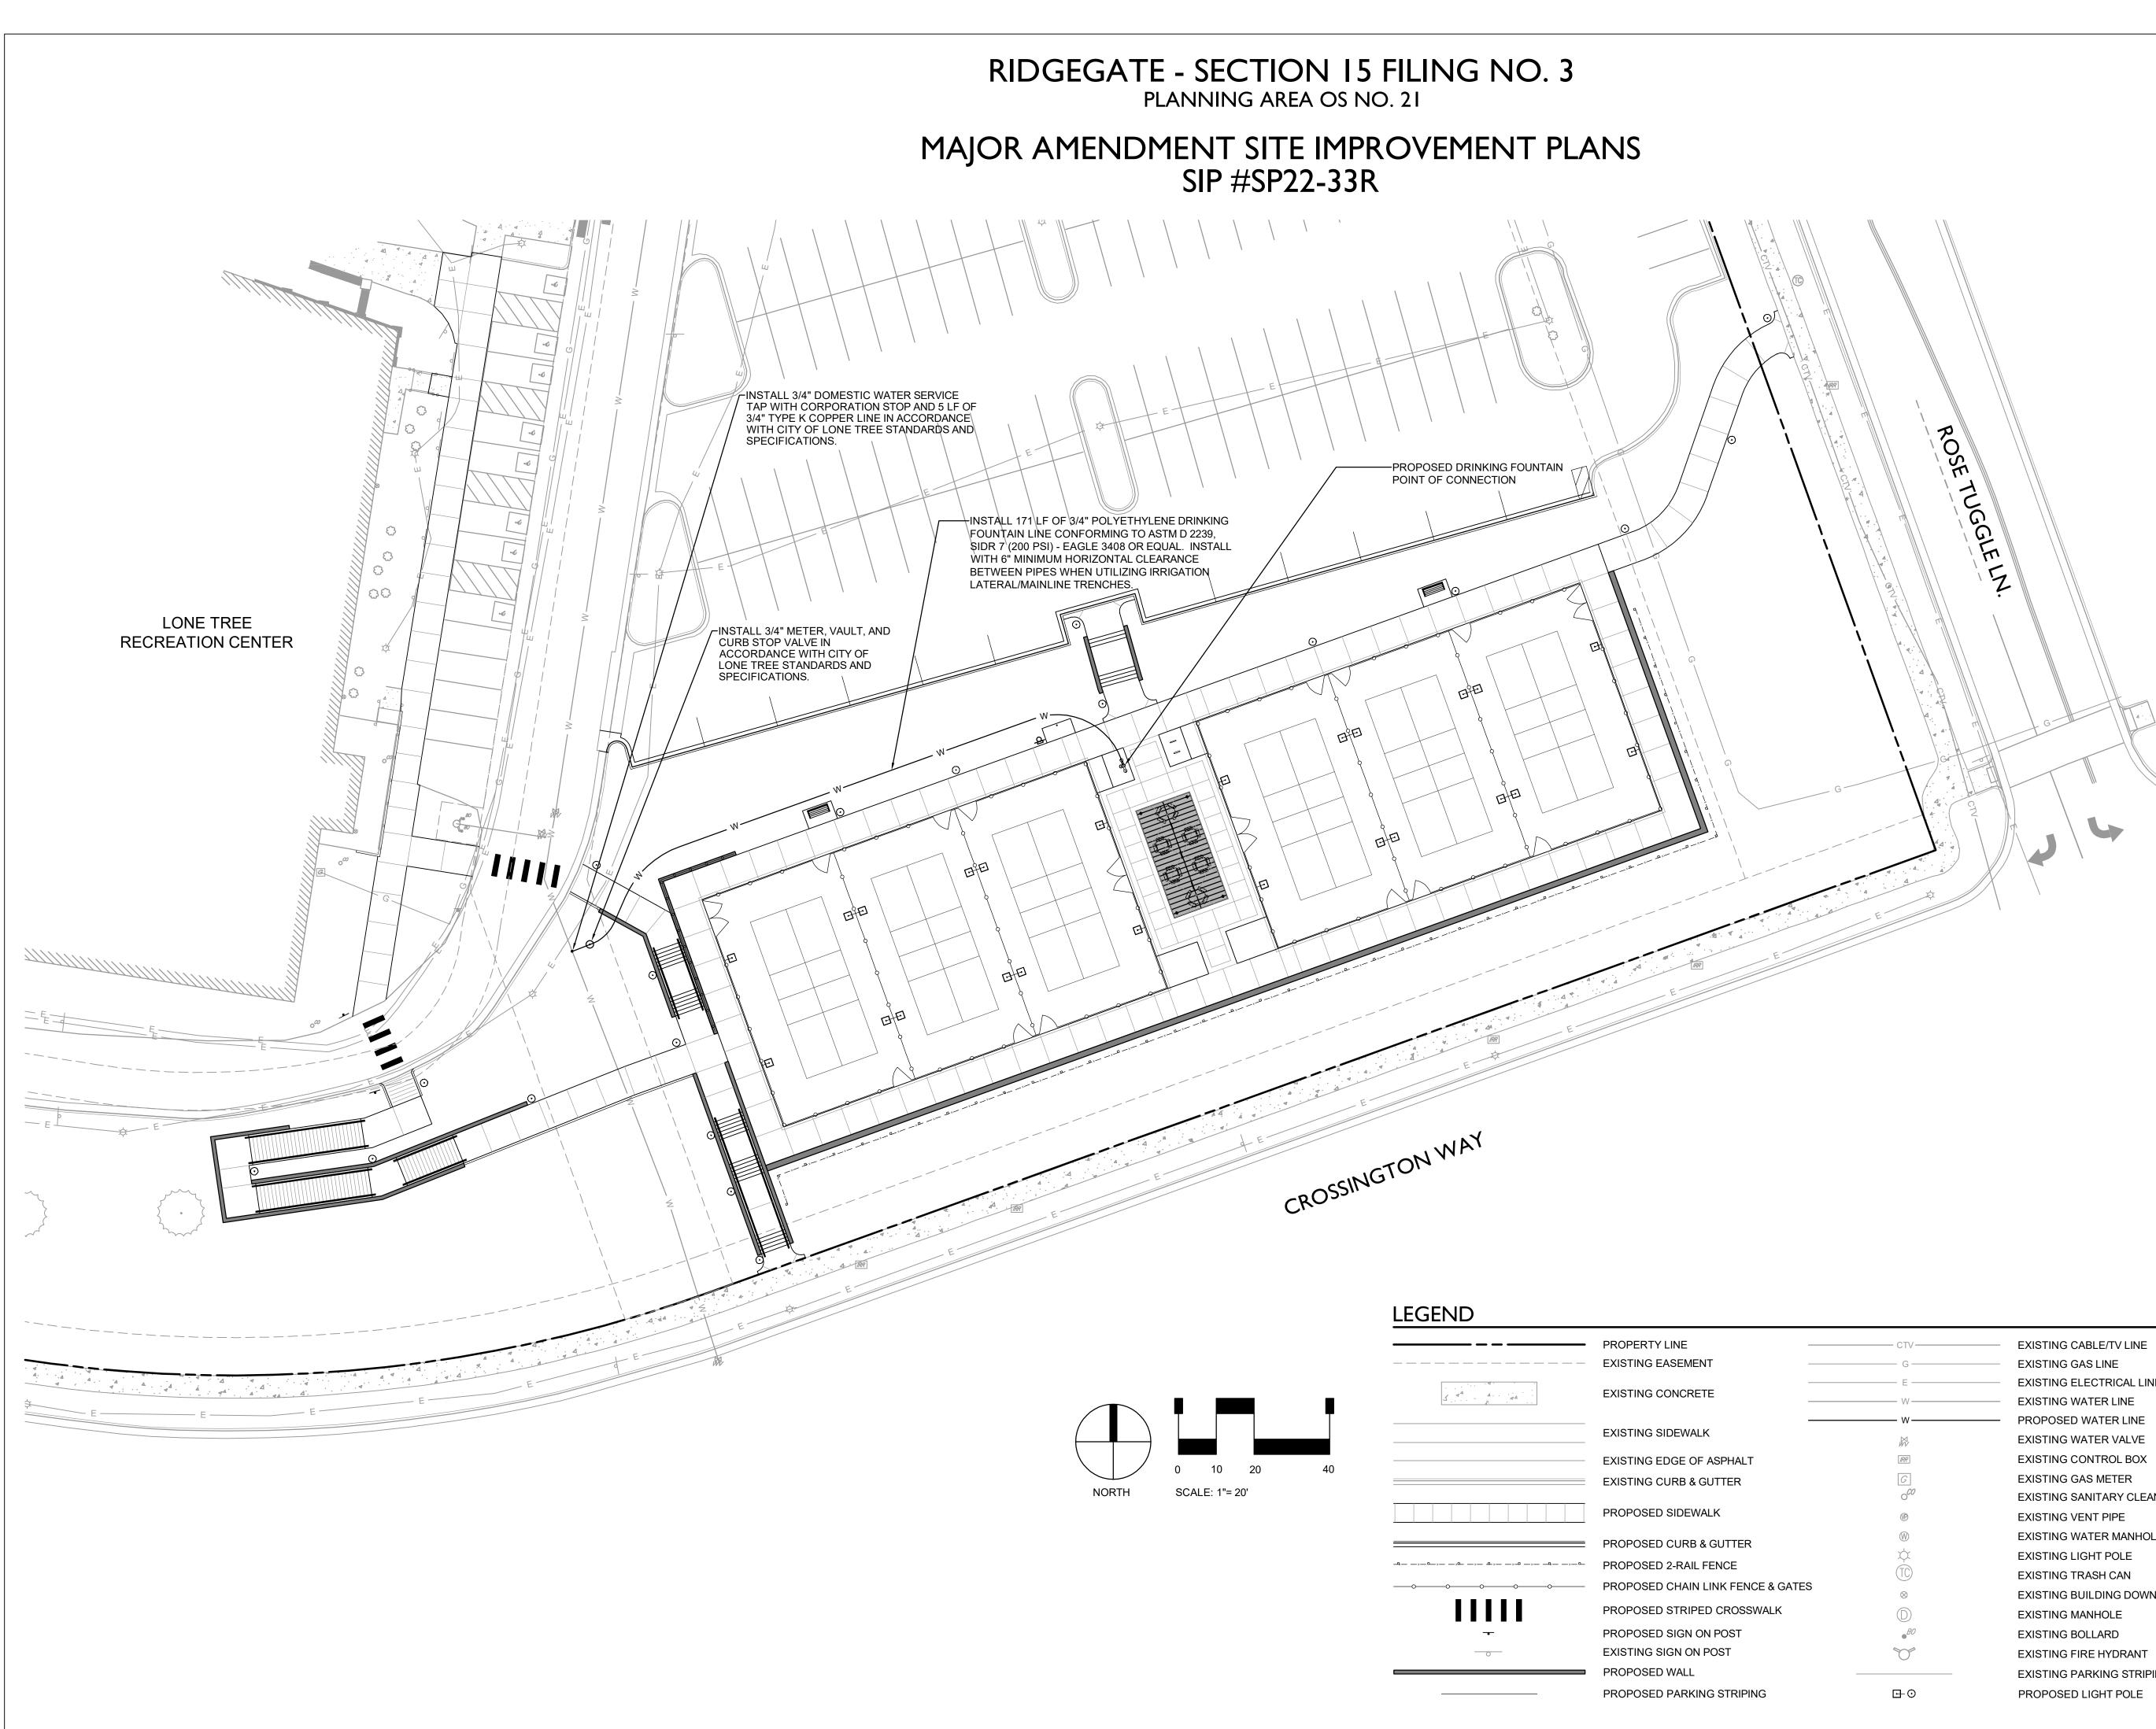

EXISTING ELECTRICAL LINE EXISTING SANITARY CLEANOUT EXISTING WATER MANHOLE EXISTING BUILDING DOWNSPOUT EXISTING PARKING STRIPING



PREPARED UNDER THE DIRECT SUPERVISION OF RYAN J. LOFTUS, PE COLORADO REGISTRATION NO. 48224 FOR & ON BEHALF OF STERLING DESIGN ASSOCIATES, LLC



STERLING DESIGN ASSOCIATES, LLC

ISSUES & I	REVISION	IS			
NO.: 1	DATE:	04/29/2022		BY:	JLW
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03/28/2022	1" = 20'
PROJECT MANAGER: JLW	PROJECT NO.:
DRAWN BY: RJL	DRAWING FILE:

PROJECT: LONE TREE RECREATION CENTER PICKLE BALL COURTS 10249 RIDGEGATE CIRCLE LONE TREE, CO 80124


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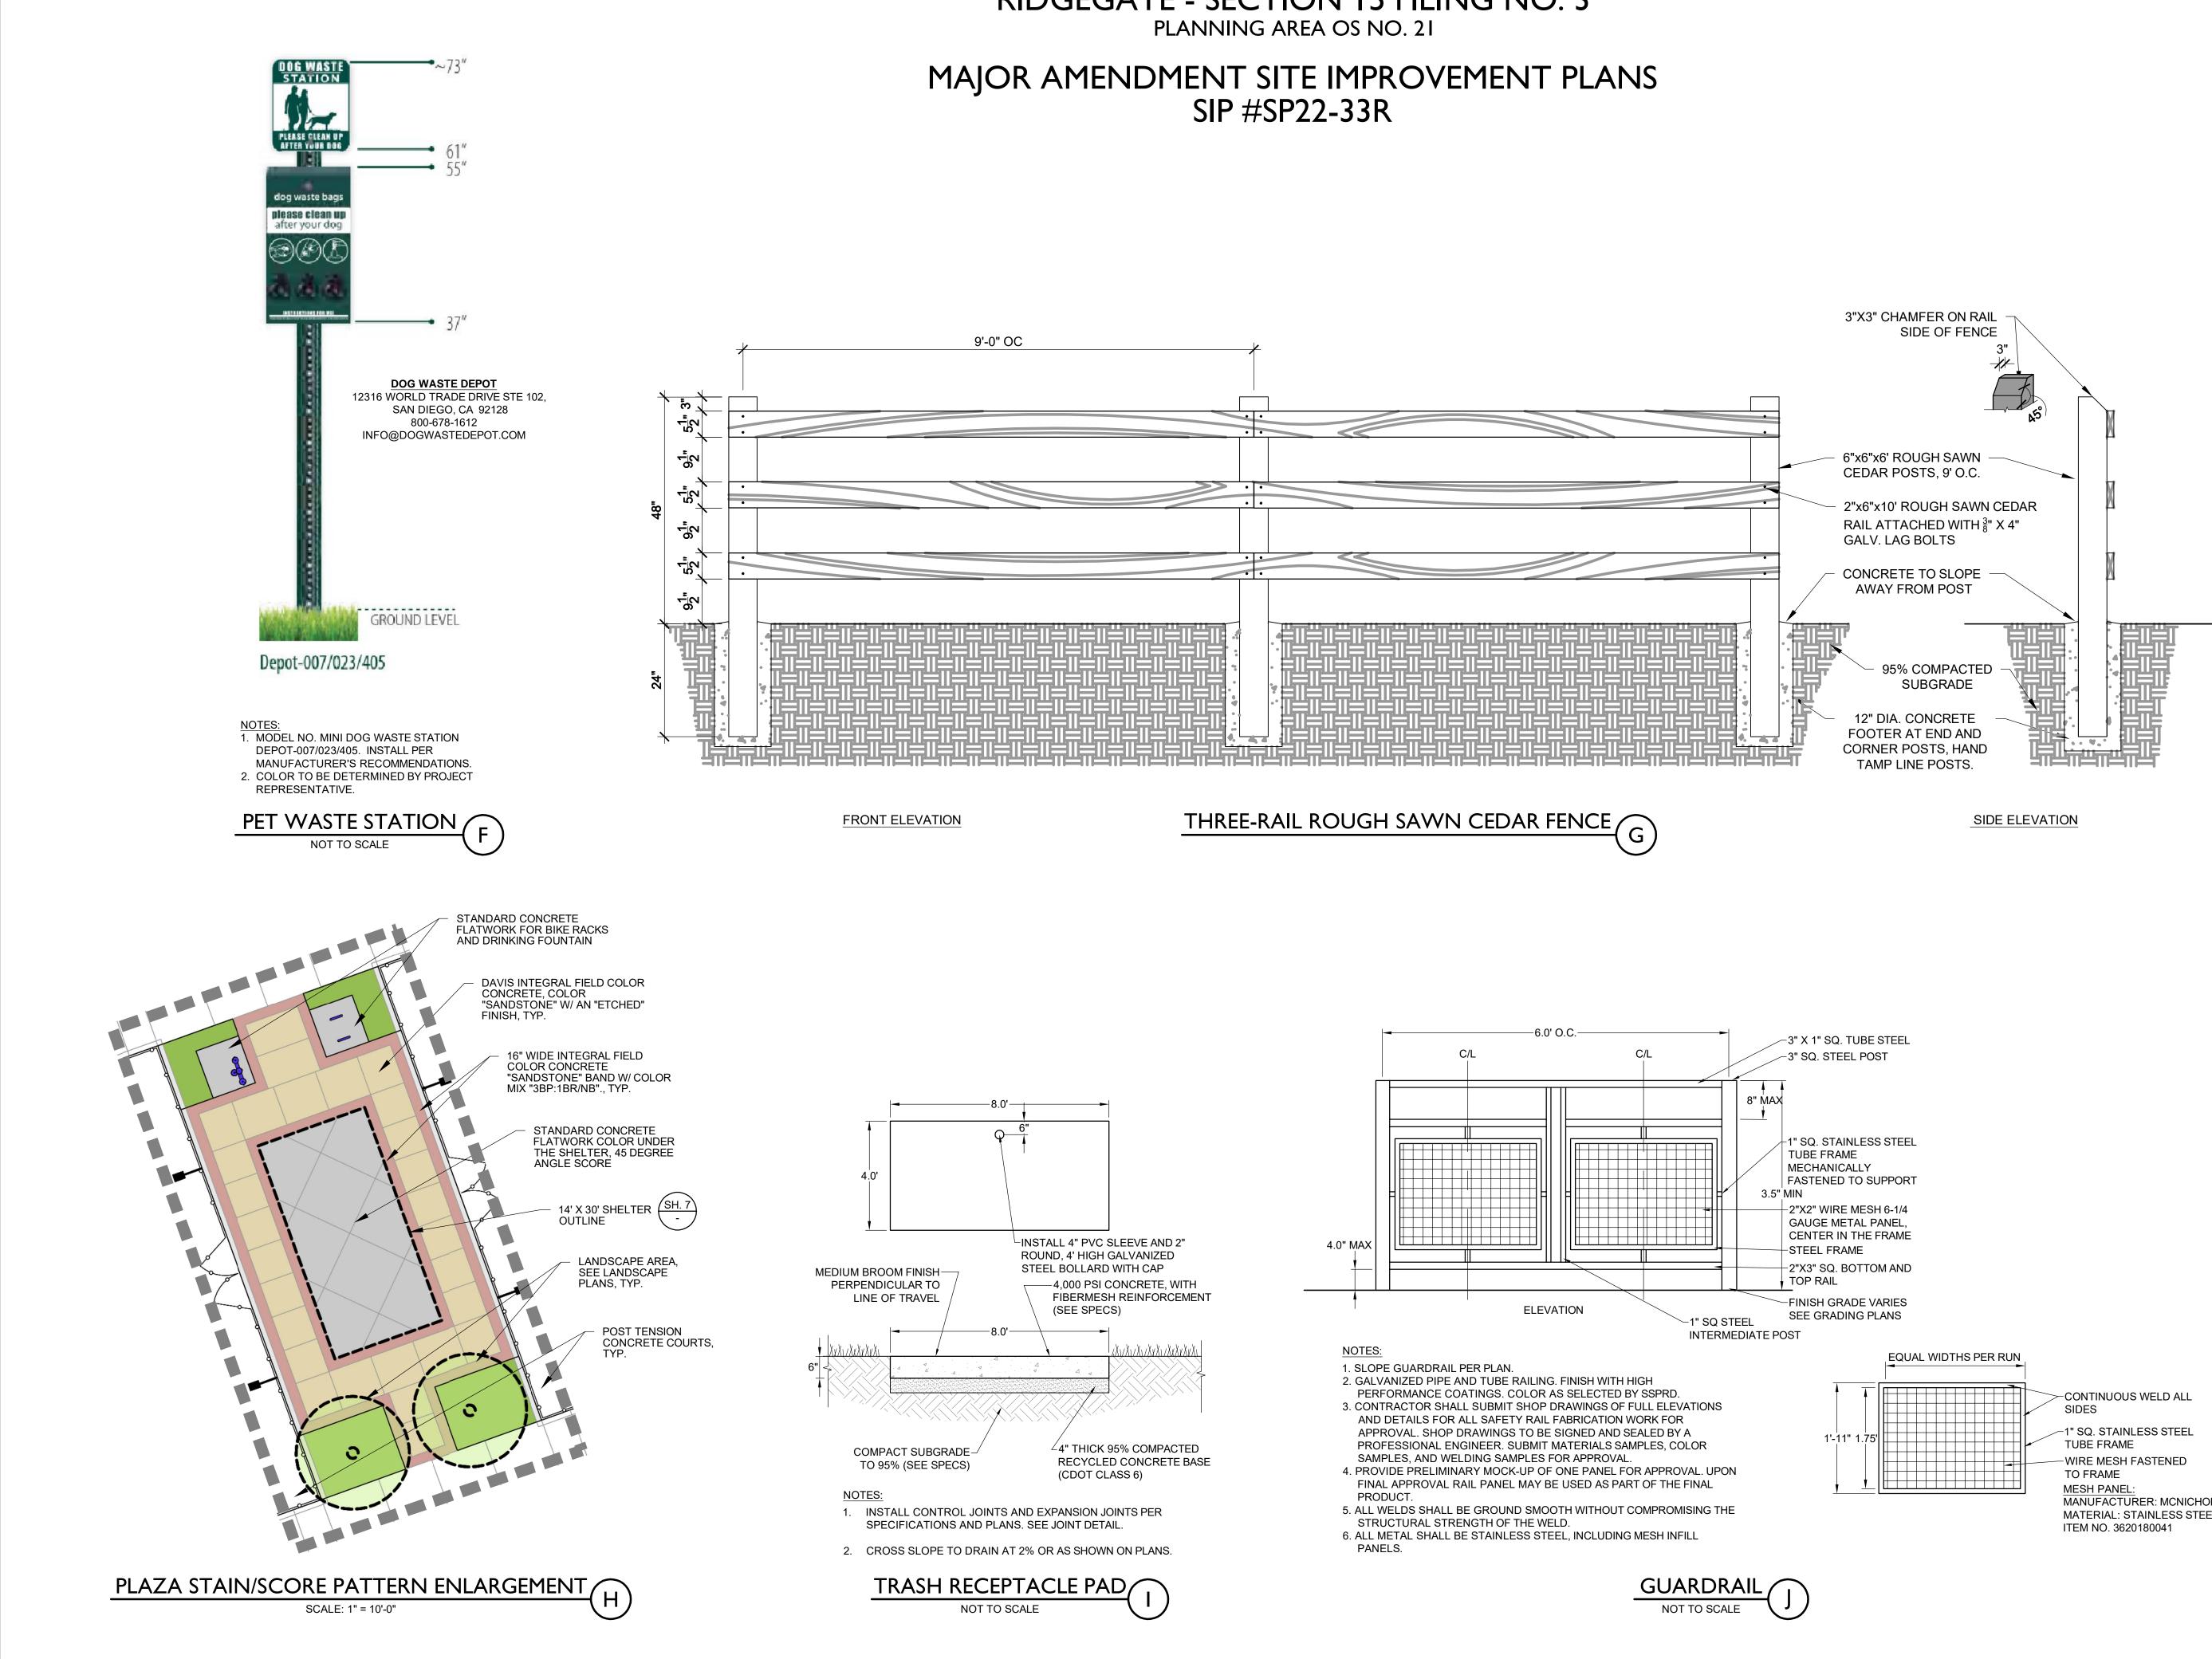
4810 E. COUNTY LINE RD. LITTLETON, CO 80126 TEL: (303) 798-5131

SHEET TITLE:

UTILITY PLAN

SHEET NUMBER:



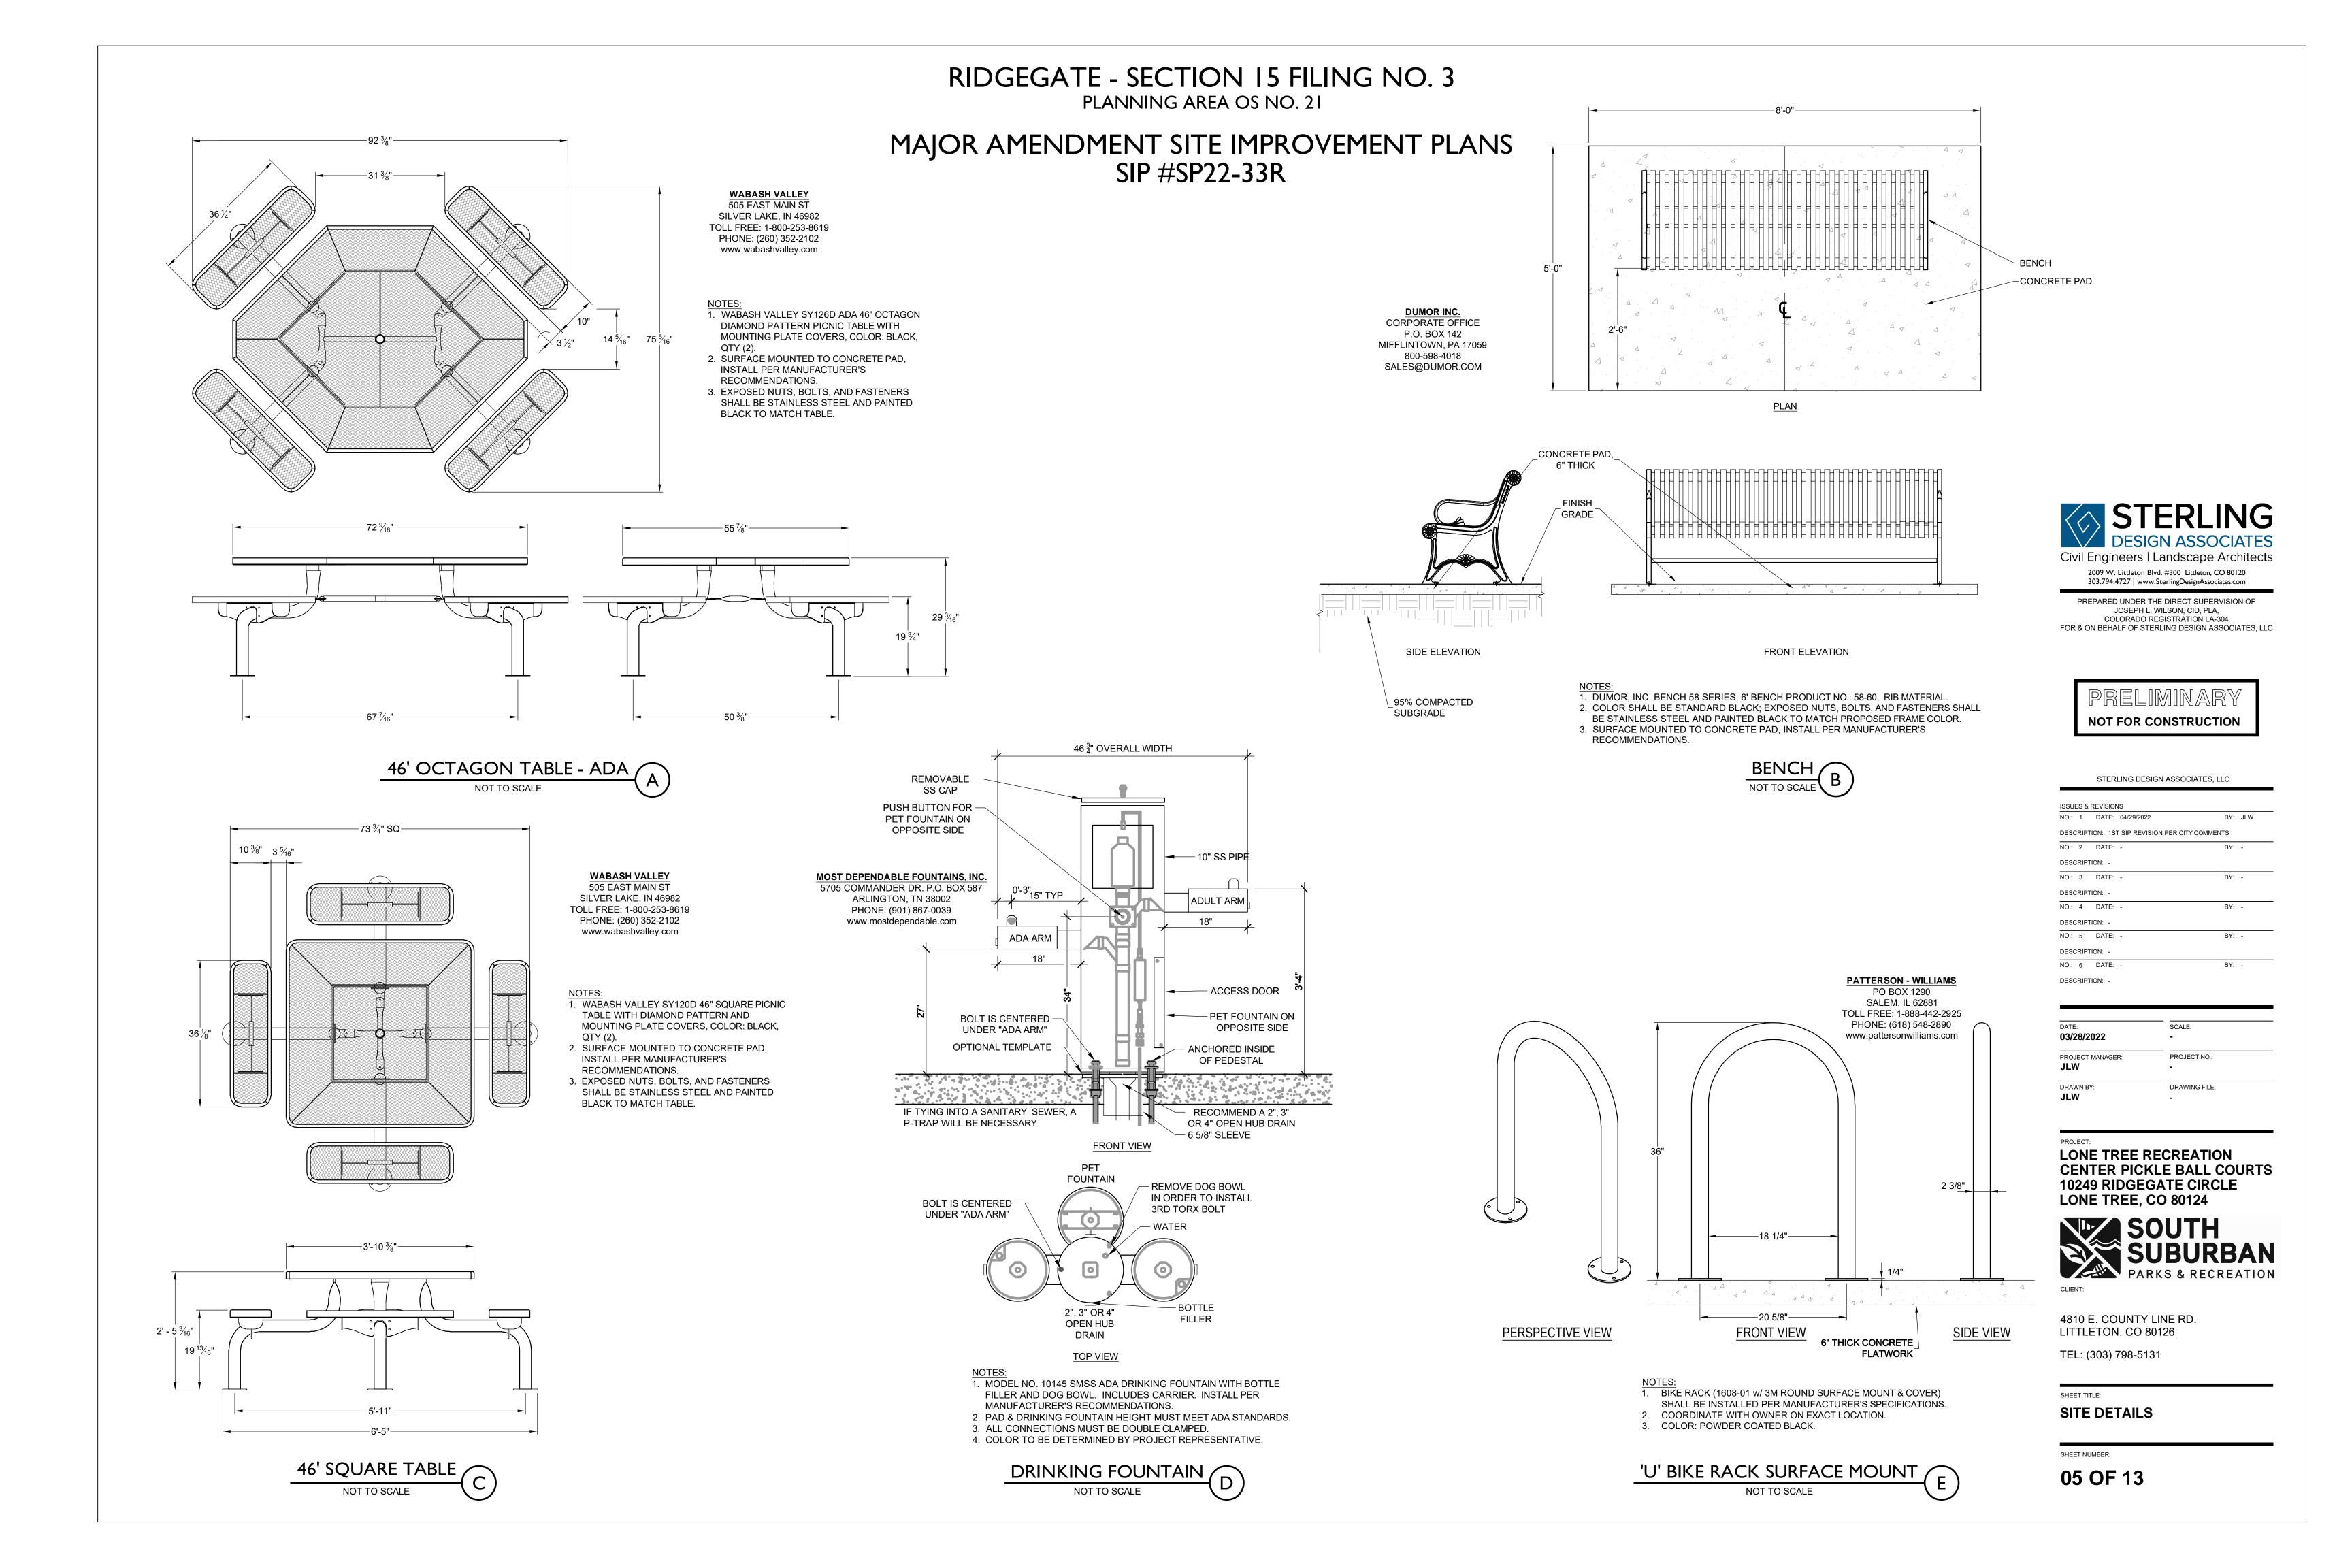

RIDGEGATE - SECTION 15 FILING NO. 3

MANUFACTURER: MCNICHOLS MATERIAL: STAINLESS STEEL,

STERLING DESIGN ASSOCIATES Civil Engineers | Landscape Architects

2009 W. Littleton Blvd. #300 Littleton, CO 80120 303.794.4727 | www.SterlingDesignAssociates.com PREPARED UNDER THE DIRECT SUPERVISION OF

JOSEPH L. WILSON, CID, PLA, COLORADO REGISTRATION LA-304 FOR & ON BEHALF OF STERLING DESIGN ASSOCIATES, LLC



STERLING DESIGN ASSOCIATES, LLC

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03/28/2022	-	
PROJECT MANAGER:	PROJECT NO.:	
JLW	-	
DRAWN BY:	DRAWING FILE:	
JLW	-	

PROJECT. LONE TREE RECREATION **CENTER PICKLE BALL COURTS** LONE TREE, CO 80124

10249 RIDGEGATE CIRCLE



4810 E. COUNTY LINE RD.

LITTLETON, CO 80126

TEL: (303) 798-5131

SITE DETAILS


06 OF 13

CLIENT

SHEET TITLE:

SHEET NUMBER:

SOUTH

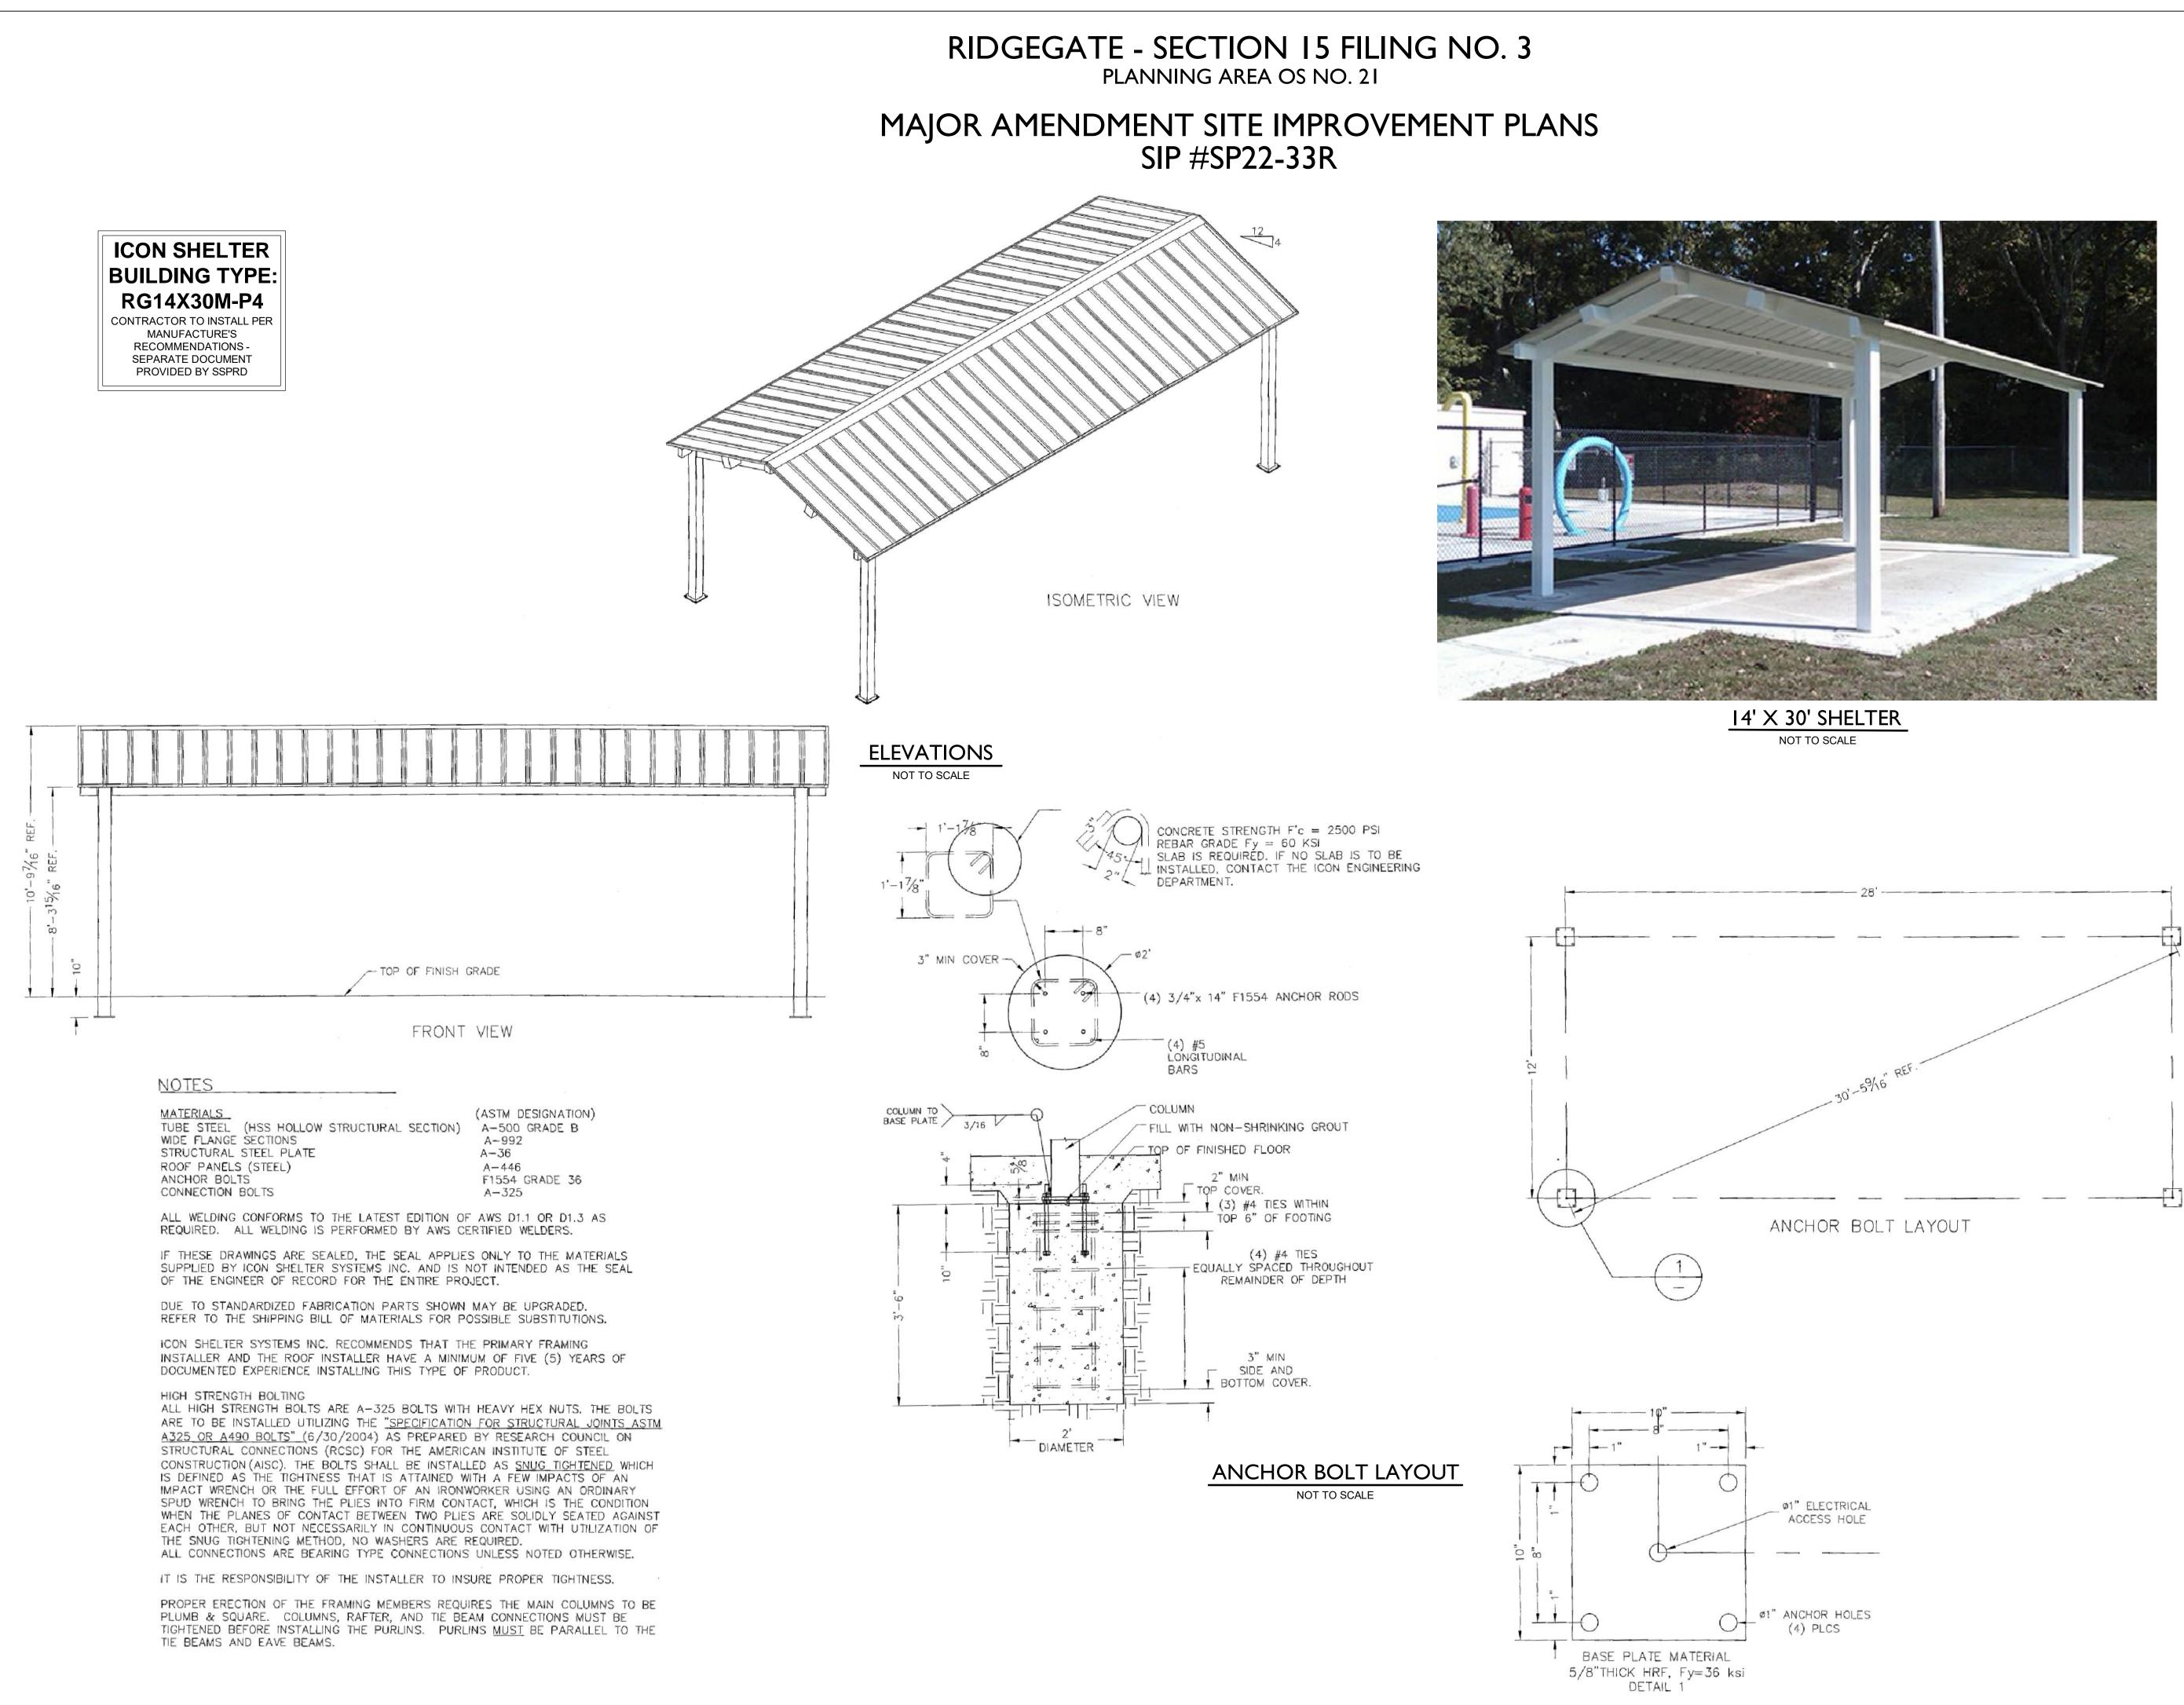



Shelter Systems Inc DISTINCTIVE STEEL SHELTERS WWW.ICONSHELTERS.COM COPYRIGHT 2004, ICON SHELTER SYSTEMS, INC.

> 1455 LINCOLN AVE. HOLLAND MI, 49423

> > 616.396.0919 800.748.0985 616.396.0944 FX

PRELIMINARY NOT FOR CONSTRUCTION

STERLING DESIGN ASSOCIATES, LLC

ISSUES & REVISIONS NO.: 1 DATE: 04/29/2022 BY: JLW DESCRIPTION: 1ST SIP REVISION PER CITY COMMENTS NO.: 2 DATE: BY: -DESCRIPTION: NO.: 3 DATE: BY: -DESCRIPTION: NO.: 4 DATE: BY: -DESCRIPTION: NO.: 5 DATE: BY: -DESCRIPTION: -NO.: 6 DATE: BY: -DESCRIPTION: SCALE: DATE: 03/28/2022 PROJECT MANAGER: PROJECT NO .:

JLW DRAWN BY: DRAWING FILE: JLW

PROJECT LONE TREE RECREATION **CENTER PICKLE BALL COURTS 10249 RIDGEGATE CIRCLE** LONE TREE, CO 80124






4810 E. COUNTY LINE RD. LITTLETON, CO 80126 TEL: (303) 798-5131

SHEET TITLE:

SHELTER DETAILS

SHEET NUMBER:

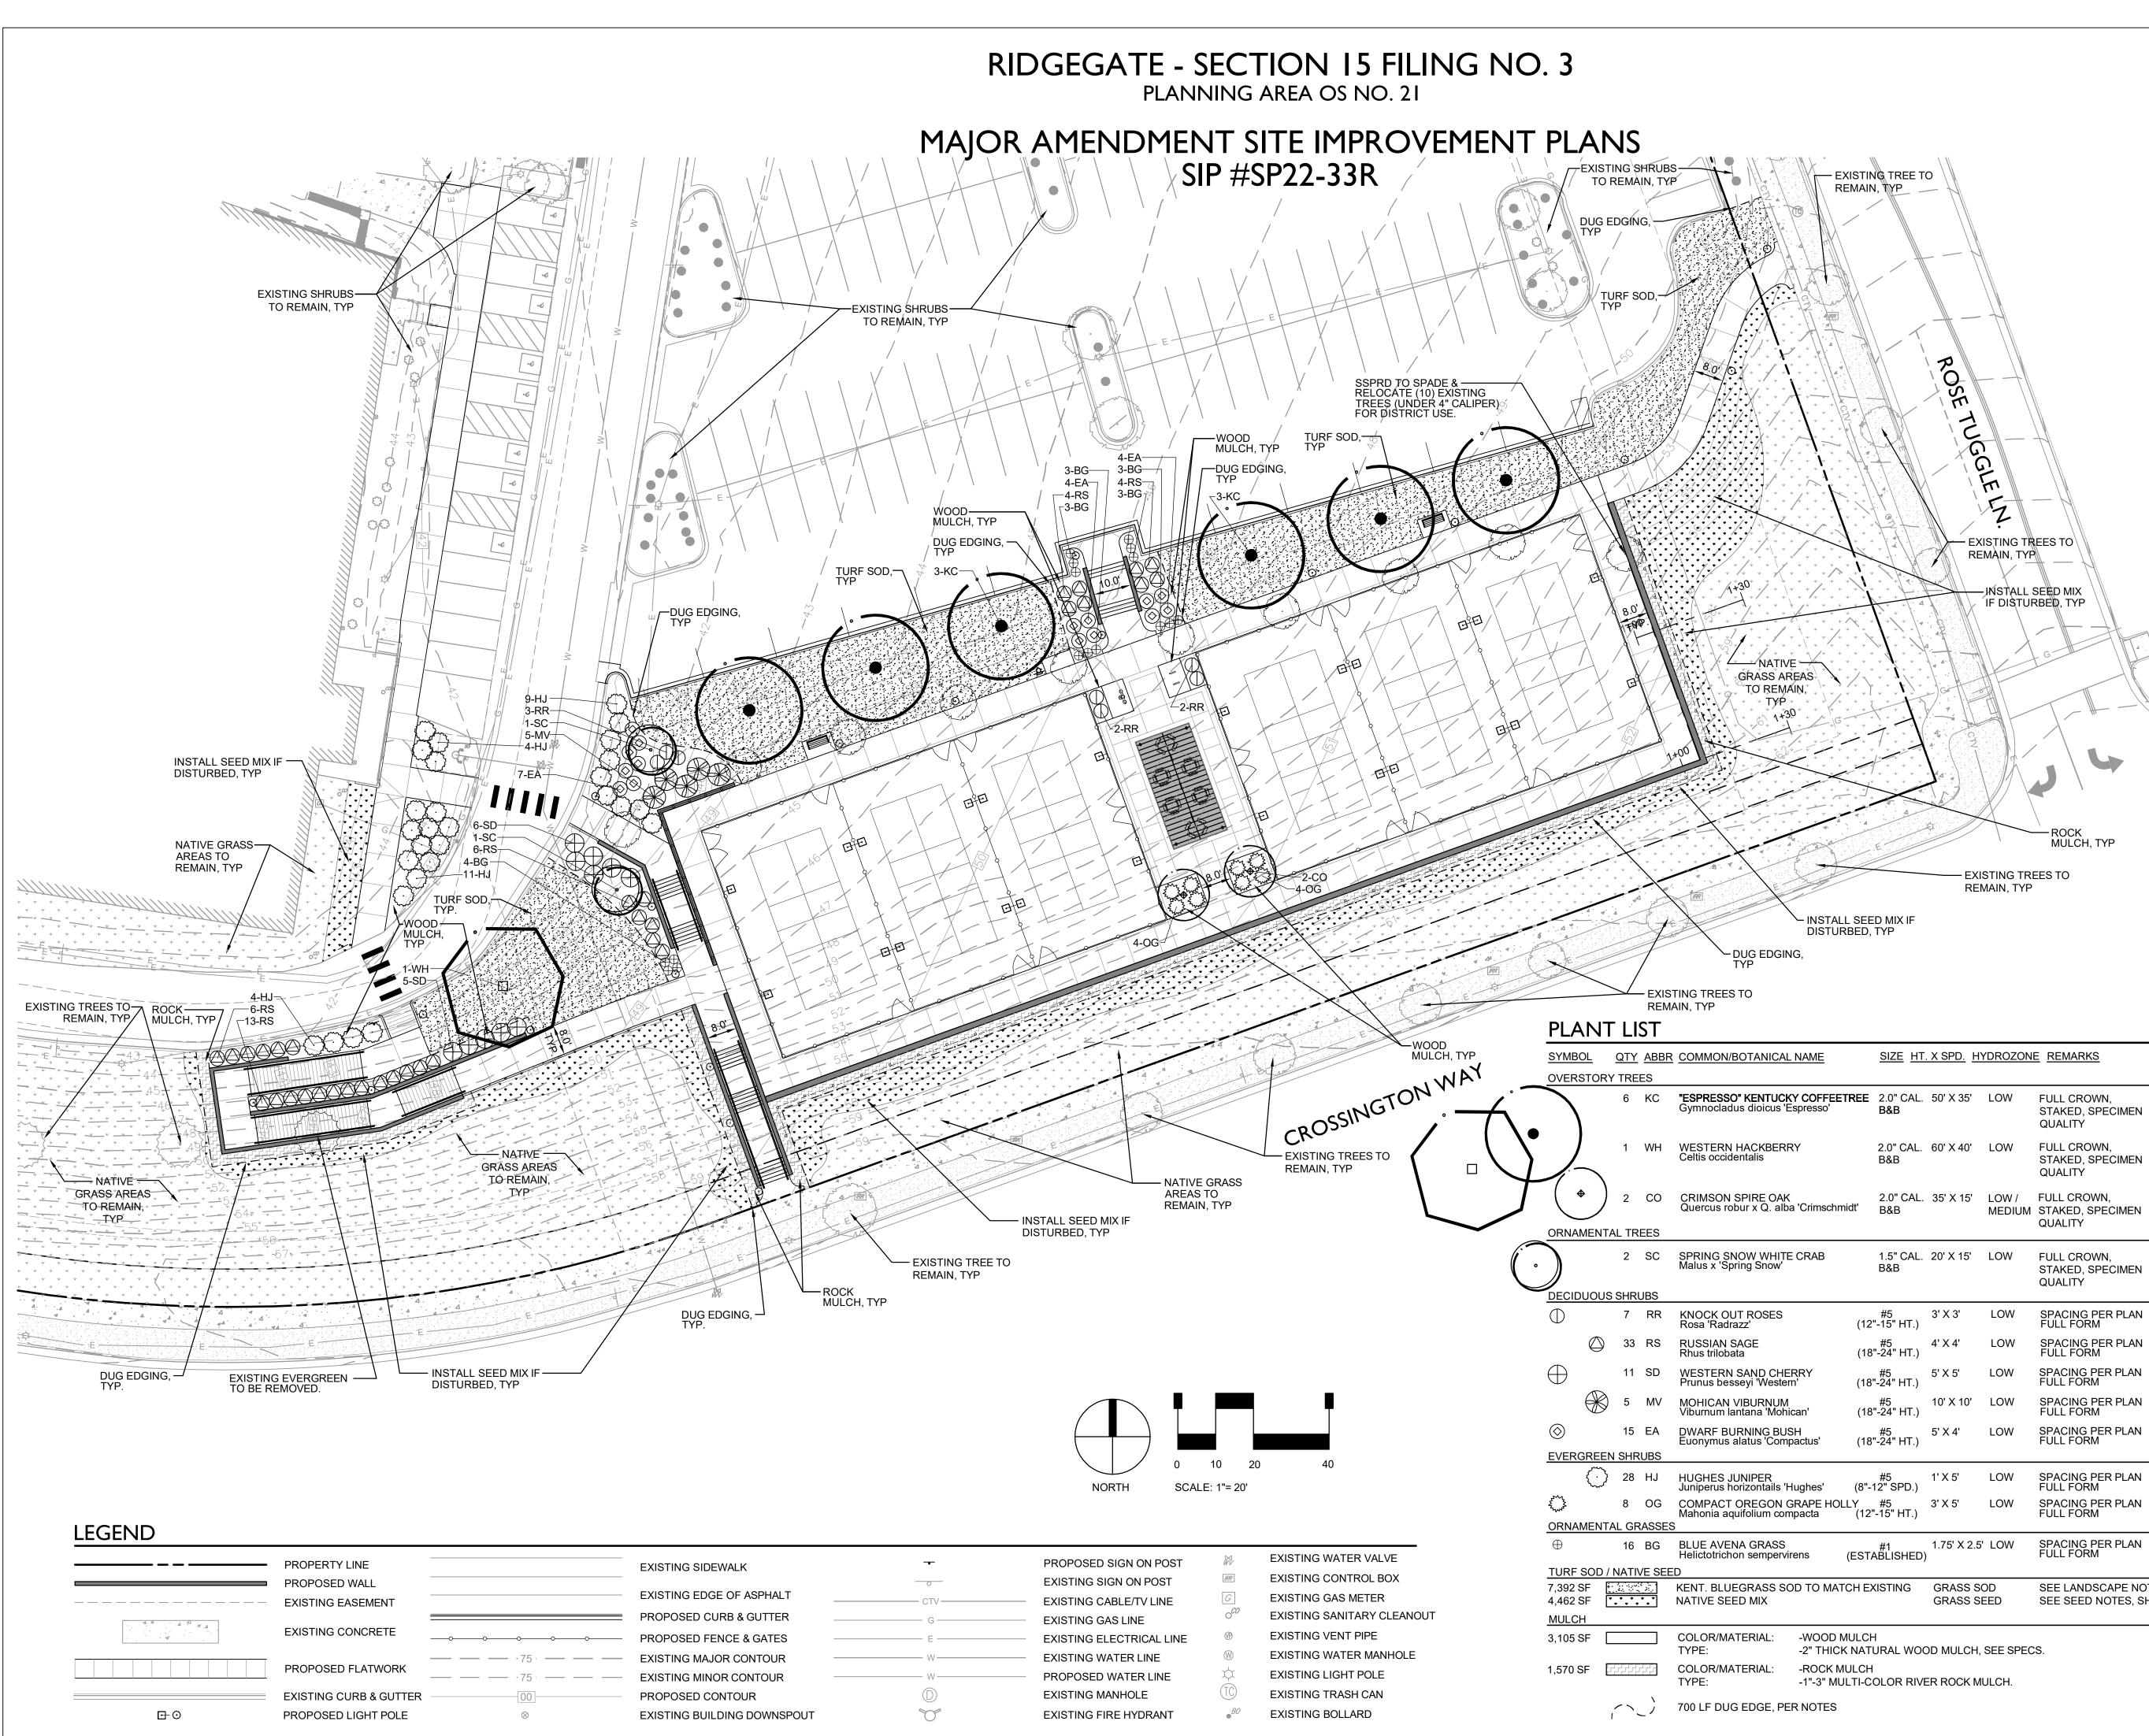

CAL NAME		<u>SIZE</u> <u>HT.</u>	<u>X SPD.</u> <u>HY</u>	DROZONI	E <u>REMARKS</u>
ICKY COFFEET s 'Espresso'	REE	2.0" CAL. B&B	50' X 35'	LOW	FULL CROWN, STAKED, SPECIMEN QUALITY
ERRY		2.0" CAL. B&B	60' X 40'	LOW	FULL CROWN, STAKED, SPECIMEN QUALITY
AK alba 'Crimschmi	dť	2.0" CAL. B&B	35' X 15'	LOW / MEDIUM	FULL CROWN, STAKED, SPECIMEN QUALITY
ITE CRAB v'		1.5" CAL. B&B	20' X 15'	LOW	FULL CROWN, STAKED, SPECIMEN QUALITY
S	(12"	#5 -15" HT.)	3' X 3'	LOW	SPACING PER PLAN FULL FORM
	(18"	#5 '-24" HT.)	4' X 4'	LOW	SPACING PER PLAN FULL FORM
HERRY stern'	(18"	#5 -24" HT.)	5' X 5'	LOW	SPACING PER PLAN FULL FORM
JM ohican'	(18"	#5 '-24" HT.)	10' X 10'	LOW	SPACING PER PLAN FULL FORM
BUSH ompactus'	(18"	#5 -24" HT.)	5' X 4'	LOW	SPACING PER PLAN FULL FORM
s 'Hughes'	(8"-1	#5 2" SPD.)	1' X 5'	LOW	SPACING PER PLAN FULL FORM
N GRAPE HOLI compacta	LY (12"	#5 -15" HT.)	3' X 5'	LOW	SPACING PER PLAN FULL FORM
SS ervirens	(ESTA	#1 \BLISHED)	1.75' X 2.5'	LOW	SPACING PER PLAN FULL FORM
SOD TO MAT	CH EX	ISTING	GRASS SC GRASS SE		SEE LANDSCAPE NOTES, SHEE SEE SEED NOTES, SHEET 9
-WOOD M -2" THICK			D MULCH, S	SEE SPEC	S.

	#5 (12"-15" HT.)	3' X 3'	LOW	SPACING PER PLAN FULL FORM
	#5 (18"-24" HT.)	4' X 4'	LOW	SPACING PER PLAN FULL FORM
Y	#5 (18"-24" HT.)	5' X 5'	LOW	SPACING PER PLAN FULL FORM
,	#5 (18"-24" HT.)	10' X 10'	LOW	SPACING PER PLAN FULL FORM
us'	#5 (18"-24" HT.)	5' X 4'	LOW	SPACING PER PLAN FULL FORM
nes'	#5 (8"-12" SPD.)	1' X 5'	LOW	SPACING PER PLAN FULL FORM
PE HOLI cta	-Y #5 (12"-15" HT.)	3' X 5'	LOW	SPACING PER PLAN FULL FORM
6 (#1 (ESTABLISHED)	1.75' X 2.5'	LOW	SPACING PER PLAN FULL FORM
ΓΟ ΜΑΤΟ	CHEXISTING	GRASS SC GRASS SE		SEE LANDSCAPE NOTES, SHEET 9 SEE SEED NOTES, SHEET 9

CLIENT

SHEET TITLE:

SHEET NUMBER:

08 OF 13

10249 RIDGEGATE CIRCLE LONE TREE, CO 80124

SOUTH

4810 E. COUNTY LINE RD.

LITTLETON, CO 80126

LANDSCAPE PLAN

TEL: (303) 798-5131

SUBURBAN

PARKS & RECREATION

DRAWN BY:	DRAWING FILE:
JLW	-
PROJECT:	
I ONE TREE	ERECREATION
CENTER PI	CKLE BALL COURTS

PROJECT NO .: PROJECT MANAGER: JLW

_____ ____

DATE: 03/28/2	022		SCALE: 1" = 20'	
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NO.: 6	DATE:	-		BY: -
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DESCRIPT	FION: -			
NO.: 3	DATE:	-		BY: -

STERLING

DESIGN ASSOCIATES

Civil Engineers | Landscape Architects

2009 W. Littleton Blvd. #300 Littleton, CO 80120 303.794.4727 | www.SterlingDesignAssociates.com

PREPARED UNDER THE DIRECT SUPERVISION OF

JOSEPH L. WILSON, CID, PLA,

COLORADO REGISTRATION LA-304 FOR & ON BEHALF OF STERLING DESIGN ASSOCIATES, LLC

PRELIMINARY

NOT FOR CONSTRUCTION

STERLING DESIGN ASSOCIATES, LLC

BY:


DESCRIPTION: 1ST SIP REVISION PER CITY COMMENTS

ISSUES & REVISIONS

NO.: 2 DATE:

NO.: 1 DATE: 04/29/2022

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2009 W. Littleton Blvd. #300 Littleton, CO 80120 303.794.4727 | www.SterlingDesignAssociates.com

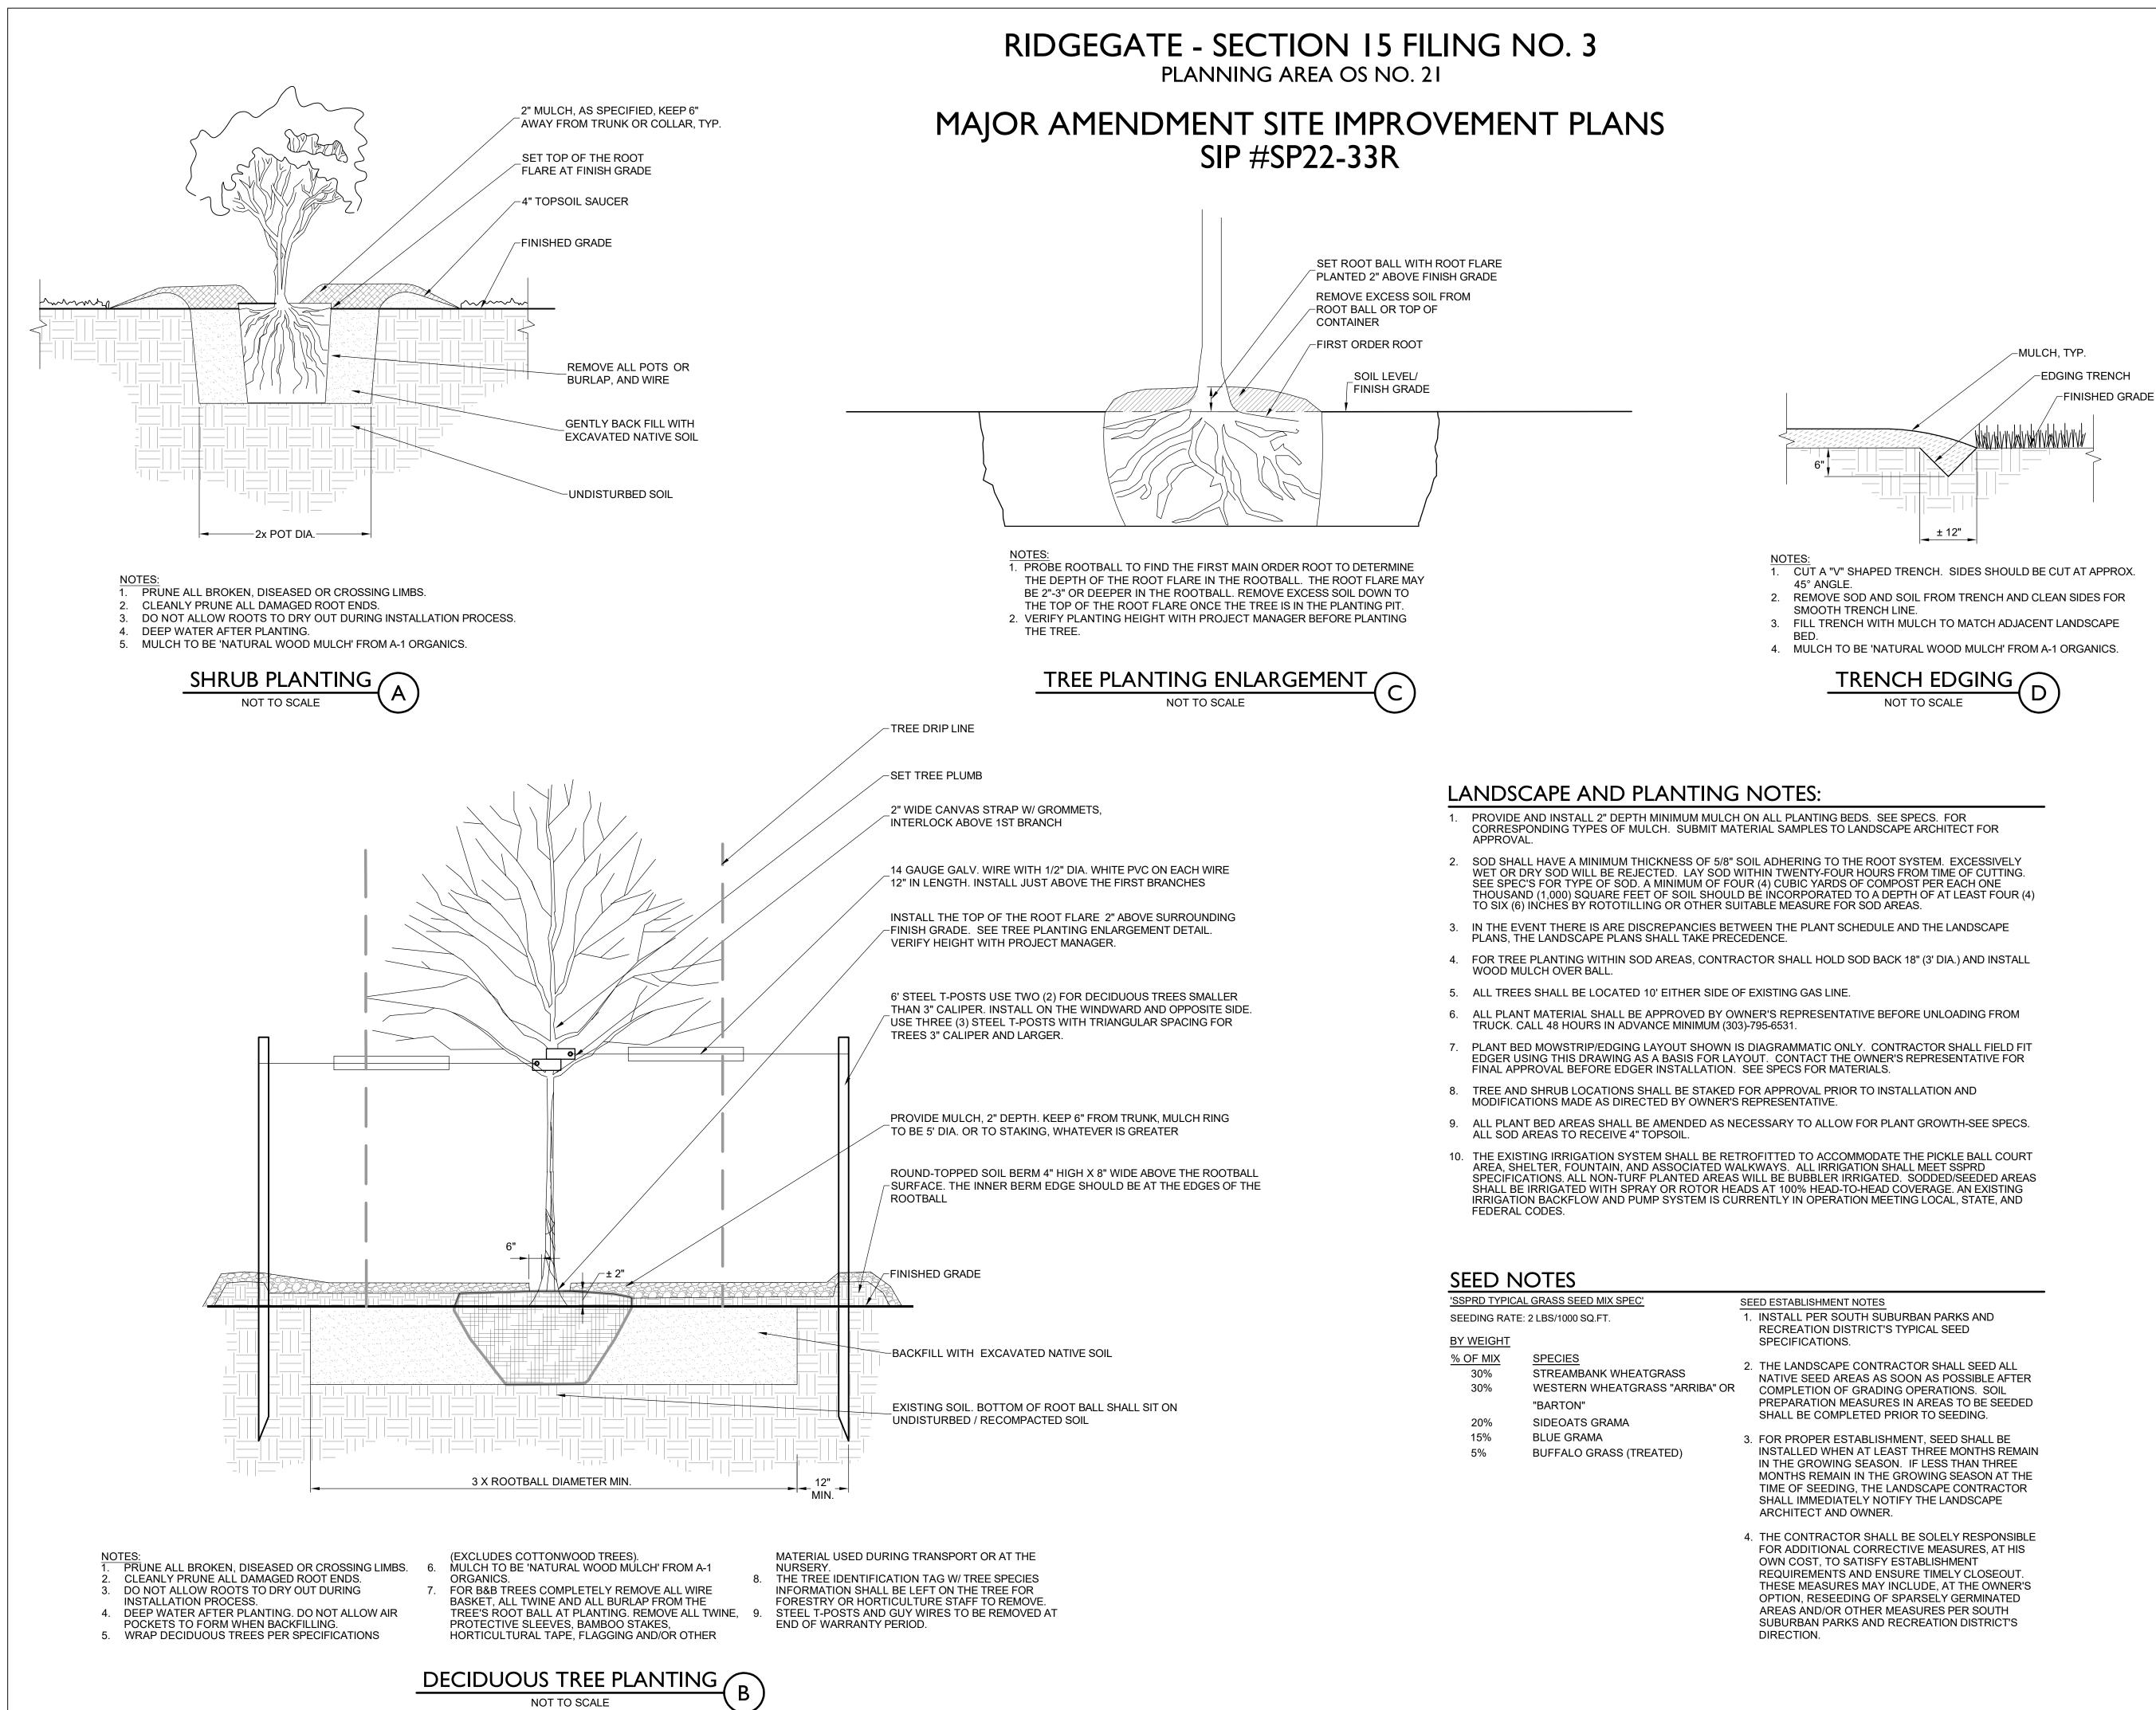PREPARED UNDER THE DIRECT SUPERVISION OF JOSEPH L. WILSON, CID, PLA, COLORADO REGISTRATION LA-304 FOR & ON BEHALF OF STERLING DESIGN ASSOCIATES, LLC



STERLING DESIGN ASSOCIATES, LLC

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DRAWN BY: JLW	DRAWING FILE:		

LONE TREE RECREATION **CENTER PICKLE BALL COURTS 10249 RIDGEGATE CIRCLE** LONE TREE, CO 80124




4810 E. COUNTY LINE RD. LITTLETON, CO 80126 TEL: (303) 798-5131

SHEET TITLE:

PROJECT

LANDSCAPE NOTES AND DETAILS

SHEET NUMBER:

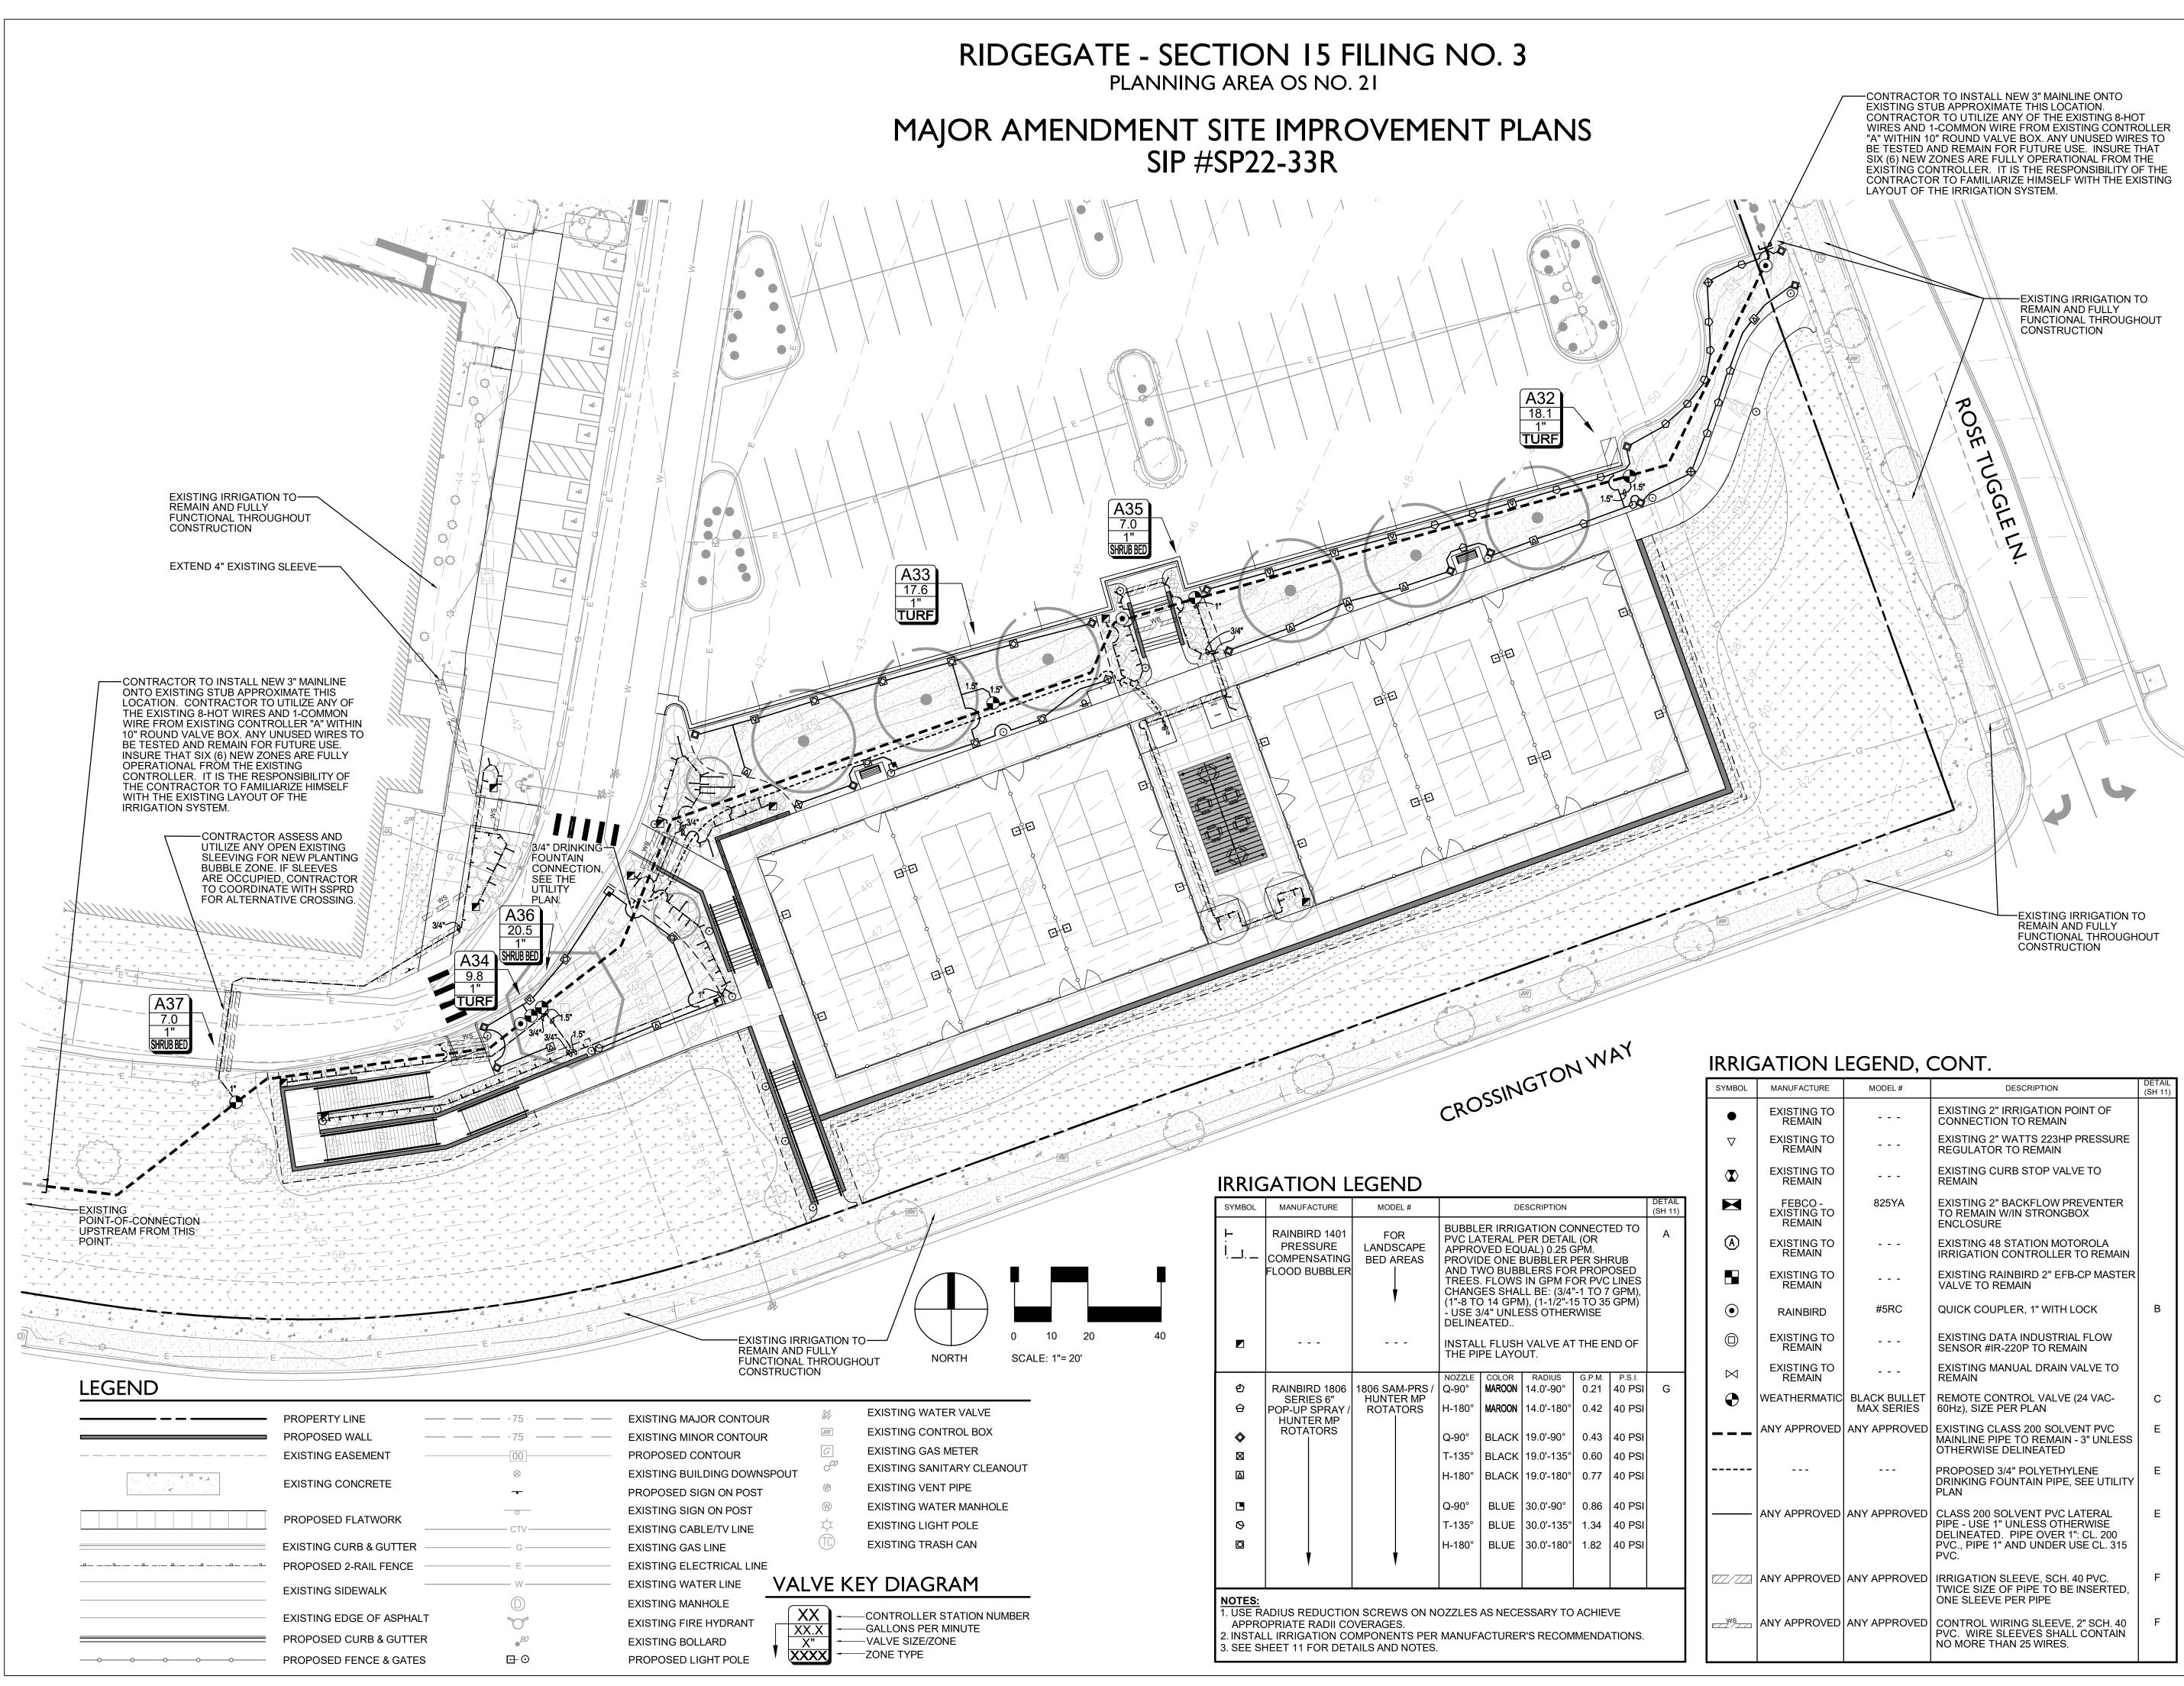

YMBOL	MANUFACTURE	MODEL #	DESCRIPTION	DETAIL (SH 11)
•	EXISTING TO REMAIN		EXISTING 2" IRRIGATION POINT OF CONNECTION TO REMAIN	
\bigtriangledown	EXISTING TO REMAIN		EXISTING 2" WATTS 223HP PRESSURE REGULATOR TO REMAIN	
	EXISTING TO REMAIN		EXISTING CURB STOP VALVE TO REMAIN	
	FEBCO - EXISTING TO REMAIN	825YA	EXISTING 2" BACKFLOW PREVENTER TO REMAIN W/IN STRONGBOX ENCLOSURE	
A	EXISTING TO REMAIN		EXISTING 48 STATION MOTOROLA IRRIGATION CONTROLLER TO REMAIN	
	EXISTING TO REMAIN		EXISTING RAINBIRD 2" EFB-CP MASTER VALVE TO REMAIN	
ullet	RAINBIRD	#5RC	QUICK COUPLER, 1" WITH LOCK	В
	EXISTING TO REMAIN		EXISTING DATA INDUSTRIAL FLOW SENSOR #IR-220P TO REMAIN	
\bowtie	EXISTING TO REMAIN		EXISTING MANUAL DRAIN VALVE TO REMAIN	
Ð	WEATHERMATIC	BLACK BULLET MAX SERIES	REMOTE CONTROL VALVE (24 VAC- 60Hz), SIZE PER PLAN	С
	ANY APPROVED	ANY APPROVED	EXISTING CLASS 200 SOLVENT PVC MAINLINE PIPE TO REMAIN - 3" UNLESS OTHERWISE DELINEATED	E
			PROPOSED 3/4" POLYETHYLENE DRINKING FOUNTAIN PIPE, SEE UTILITY PLAN	E
	ANY APPROVED	ANY APPROVED	CLASS 200 SOLVENT PVC LATERAL PIPE - USE 1" UNLESS OTHERWISE DELINEATED. PIPE OVER 1": CL. 200 PVC., PIPE 1" AND UNDER USE CL. 315 PVC.	E
Z/7Z2	ANY APPROVED	ANY APPROVED	IRRIGATION SLEEVE, SCH. 40 PVC. TWICE SIZE OF PIPE TO BE INSERTED, ONE SLEEVE PER PIPE	F
WS Z/ZZ	ANY APPROVED	ANY APPROVED	CONTROL WIRING SLEEVE, 2" SCH. 40 PVC. WIRE SLEEVES SHALL CONTAIN NO MORE THAN 25 WIRES.	F



PREPARED UNDER THE DIRECT SUPERVISION OF JOSEPH L. WILSON, CID, PLA, COLORADO REGISTRATION LA-304 FOR & ON BEHALF OF STERLING DESIGN ASSOCIATES, LLC



STERLING DESIGN ASSOCIATES, LLC

NO.: 1	DATE: 04/29/2022	BY: JLW				
DESCRIP	TION: 1ST SIP REVISION PER CI	TY COMMENTS				
NO.: 2	DATE: -	BY: -				
DESCRIP	ΓΙΟΝ: -					
NO.: 3	DATE: -	BY: -				
DESCRIPTION: -						
NO.: 4	DATE: -	BY: -				
DESCRIP	ΓΙΟΝ: -					
NO.: 5	DATE: -	BY: -				
DESCRIPTION: -						
NO.: 6	DATE: -	BY: -				
DESCRIPTION: -						

DATE: 03/28/2022	scale: 1" = 20'
PROJECT MANAGER:	PROJECT NO.:
DRAWN BY: JLW	DRAWING FILE:

LONE TREE RECREATION **CENTER PICKLE BALL COURTS 10249 RIDGEGATE CIRCLE** LONE TREE, CO 80124




4810 E. COUNTY LINE RD. LITTLETON, CO 80126 TEL: (303) 798-5131

SHEET TITLE:

PROJECT

IRRIGATION PLAN

SHEET NUMBER:

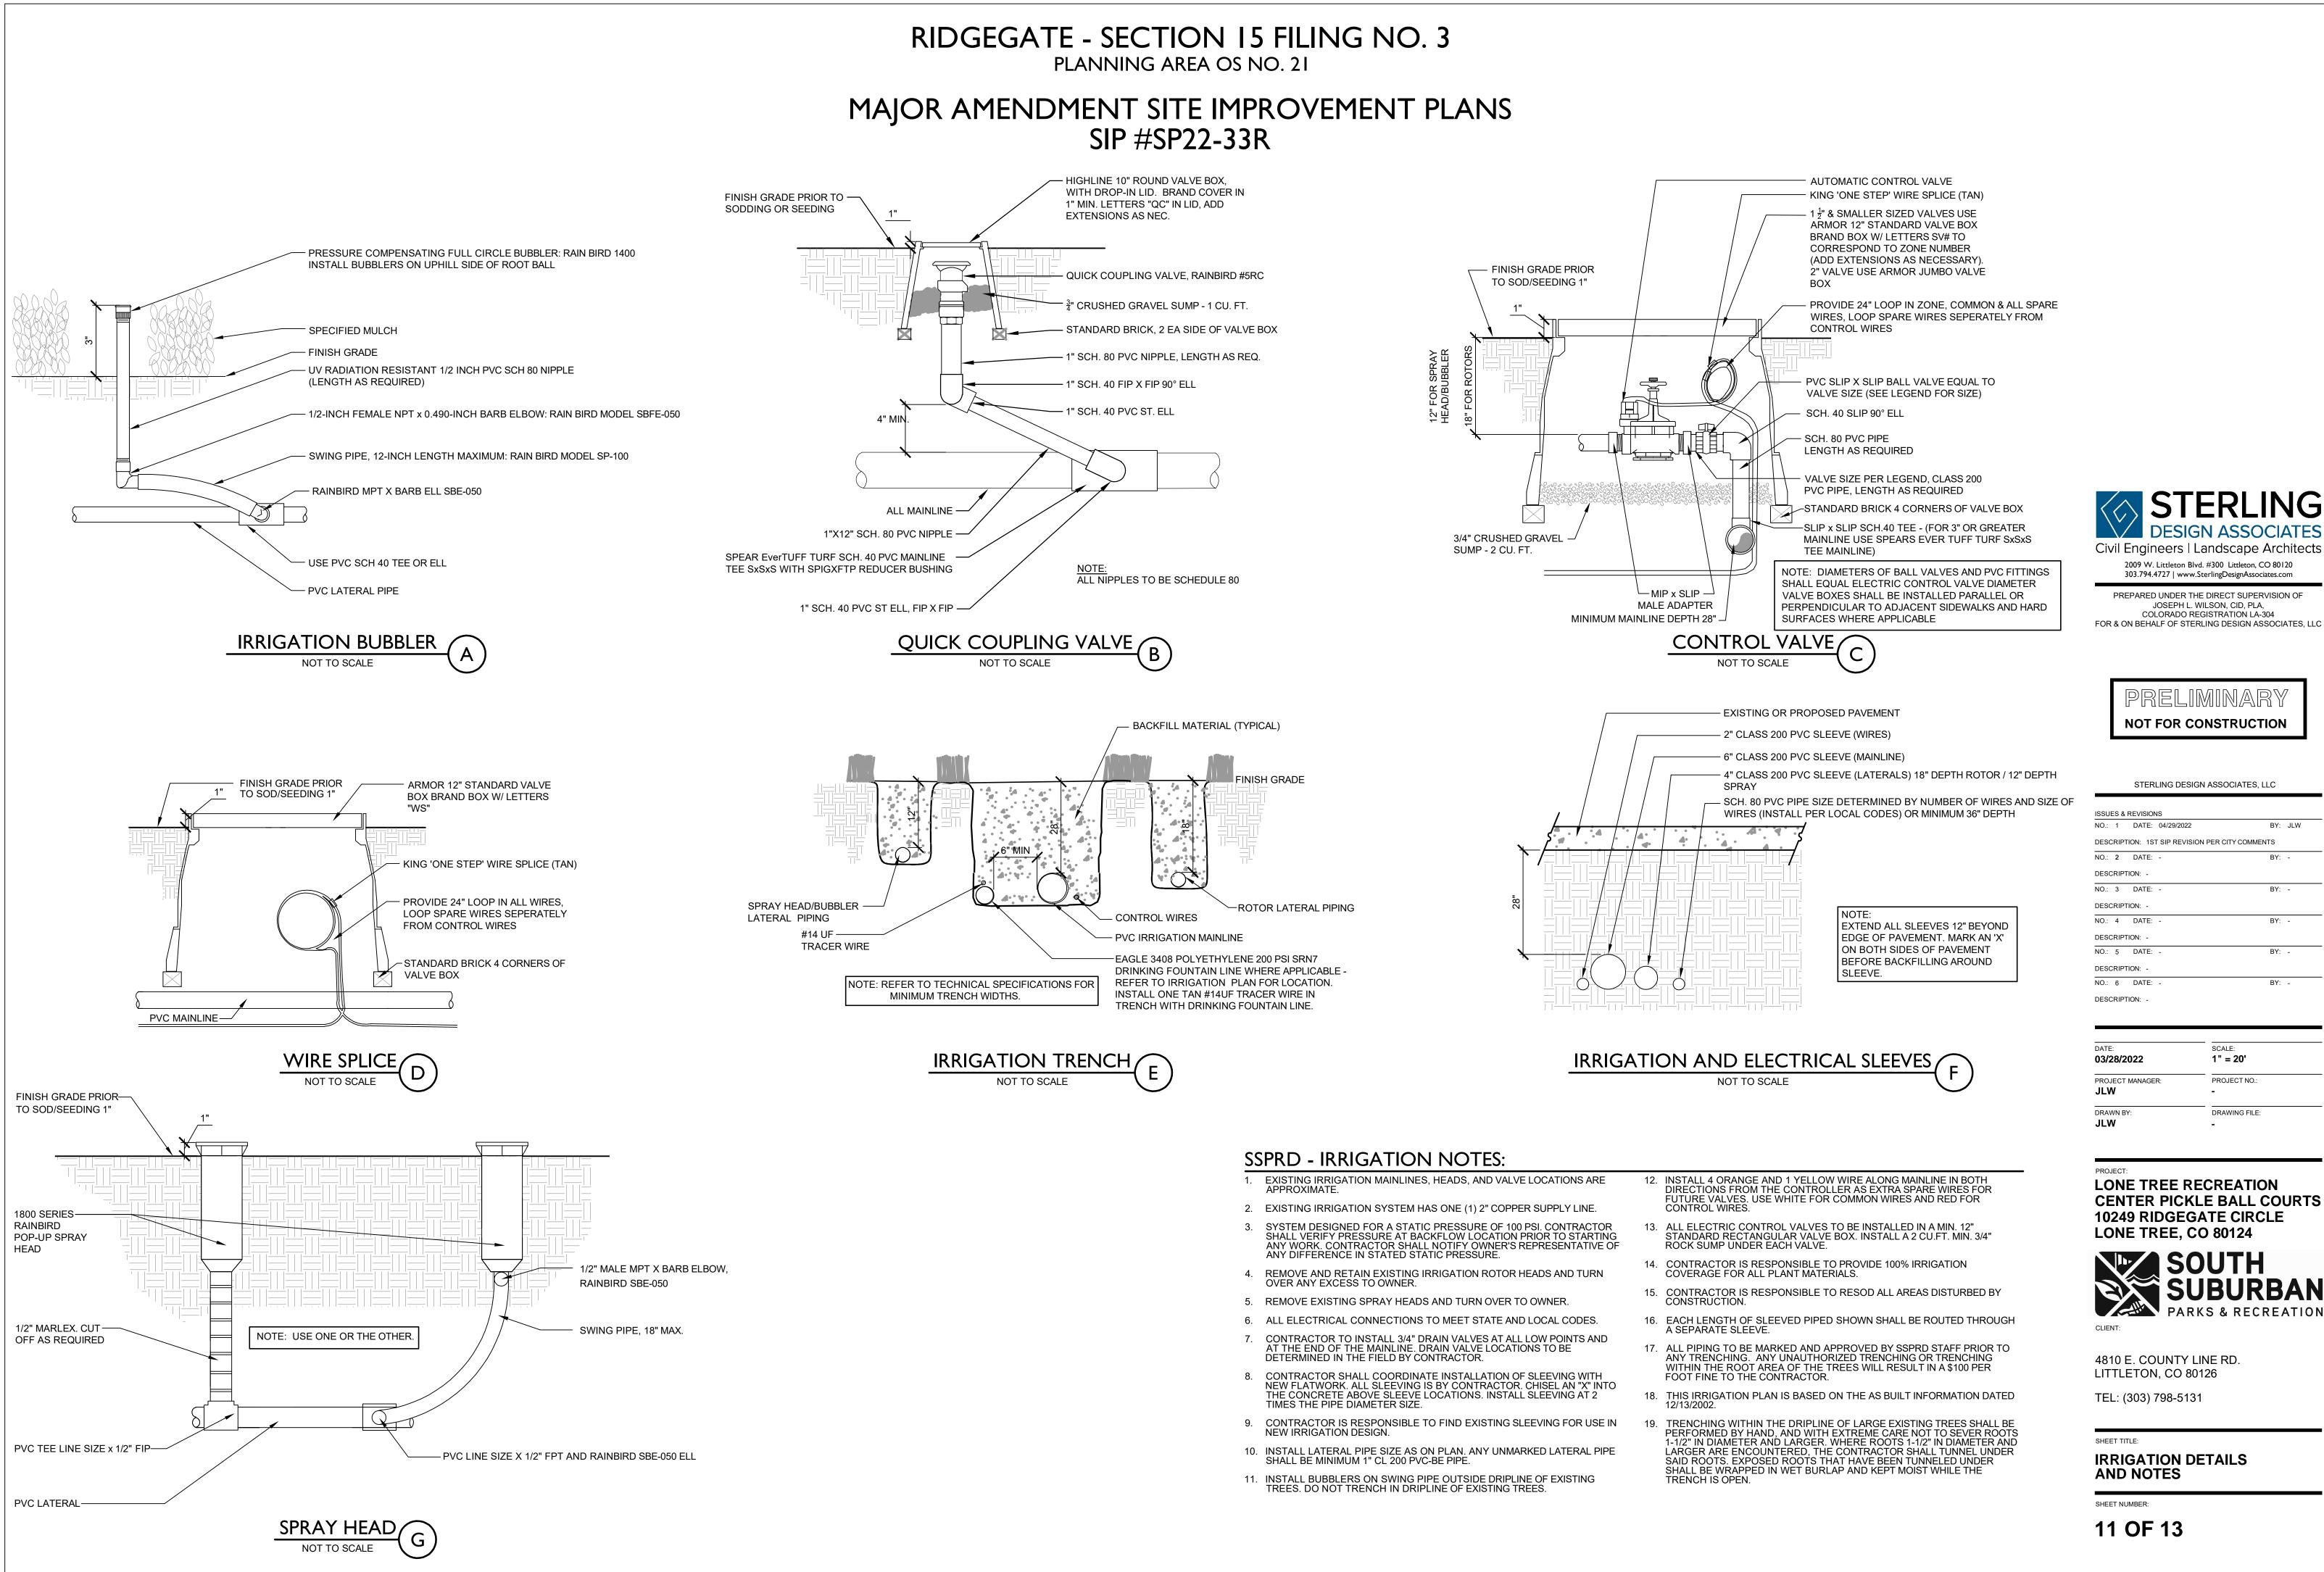

BY: JLW


BY:

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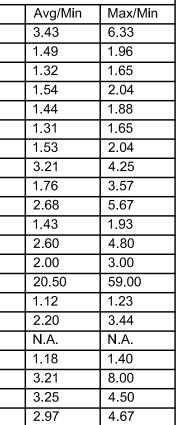
Calculation Summary					
Label	CalcType	Units	Avg	Max	Min
CENTER COURT PLAZA	Illuminance	Fc	10.28	19	3
COURT 1	Illuminance	Fc	37.18	49	25
COURT 2	Illuminance	Fc	40.82	51	31
COURT 3	Illuminance	Fc	36.86	49	24
COURT 4	Illuminance	Fc	37.46	49	26
COURT 5	Illuminance	Fc	40.71	51	31
COURT 6	Illuminance	Fc	36.82	49	24
EAST COURT SIDEWALKS	Illuminance	Fc	12.84	17	4
EAST SIDEWALK	Illuminance	Fc	1.23	2.5	0.7
LOWER WEST RAMP	Illuminance	Fc	1.61	3.4	0.6
MID SOUTH STAIRS	Illuminance	Fc	2.00	2.7	1.4
MIDDLE WEST RAMP	Illuminance	Fc	1.30	2.4	0.5
NORTH CENTRAL STAIRS	Illuminance	Fc	2.00	3	1
NORTH SITE AREA	Illuminance	Fc	2.05	5.9	0.1
NORTH SOUTH STAIRS	Illuminance	Fc	3.35	3.7	3.0
NORTH WEST STAIRS	Illuminance	Fc	1.98	3.1	0.9
SOUTH SITE AREA	Illuminance	Fc	0.16	0.8	0.0
UPPER SOUTH STAIRS	Illuminance	Fc	1.18	1.4	1.0
UPPER WEST RAMP	Illuminance	Fc	2.25	5.6	0.7
WEST COURT SIDEWALK	Illuminance	Fc	13.00	18	4
WEST STAIR ENTRY	Illuminance	Fc	2.67	4.2	0.9

RIDGEGATE - SECTION 15 FILING NO. 3 PLANNING AREA OS NO. 21

MAJOR AMENDMENT SITE IMPROVEMENT PLANS SIP #SP22-XX


elivered	Driver &					Specification		Max Input	:
umens	Dimming	Description	Finish	Mount	Manufacturer	Catalog Number	Volt	Wattage	Notes
2304	INTEGRAL	26.1" X 4.3" X 2.7" TALL LED WITH	TOBE	SURFACE	LUMINAIRE LED	VPF4-2FT-MIN10-20W-40K-	120	21	
	DRIVER		DETERMINED			120-OP-XX			
1000	··	RESISTANT WARRANTY OPAL LENS							
1228	INTEGRAL	POST TOP LED WITH STRAIGHT HOOD, TYPE 5	MATCH	POLE ON		SP2-LED-GLA-STR-18LED-BW	208	21	
	DRIVER	DISTRIBUTION AND MOUNTED ON 12' TALL	EXISTING	CONCRETE	AREA LIGHTING	12' ROUND STEEL POLE			
26,393	INTEGRAL	STEEL POLE 31.3" X 13.5" COURT SINGLE HEAD LED	TO BE	BASE POLE ON	LSI	(1) ZNM-24L-CT-UNV-50-XX	208	176	
20,393	DRIVER		DETERMINED	CONCRETE		22 FT ROUND STEEL POLE	200	170	
	DIVER	TALL STEEL POLE		BASE					
(2) AT	INTEGRAL	31.3" X 13.5" COURT DOUBLE HEAD LED	TO BE	POLE ON	LSI	(2) ZNM-24L-CT-UNV-50-XX	208	352	
26, 393	DRIVER	COURT LIGHTING LUMININAIRE AND 22 FT	DETERMINED	CONCRETE		22 FT ROUND STEEL POLE			
		TALL STEEL POLE		BASE					
L /	/								
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H									
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### CROSSINGTON WAY

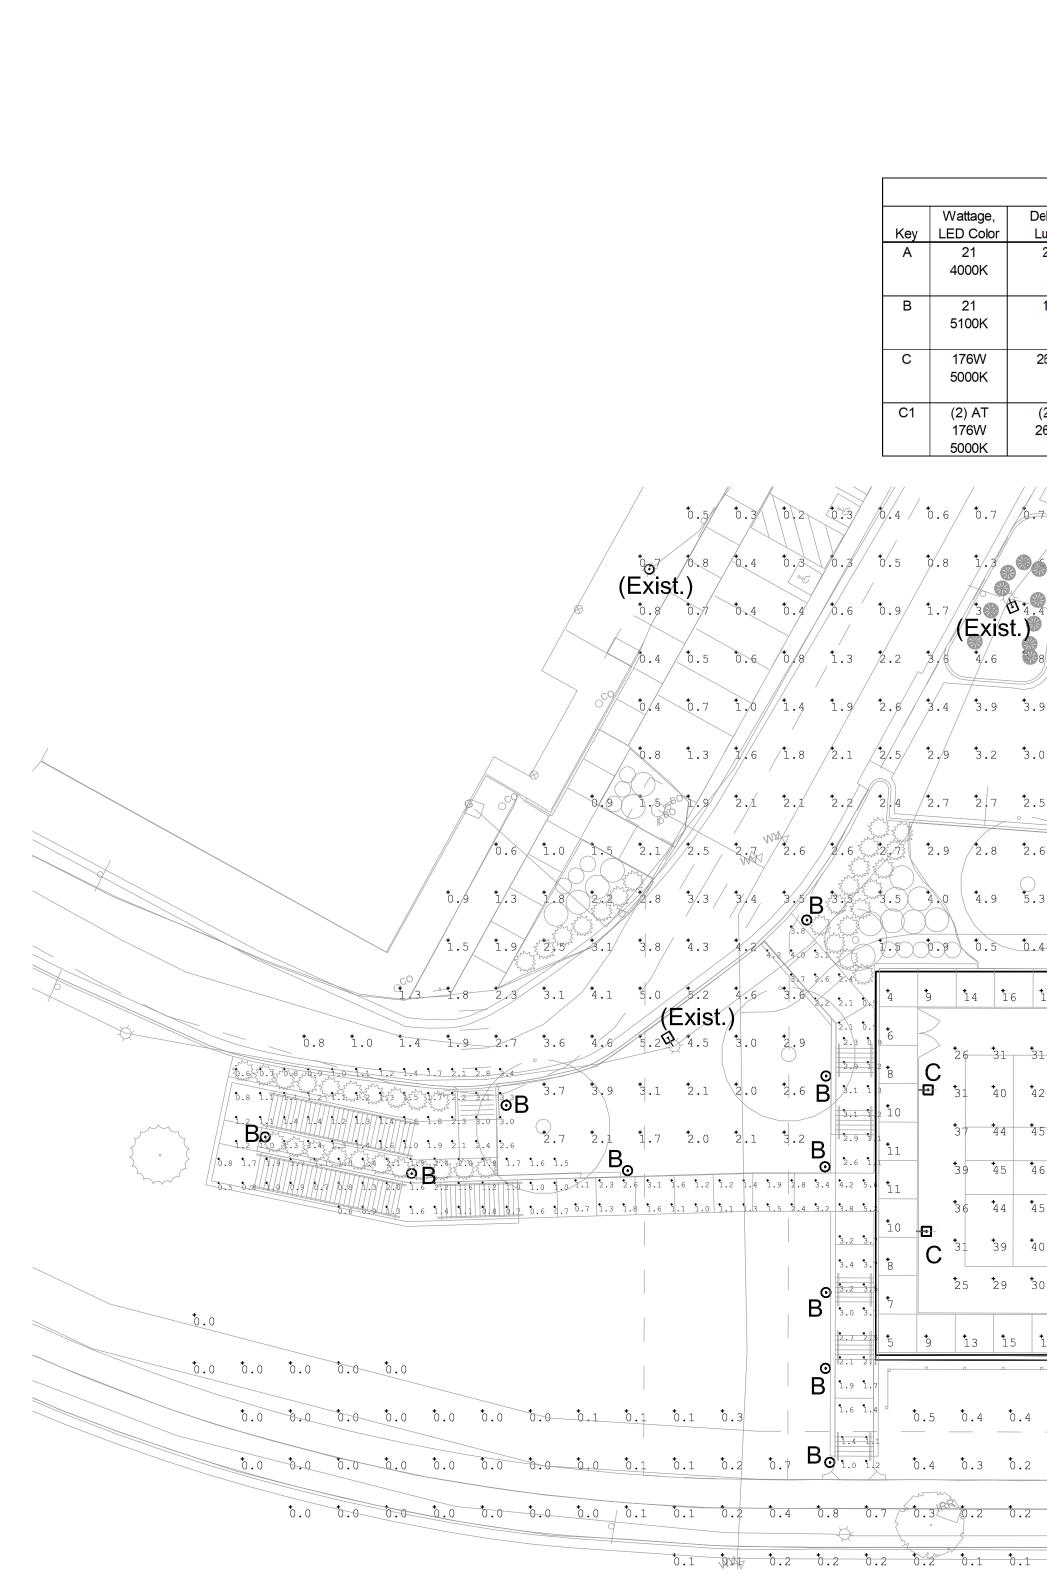

## SITE PHOTOMETRIC PLAN

NORTH



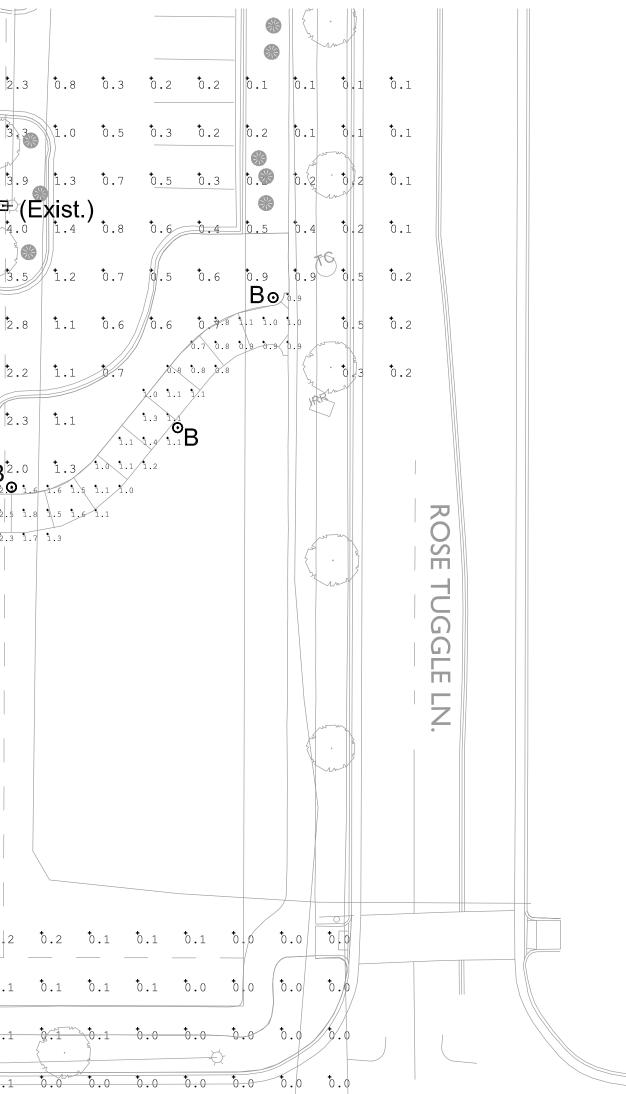





STERLING DESIGN ASSOCIATES, LLC

ISSUES & REVISIONS	
NO.: 1 DATE: -	BY: -
DESCRIPTION: -	
NO: 2 DATE: -	BY: -
DESCRIPTION: -	
NO.: 3 DATE: -	BY: -
DESCRIPTION: -	
NO.: 4 DATE: -	BY: -
DESCRIPTION: -	
NO.: 5 DATE: -	BY: -
DESCRIPTION: -	
NO.: 6 DATE: -	BY: -
DESCRIPTION: -	
DATE:	SCALE:
03/28/2022	1" = 20'
PROJECT MANAGER:	PROJECT NO.:

PROJECT MANAGER: PROJECT NO.: HFR -DRAWN BY: DRAWING FILE: MR -

LONE TREE RECREATION CENTER PICKLE BALL COURTS 10249 RIDGEGATE CIRCLE LONE TREE, CO 80124



4810 E. COUNTY LINE RD. LITTLETON, CO 80126 TEL: (303) 798-5131

PROJECT:


PHOTOMETRICS PLAN

SHEET NUMBER:

		VISION VPF	4 ^I	ype A	Vandal Re	esistan	
					VPF4 Series	LEC	
		Fixture Type	D	ate			
	WALL / CEILING/ PENDANT MOUNT	Job Name	Ap	proved By			
UP	LED	Catalog Number					
SPECIFICATI	ONS			ADA ADA Complia	nt Buy Ame	rican	
Description	in nearly any enviornmenta lens provides complete co	tures an all aluminum, ligature resis I condition. Designed in conjunctio ntrol of glare and LED image while I VPF4 series can be row mounted re.	n with an c maintaining	pthalmologist, t g the high efficie	he polycarbor ncy of clear	nate	
Housing		d extruded aluminum. Finished with Super Durable Corrosion Resistant powder AAMA 2605 high performance specification, providing superior UV durability and t spray test: 4,000 hours.					
Lens		ycarbonate with integral prisms. Ma inum clamps and stainless steel TC			60". Secured t	o	
End Caps	Die cast marine grade alun	ninum with conduit knockouts that	are visible	from interior of e	end cap.		
Drivers	Dimming to 1%, 10% or Pr	rogramable Lumen Output driver op	ptions. Nor	n-Dimming Drive	r is also availa	ble.	
LED	Samsung LM561B+ series L ₇₀ projected life of over 13	es @ 2700K, 3000K, 3500K, 4000K, or 5000K and 82 CRI wired in parallel-series. 130,000 hours at 50 C.					
UL Listing	U.L., C.UL. Damp Location	Listing standard, Wet Location Lis	ting option	al.			
Buy American		cts are assembled in the USA. Our requirements under FAR, DFARS, an itional information.				<u>is.</u>	
Warranty	vandalism for the lifetime c	vandalism. Luminaire LED will repa f the installation. boards against operational defects					
Note		iffer as a result of end-user environ lical values, measured under labora hange without notice.					
		$\frown$ $\top$					

DIME	NSIO	NAL	DAIA

	А	В	С
VPF4 1FT	15.50	4.35	2.70
VPF4 2FT	26.10	4.35	2.70
VPF4 3FT	37.88	4.35	2.70
VPF4 4FT	49.69	4.35	2.70

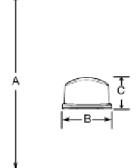


Concerning Led One Lithonia Way, Convers GA 30012 | 1.800.705.SERV (7378) | www.luminaireled.net © 2021 Acuity Brands Lighting, Inc. All rights reserved.

LUMINAIRE-LED-VISION-VPF4-LED Rev. 07/01/21 Page 1 of 5

### RIDGEGATE - SECTION 15 FILING NO. 3 PLANNING AREA OS NO. 21

### MAJOR AMENDMENT SITE IMPROVEMENT PLANS SIP #SP22-XX

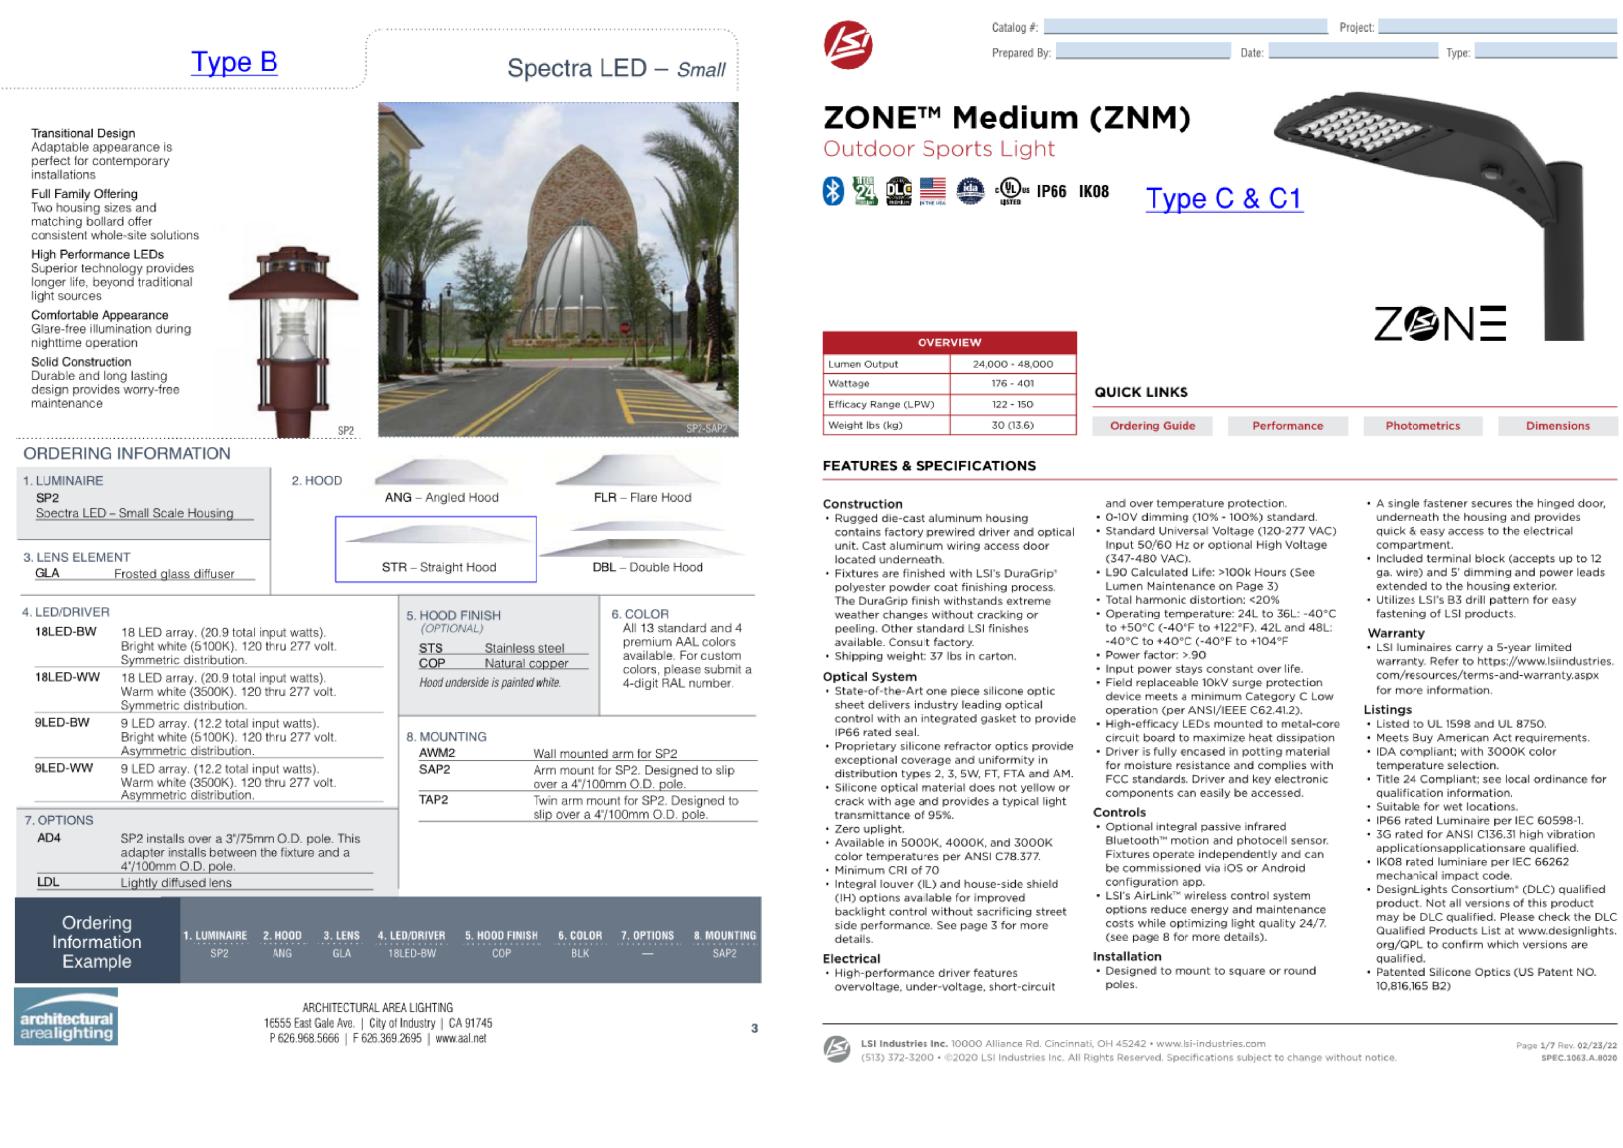

- Qualified Products List at www.designlights.

SPEC.1063.A.8020







STERLING DESIGN ASSOCIATES, LLC

NO.: 1	DATE: -	BY: -
DESCRIP	TION: -	
NO.: 2	DATE: -	ВҮ: -
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NO.: 3	DATE: -	BY: -
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NO.: 6	DATE: -	BY: -
DESCRIP	TION: -	

DATE: <b>03/28/2022</b>	scale: 1" = 20'
PROJECT MANAGER:	PROJECT NO.:
DRAWN BY: MR	DRAWING FILE:

### PROJECT: LONE TREE RECREATION **CENTER PICKLE BALL COURTS 10249 RIDGEGATE CIRCLE** LONE TREE, CO 80124



4810 E. COUNTY LINE RD. LITTLETON, CO 80126 TEL: (303) 798-5131

SHEET TITLE:

### LIGHTING CUTSHEETS

SHEET NUMBER:



LEDGESTONE BLOCK FACADE

### 5084 (Orange)



### LEDGESTONE COLOR SELECTION

NOTE: REDI-ROCK COLORS ARE FORMULATED BASED UPON LOCAL REGION. SSPRD ANTICIPATE WORKING WITH CITY OF LONE TREE TO MATCH DISTRICT COLOR SPECIFICATION AS WELL AS CITY, LOCAL, AND ADJACENT ARCHITECTURE.



## LONE TREE RECREATION CENTER - PICKLE BALL COURTS RETAINING WALL MATERIAL BOARD



**REDI-ROCK** LEDGESTONE SERIES 2940 PARKVIEW DRIVE PETOSKEY, MI 49770 PHONE: +1 (866) 222-8400 EMAIL: INFO@REDI-ROCK.COM



04/29/2022



LEDGESTONE STANDARD BLOCK SIZE

LEDGESTONE SERIES BLOCKS






















Civil Engineers | Landscape Architects 2009 W. Littleton Blvd. #300 Littleton, CO 80120 303.794.4727 | www.SterlingDesignAssociates.com

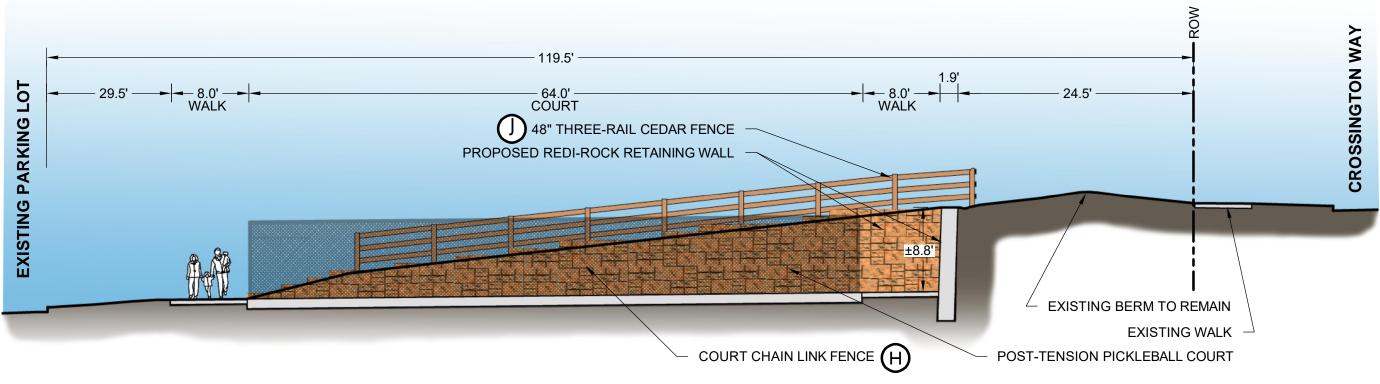


## EASTERN RETAINING WALL ELEVATION SCALE: 1' = 10'

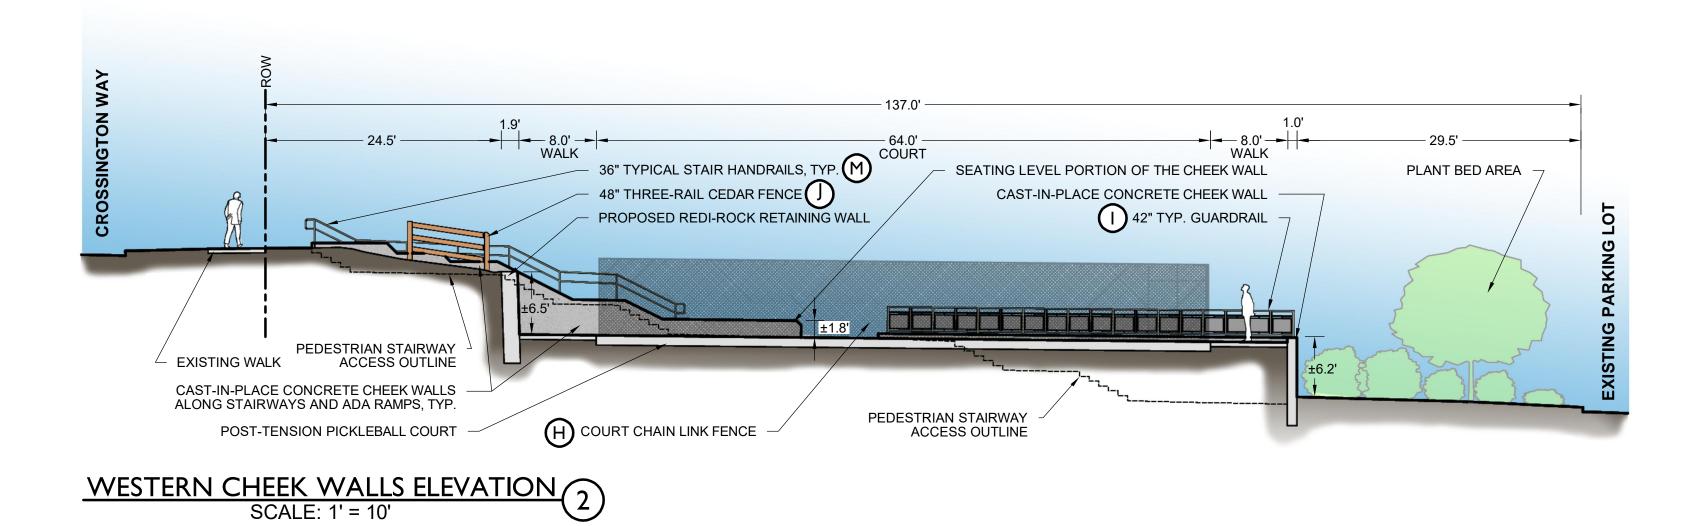

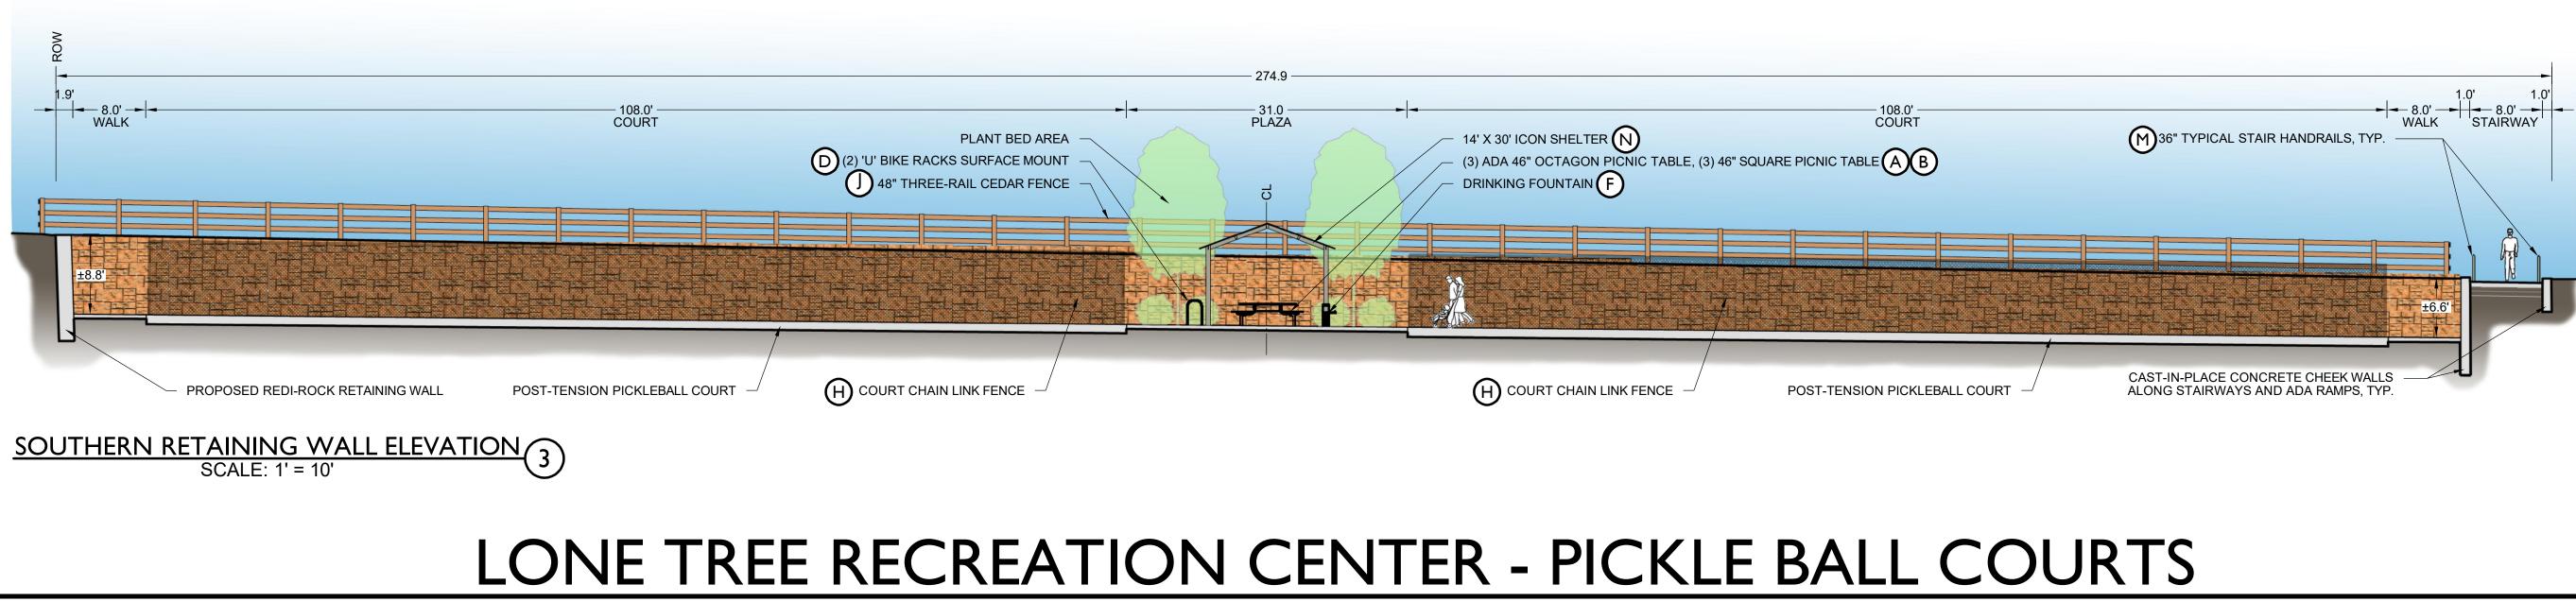



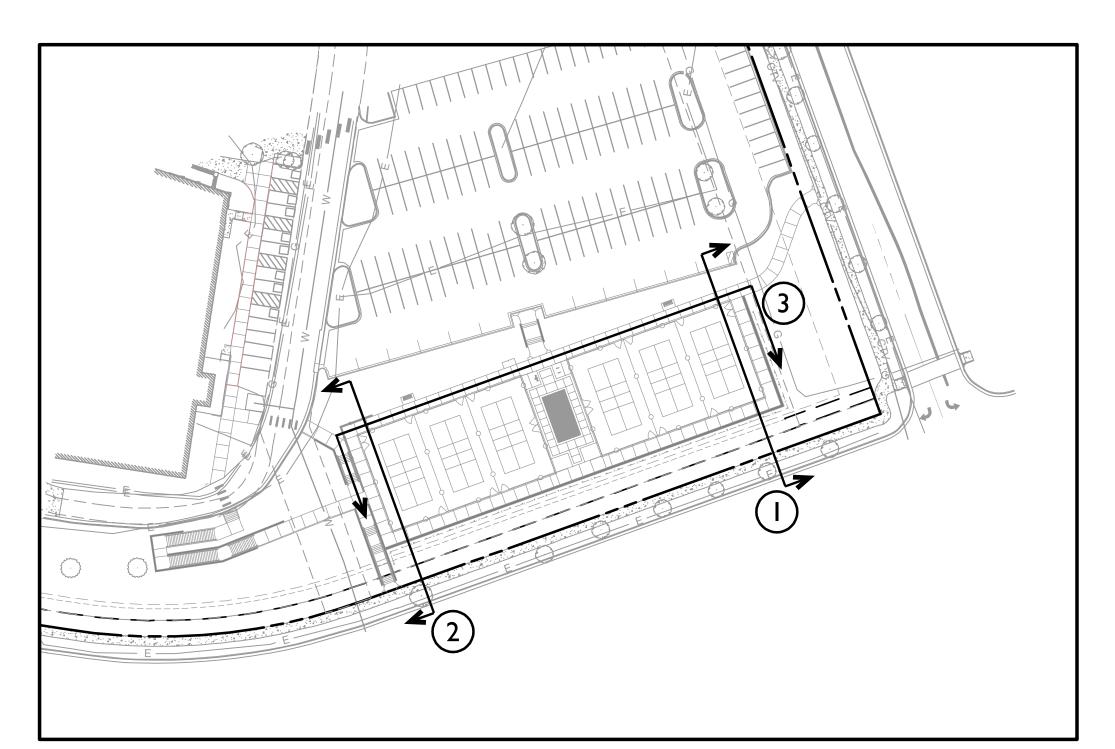


# **RETAINING WALL ELEVATIONS**

## RETAINING WALL ELEVATION KEY MAP SCALE: 1' = 60'


04/29/2022



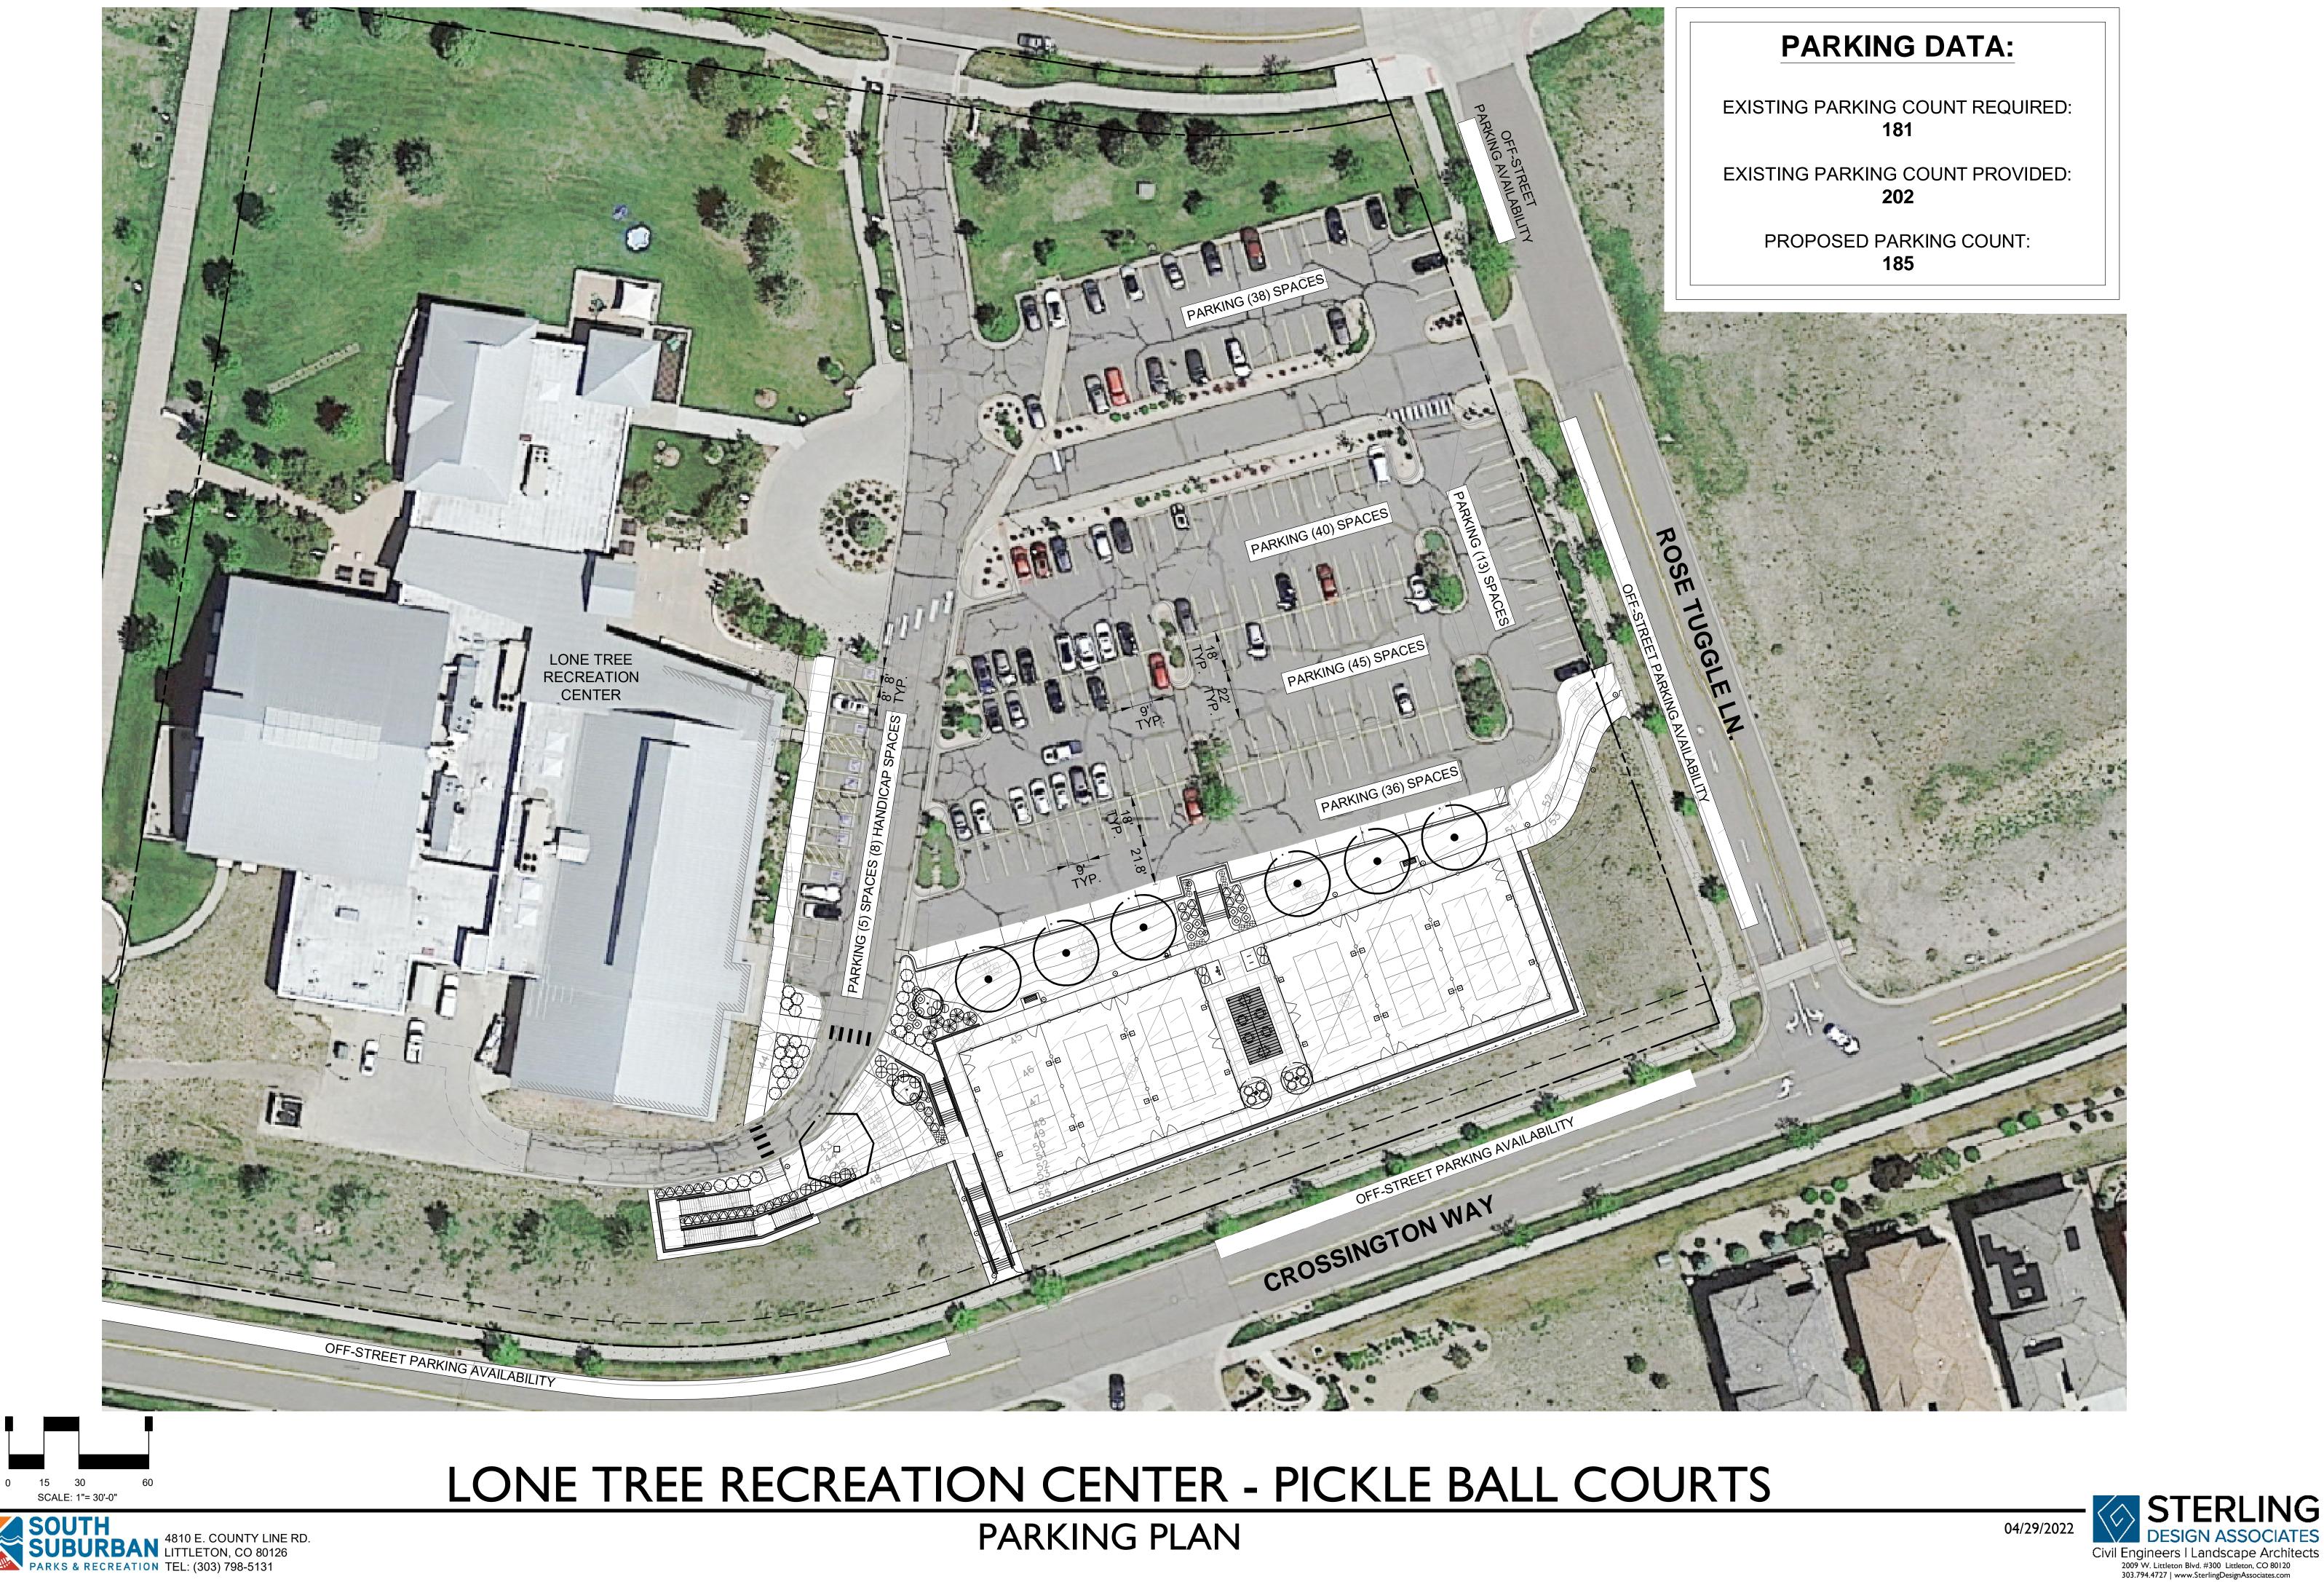

NORTH

FOR:

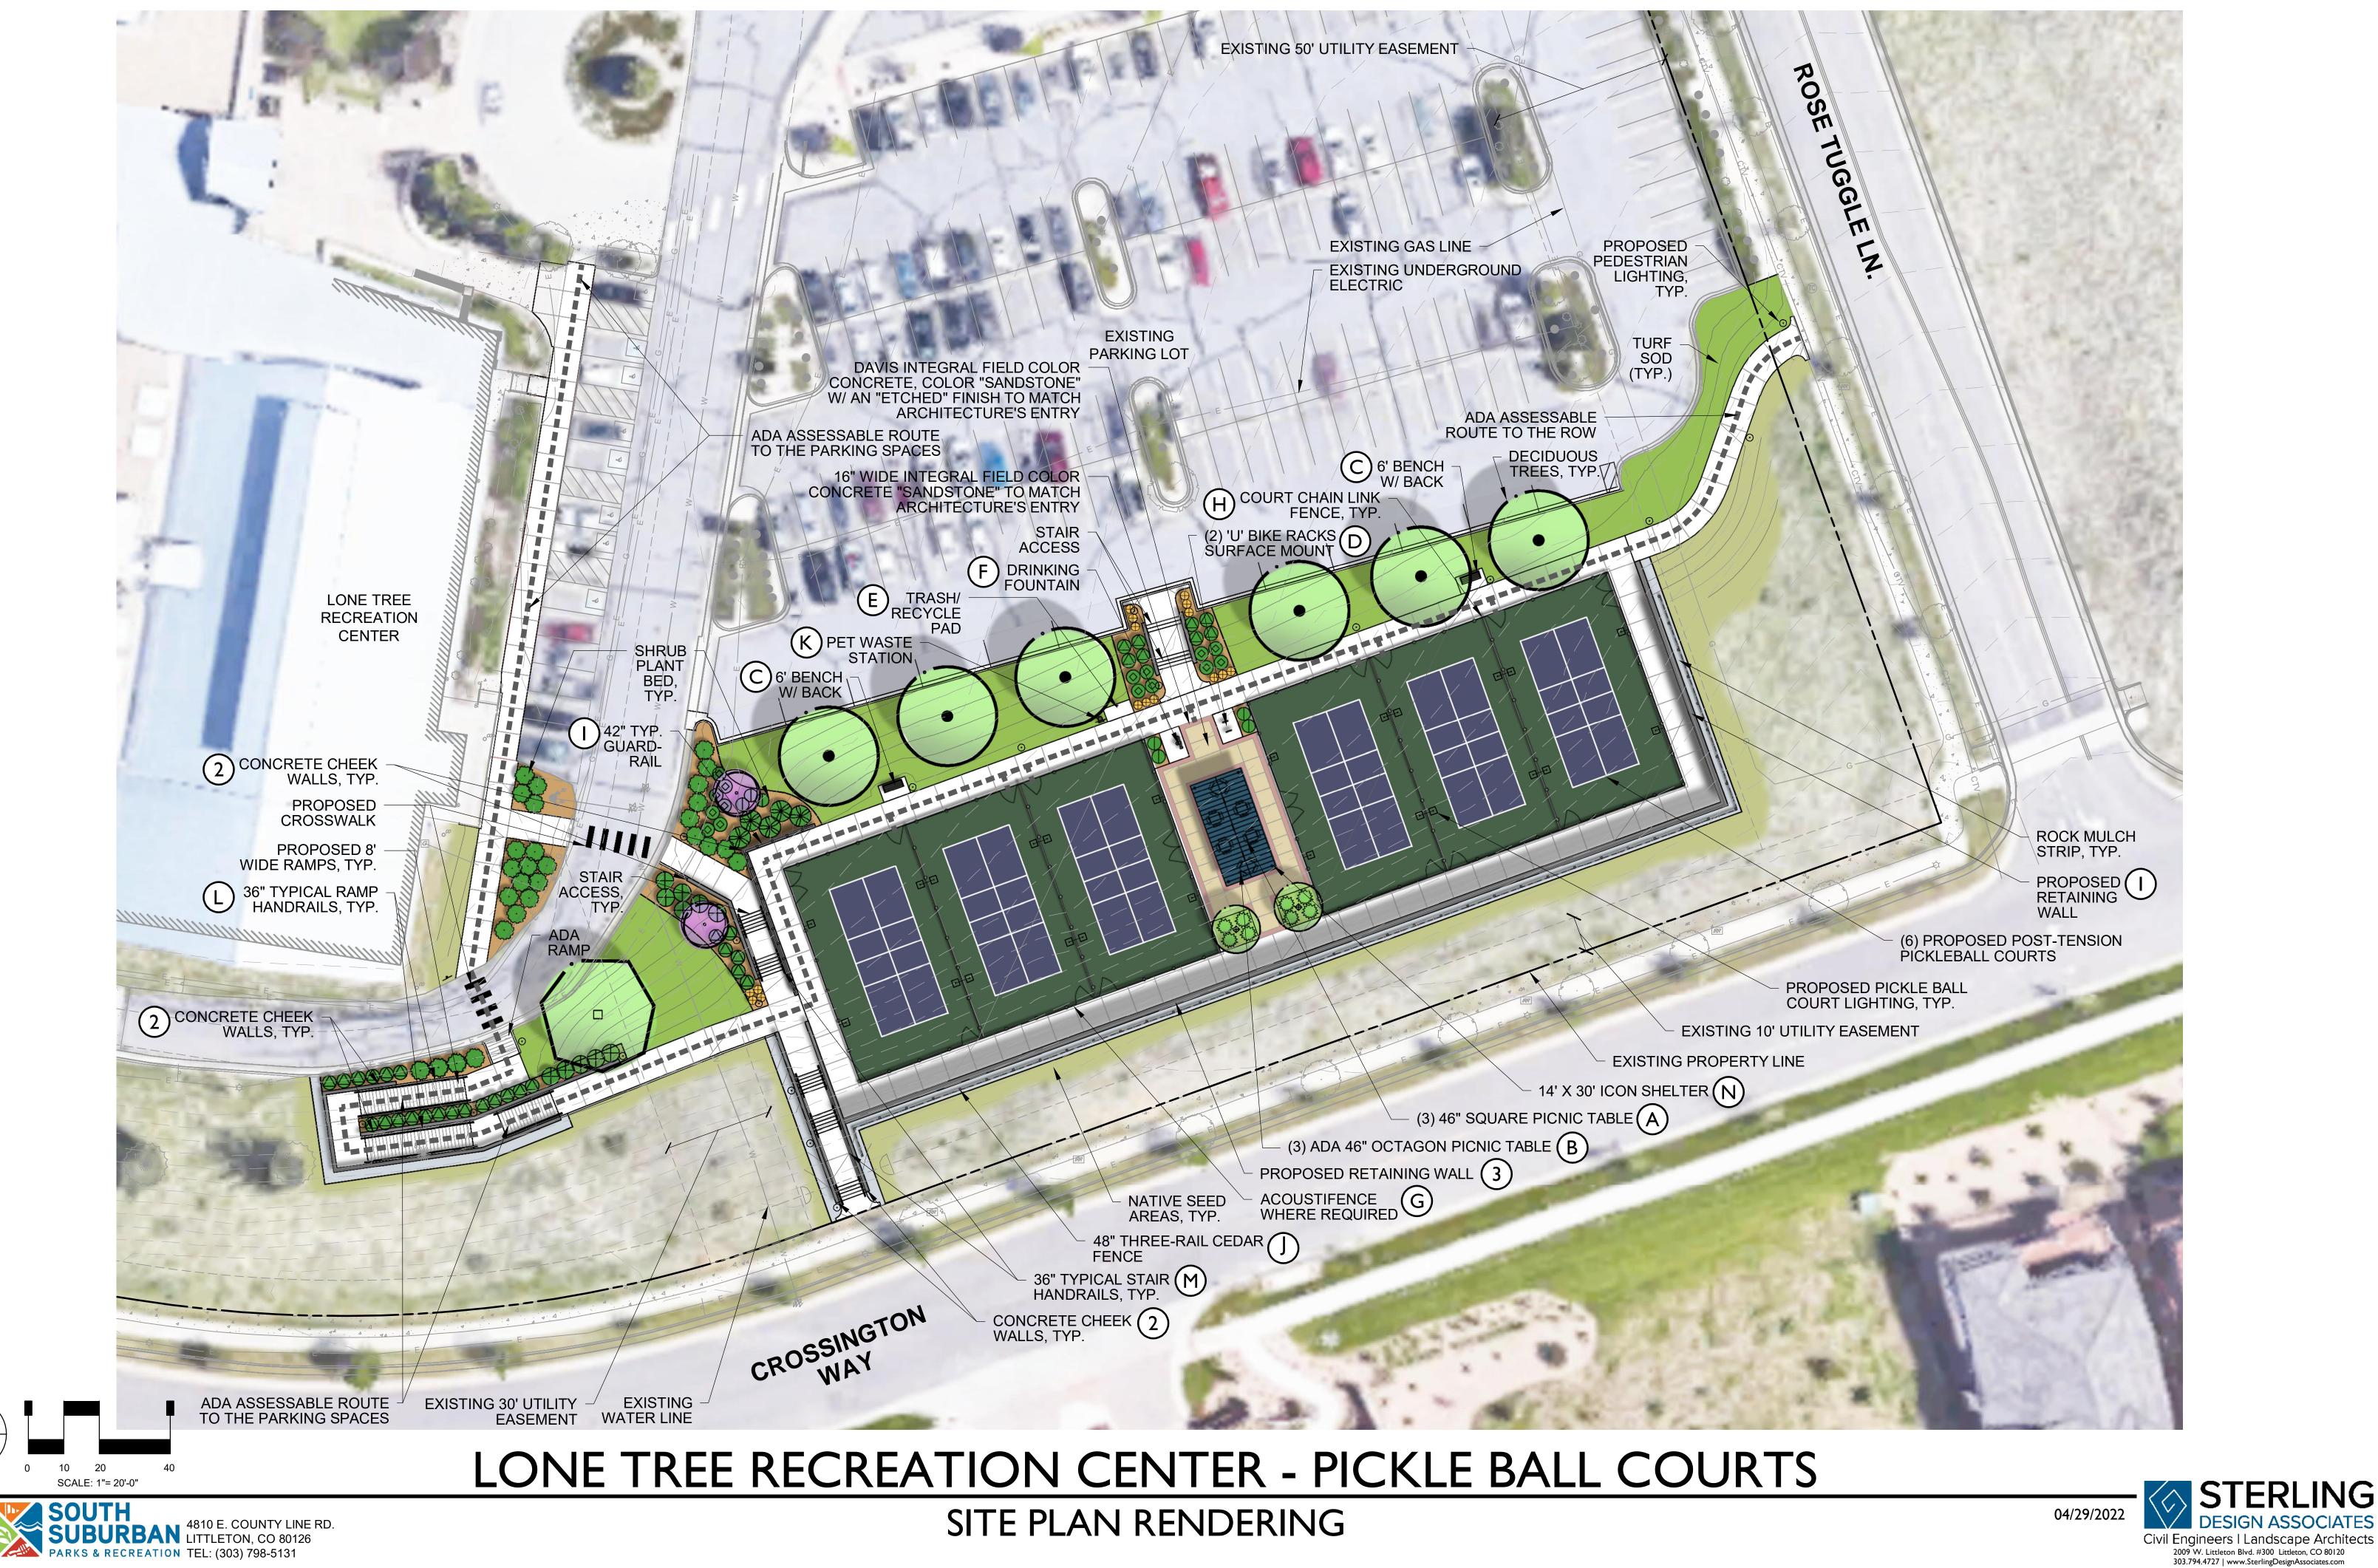

NORTH

FOR: