

LARRY L. LEVIN PARK

RIDGEGATE EAST, FILLING NO. 1, 1st AMENDMENT (Reception No.2016025508), LOT 3-A,

RIDGEGATE PLANNED DEVELOPMENT, 6TH AMENDMENT, PLANNING AREA 7, 0.644 ACRES

SIP #SP22-04R

NOTES:

Lincoln Ave

Rd

hambers

- The property herein is subject to all applicable requirements of the Lone Tree Zoning Code, including, but not limited to, maintenance, lighting, parking, signage, and outdoor storage, except as may otherwise be addressed in an approved Development Plan or Sub-Area Plan.
- The applicant assumes responsibility to ensure the project is completed in accordance with the approved SIP and any associated materials sample boards and further assumes the risk associated with any changes or omissions made without prior City approval. Modifications to structures or sites may require an amendment to the SIP as determined by the Director. Unauthorized changes or omissions may result in corrective actions, delay of permits or citations for zoning violations with associated fines and legal measures. Building plans shall conform to the approved SIP.
- Within site triangles, as shown, limited landscaping shall be allowed with no solid structures 3 permitted as stated in the City of Lone Tree's Landscape Design Guidelines and Standards for Landscaping. Landscaping within the sight triangle shall be maintained by the property owner or appropriate association or district, as may be identified in maintenance agreements recorded with the Douglas County Clerk and Recorder's Office.
- The owner is responsible for the installation of all roadway signage, including "no parking/fire lane" signage, as required by the City Public Works Department and/or the Fire District. Such signage shall be maintained by the property owner or appropriate association or district, as may be identified in maintenance agreements recorded with the Douglas County Clerk and Recorder's Office.
- 5. It shall be the responsibility of the owner (or responsible association or district, as may be identified by maintenance agreements) to maintain all improvements on the property in a state of good repair, to ensure all irrigation is functional, and to ensure all plantings are alive, consistent with the approved landscape and irrigation plan and Lone Tree Municipal Code.
- 6. Site landscaping, site amenities and furnishings, and all site improvements including, but not limited to, sidewalks and parking areas shall be maintained in a state of good repair consistent with the approved SIP and the Lone Tree Municipal Code and Design Guidelines and Standards. Such maintenance shall include the regular maintenance of pet waste stations (when present), to include waste collection and waste bag replacement. Such maintenance obligations shall be completed by the property owner or appropriate association or district, as may be identified in maintenance agreements recorded with the Douglas County Clerk and Recorder's Office.
- 7. It shall be the responsibility of the owner (or responsible association or district, as may be identified by maintenance agreements) to maintain all playground equipment and park infrastructure on the property in a state of good repair in conformance with all applicable building and safety regulations.
- The City of Lone Tree requires that maintenance access be provided to all storm drainage facilities to assure continuous operational capability of the system. The property owner shall be responsible for the maintenance of all drainage facilities, including inlets, pipes, culverts, channels, ditches, hydraulic structures and detention basins located on their land unless modified by the site improvement plan improvements agreement. Should the owner fail to adequately maintain said facilities, the City of Lone Tree shall have the right to enter said land for the purposes of operations and maintenance. All such maintenance costs will be assessed to the property owner or the responsible maintenance authority.



____ Notar






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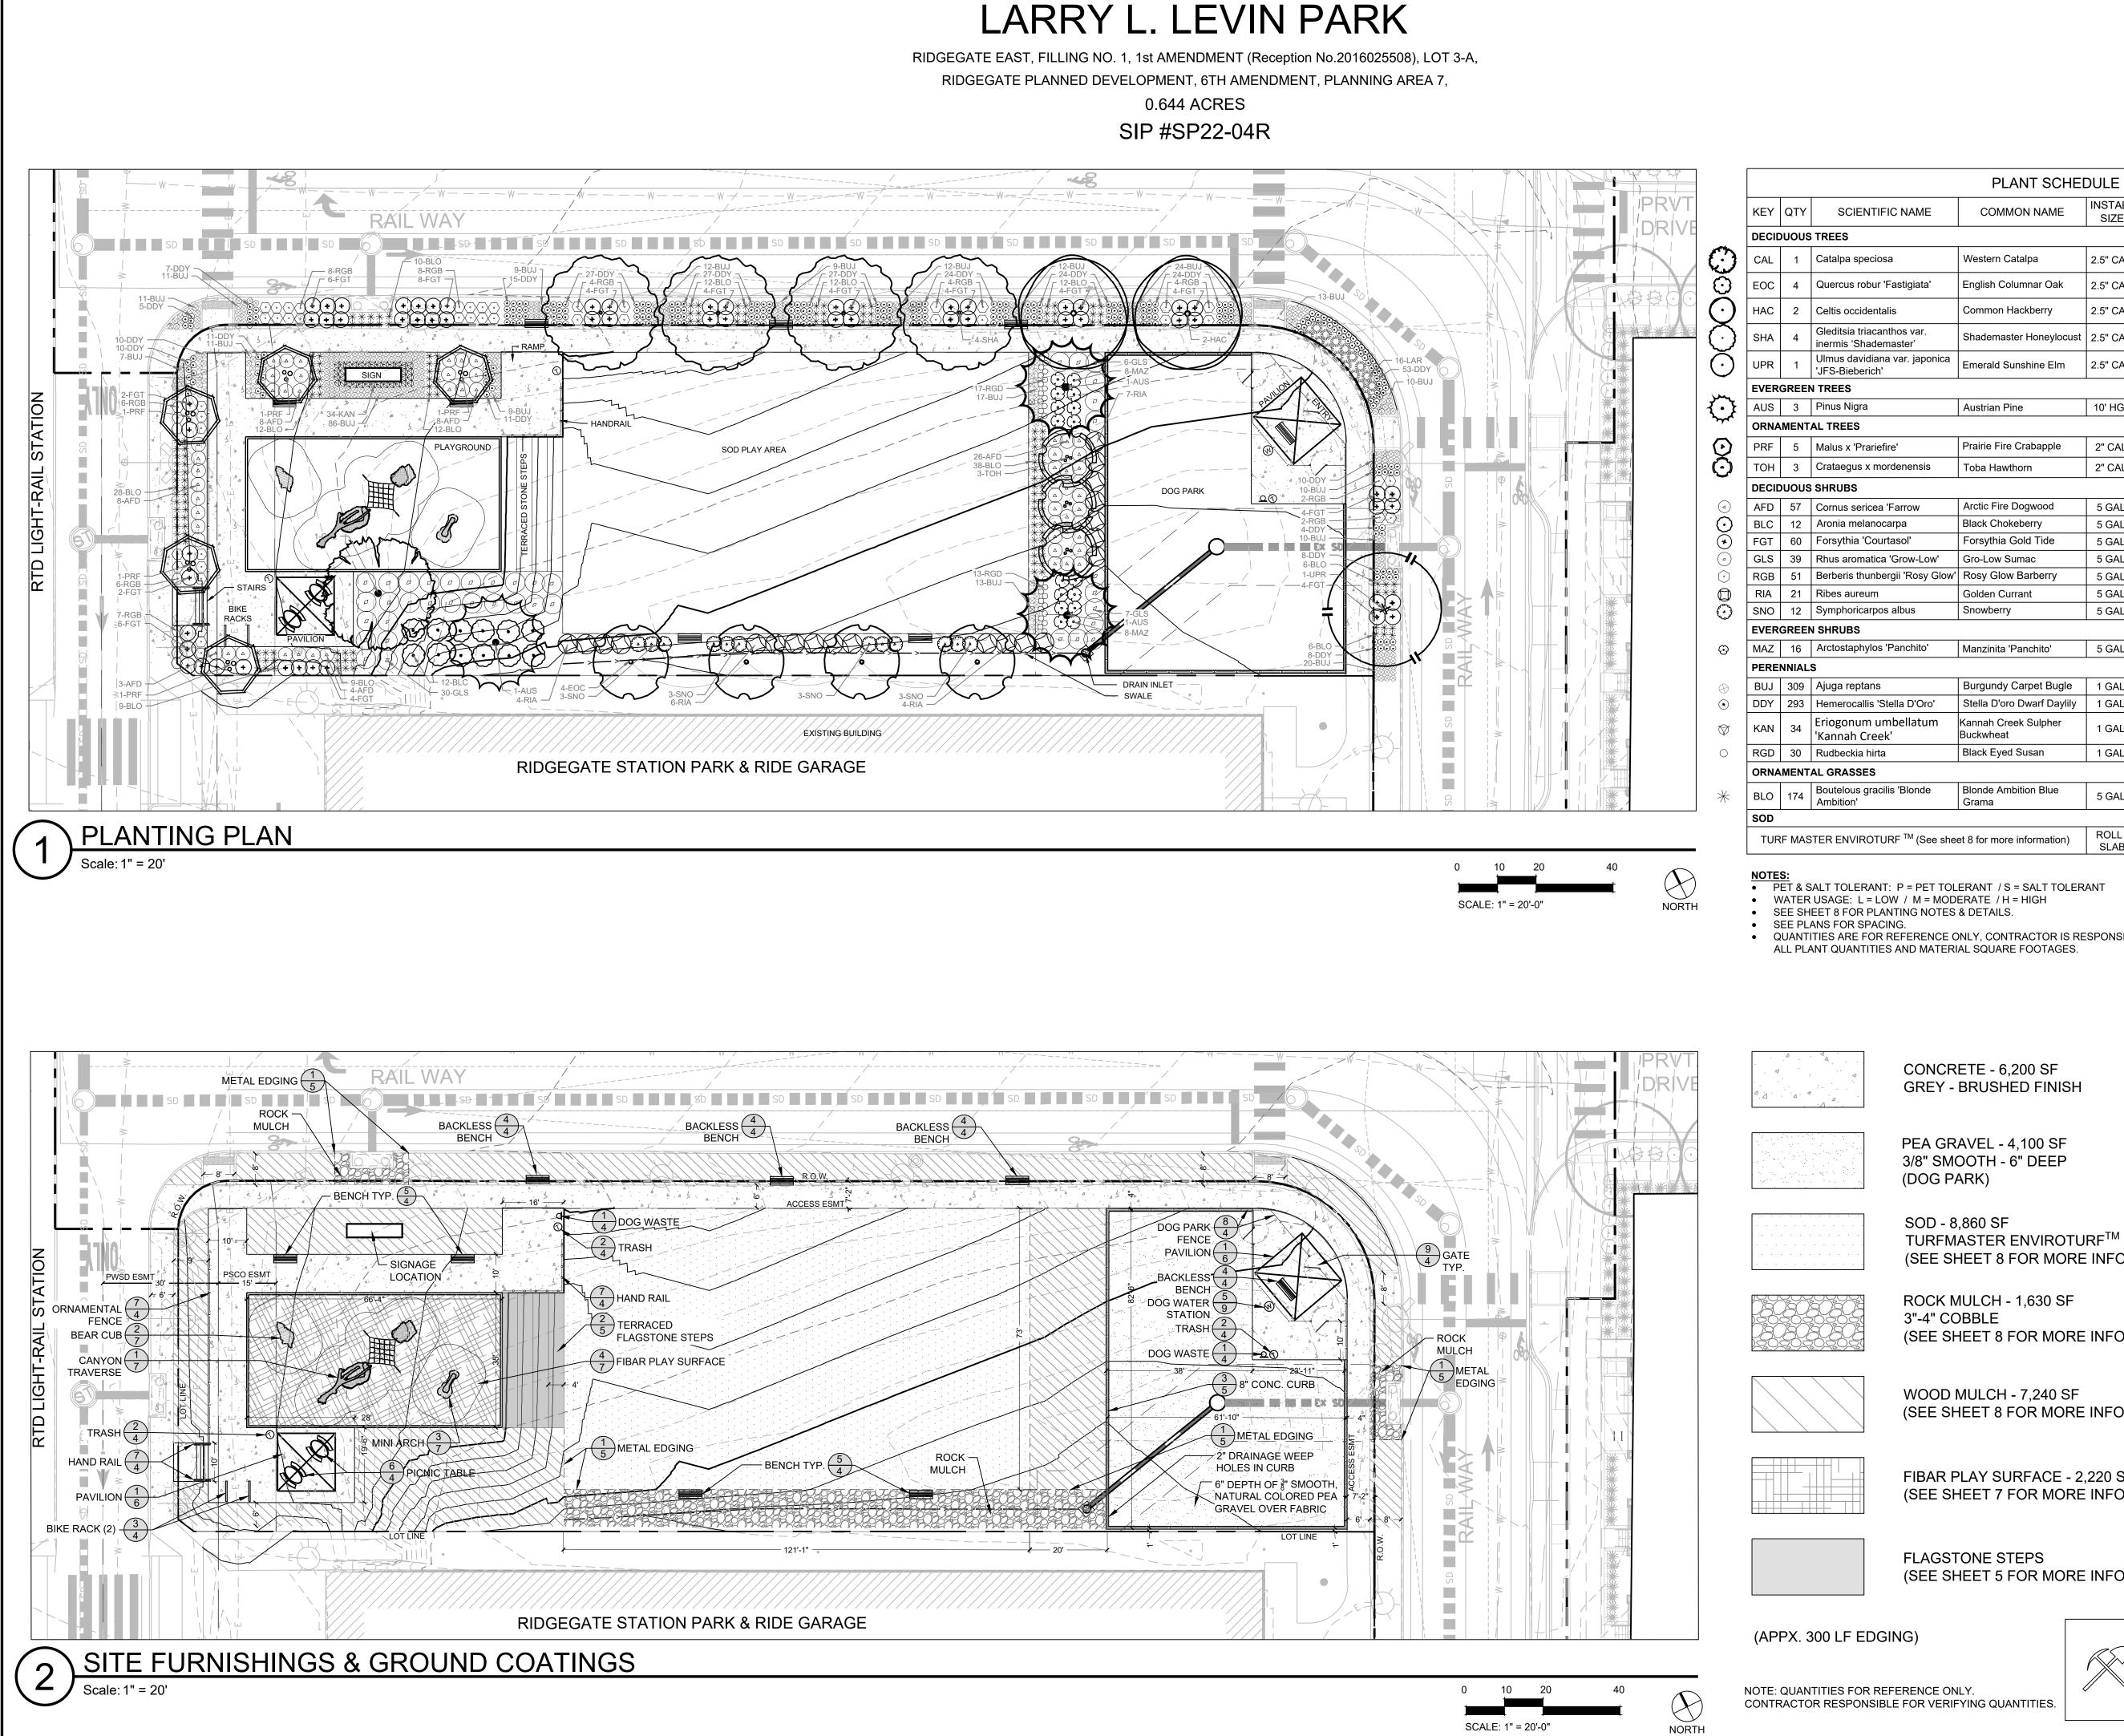
CONCEPTUAL RENDERING Additional Renderings on Sheet 5

Title: ____

APPROVAL CERTIFICATE This site improvement plan was approved for filing by the Council of the City of Lone Tree, CO, on the	COPYRIGHT © BY CONSILIUM AN INSTRUMENT OF SERVICE THE LANDSCAPE ARCHITECT FOR THE PROJECT SHO DUPLICATED, DISCLOSED OR WRITTEN CONSENT OF CONS	G AND CHITECTURE OCUST ST, 80222 520 524 design.com
By:	LARRY L. LEVIN PARK RAMPART RANGE METRO DISTRICT CITY OF LONETREE, COLORADO	SITE IMPROVEMENT PLAN
Notary Public SHEET INDEX: 1. COVER 2. SITE PLAN 3. LANDSCAPE PLAN, PLANT SCHEDULE, SITE FURNISHINGS & GROUND COATINGS 4. SITE FURNISHINGS 5. LANDSCAPE RENDERINGS 6. LANDSCAPE STRUCTURES - PAVILION 7. LANDSCAPE STRUCTURES - PAVILION 8. LANDSCAPE STRUCTURES - PAVILION 1. LANDSCAPE STRUCTURES - PAVILION 8. LANDSCAPE STRUCTURES - PAVILION 1. LANDSCAPE STRUCTURES - PAVILION 1. LANDSCAPE STRUCTURES - PLAYGROUND 8. LANDSCAPE NOTES 9. IRRIGATION SCHEDULE, NOTES & DETAILS 10. IRRIGATION PLAN 11. LIGHTING PLAN 12. UTILITY PLAN 13. LIGHTING PLAN 14. LIGHTING DETAILS	3/16/2022 5/13/2022 5/13/2022 5970 GREENWO GREENWOOD V TEL 303.535.385 www.merrick.com SHEET TITLE COV SHEET NUMBER	ISSUE SIP SUBMITTAL SIP 2ND SUB. SIP 3RD SUB.



	SITE I	DATA TABLE	
	Square Footage	Surface Material	% of Gross Site
а	± 28,050 S.F. (0.644 Acres)	Varies	100 %
print (2) 15'x15' pavilions	450 S.F.	Varies	N/A
rea ROW plantings)	4,570 S.F.	Wood Mulch	16%
ea (concrete)	6,200 S.F.	Concrete	22%
ea (dog park curb)	150 S.F.	Concrete	1%
а	8,860 S.F.	Sod	32%
rea	2,220 S.F.	Fibar Woven Wood Mulch	8%
I	4,100 S.F.	Pea Gravel	15%
	550 S.F.	Flagstone	2%
ainway	1400 S.F.	Cobble	3%
	340 L.F.	Steel	N/A
caped Area	2,670 S.F.	Wood Mulch	(Additional SF)
/ulch	230 S.F.	Cobble	(Additional SF)
e Provided	(14) 5 bike Wave Rack x 2	Metal	(Near West Pavilion)

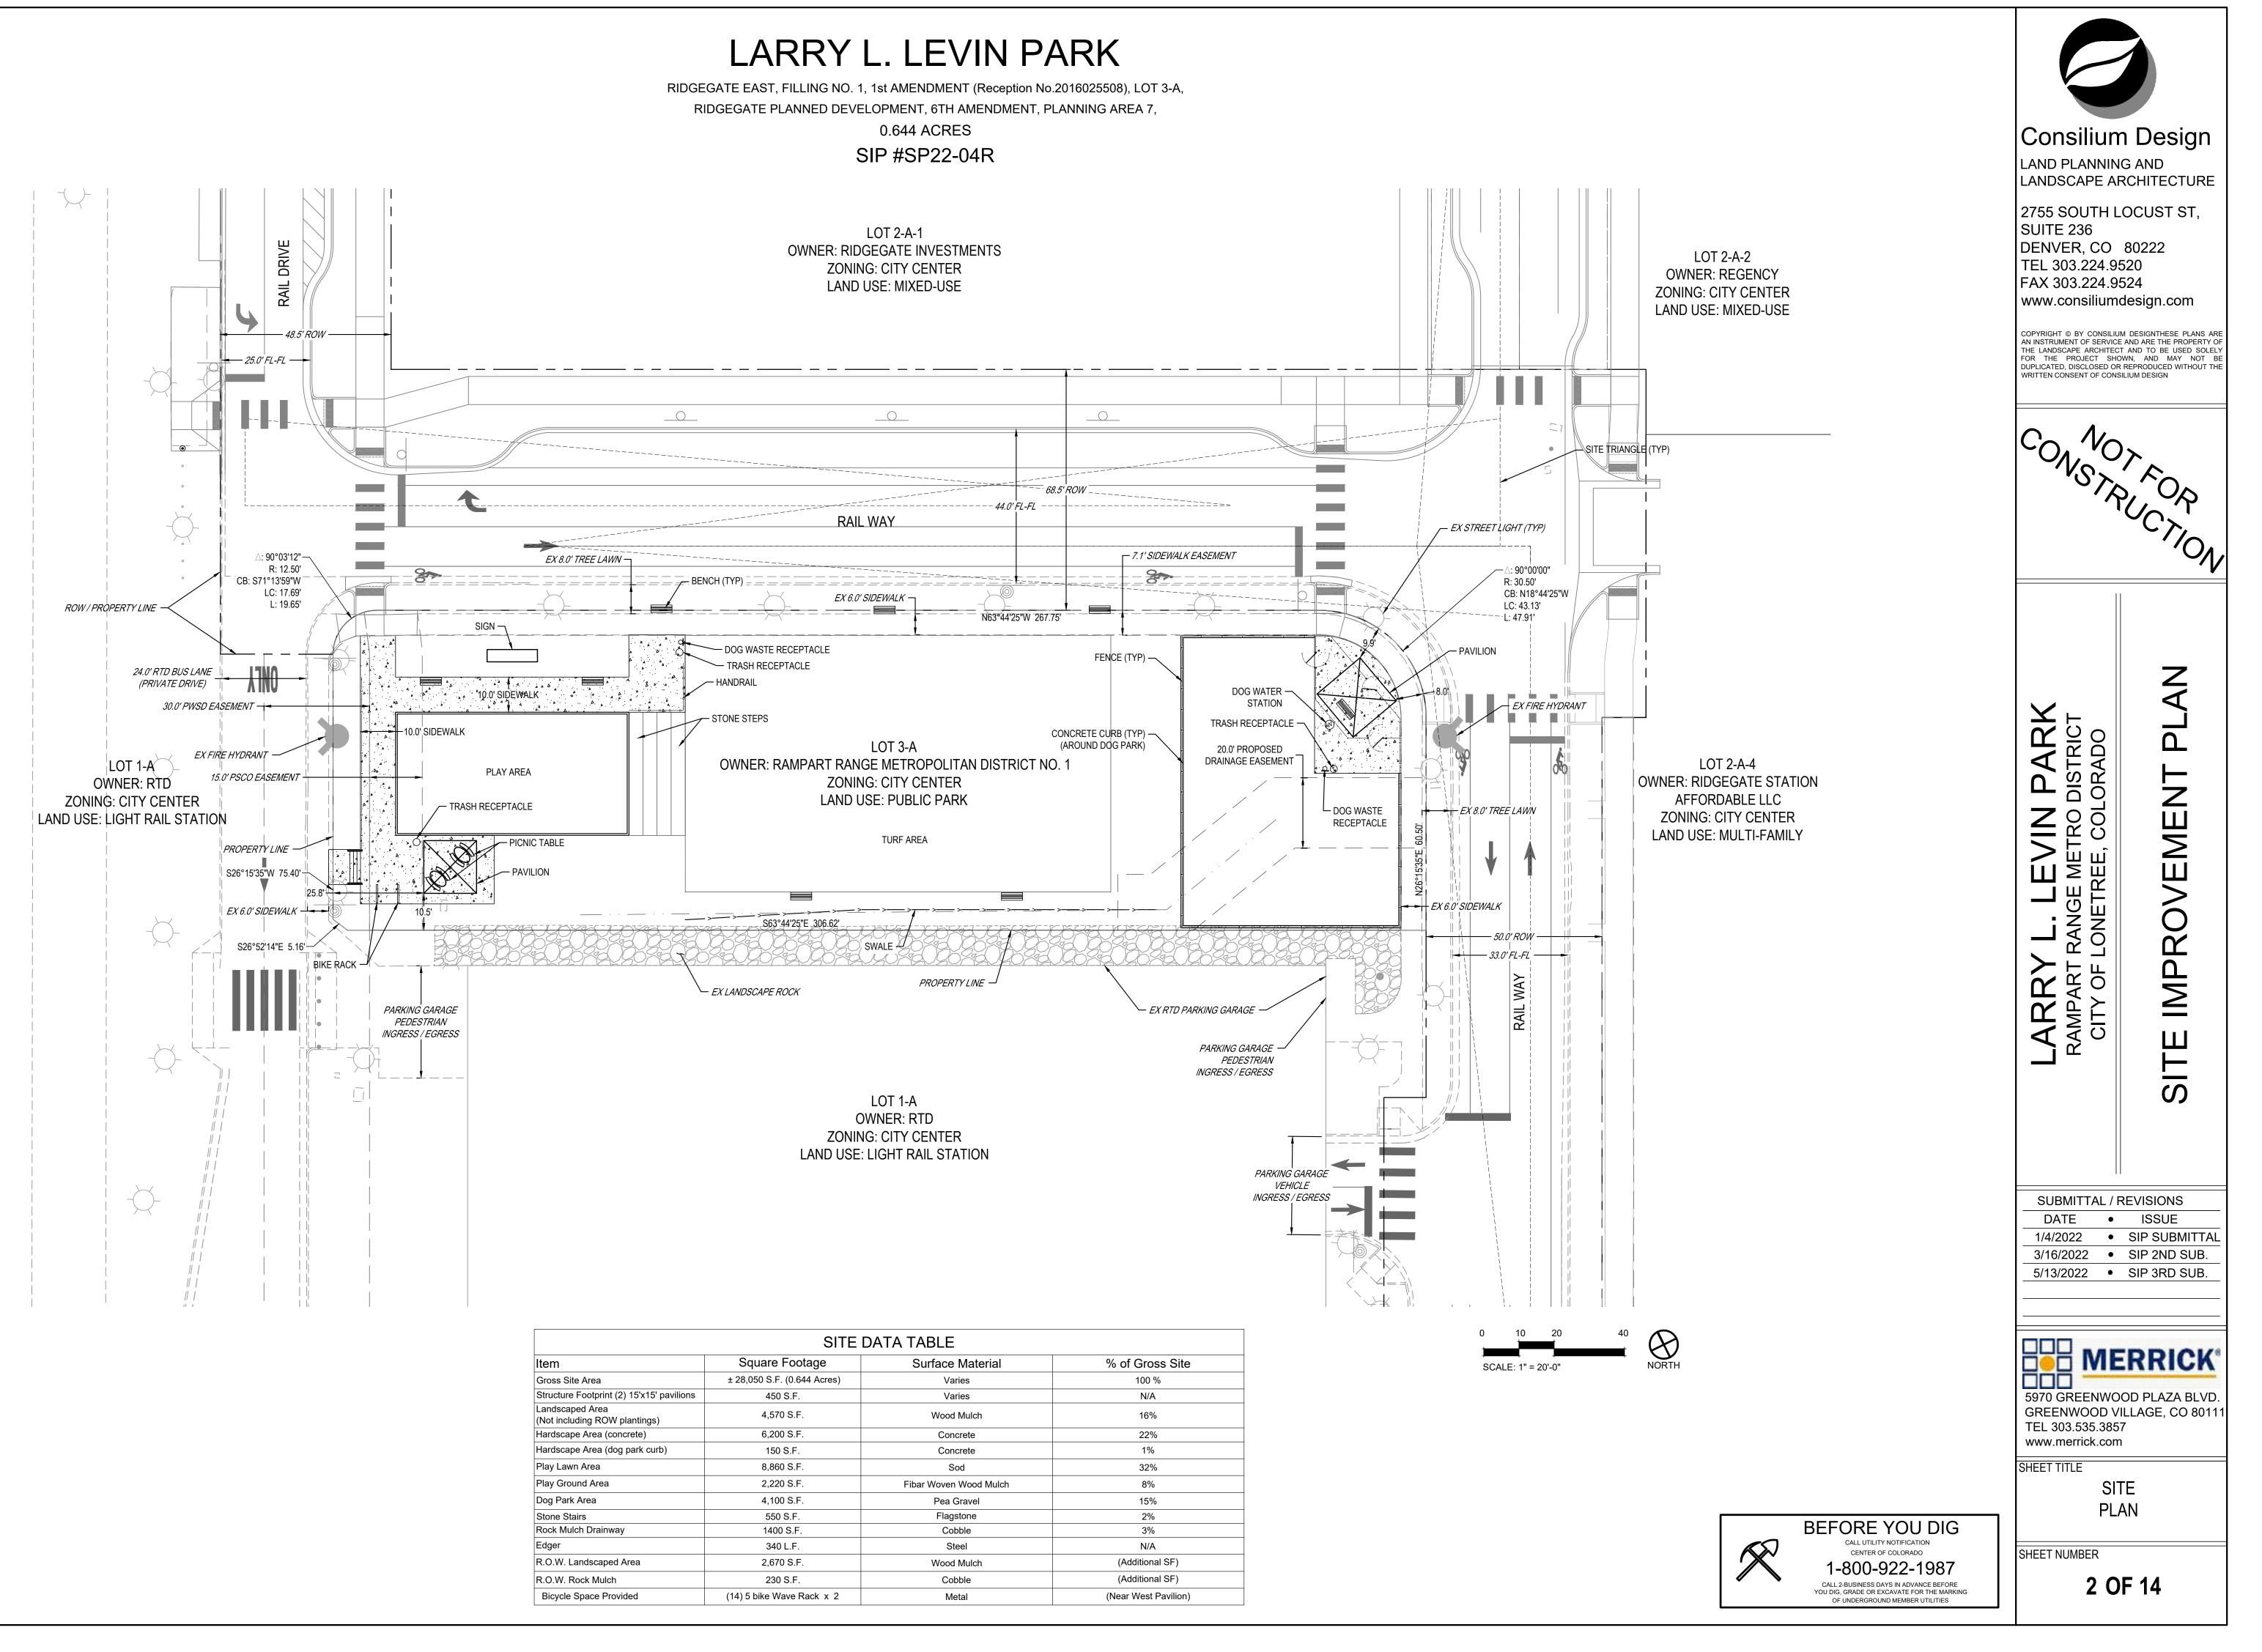

	PLANT SCHEI	DULE				
SCIENTIFIC NAME	COMMON NAME	INSTALL SIZE	INSTALL NOTES	MATURE H' x W"	WATER USAGE	PET/SALT TOLERANT
TREES						
Catalpa speciosa	Western Catalpa	2.5" CAL.	B&B / G&S	60' x 40'	L-M	MILD S
Quercus robur 'Fastigiata'	English Columnar Oak	2.5" CAL.	B&B / G&S	40' x 20'	L-M	MILD S
Celtis occidentalis	Common Hackberry	2.5" CAL.	B&B / G&S	60' x 40'	L	S
Gleditsia triacanthos var. inermis 'Shademaster'	Shademaster Honeylocust	2.5" CAL.	B&B / G&S	50' x 35'	L	P / S
Ulmus davidiana var. japonica 'JFS-Bieberich'	Emerald Sunshine Elm	2.5" CAL.	B&B / G&S	35' x 30'	L-M	S
TREES						
Pinus Nigra	Austrian Pine	10' HGT	B&B / G&S	50' x 20'	L	S
AL TREES						
Malus x 'Prariefire'	Prairie Fire Crabapple	2" CAL.	B&B / G&S	20' x 15'	L	MILD S
Crataegus x mordenensis	Toba Hawthorn	2" CAL.	B&B / G&S	15' x 12'	L-M	Р
SHRUBS						
Cornus sericea 'Farrow	Arctic Fire Dogwood	5 GAL.	2' WIDTH	4' x 4'	М	P/S
Aronia melanocarpa	Black Chokeberry	5 GAL.	3' WIDTH	6' x 4'	L	S
Forsythia 'Courtasol'	Forsythia Gold Tide	5 GAL.	3' WIDTH	1-2' x 3-4'	L - M	P/S
Rhus aromatica 'Grow-Low'	Gro-Low Sumac	5 GAL.	3' WIDTH	3' x 8'	L	P/S
Berberis thunbergii 'Rosy Glow'	Rosy Glow Barberry	5 GAL.	2' WIDTH	4' x 4'	L-M	P/S
Ribes aureum	Golden Currant	5 GAL.	3' WIDTH	6' x 6'	L	S
Symphoricarpos albus	Snowberry	5 GAL.	2' WIDTH	6' x 4'	L-M	S
I SHRUBS		1		I		
Arctostaphylos 'Panchito'	Manzinita 'Panchito'	5 GAL.	3' WIDTH	1-2' x 3-5'	L	Р
3						
Ajuga reptans	Burgundy Carpet Bugle	1 GAL.	CONT.	0.5' x 1'	М	P/S
Hemerocallis 'Stella D'Oro'	Stella D'oro Dwarf Daylily	1 GAL.	CONT.	1' x 1'	L-M	P/S
Eriogonum umbellatum 'Kannah Creek'	Kannah Creek Sulpher Buckwheat	1 GAL.	CONT.	1.5' x 1-2'	L	P/S
Rudbeckia hirta	Black Eyed Susan	1 GAL.	CONT.	2' x 2'	L-M	S
AL GRASSES	1			1		
Boutelous gracilis 'Blonde Ambition'	Blonde Ambition Blue Grama	5 GAL.	CONT.	2' x 2-3'	L	S
TER ENVIROTURF [™] (See she	et 8 for more information)	ROLL / SLAB	FRESH CUT	MOW 2" - 5"	L	P/S

• WATER USAGE: L = LOW / M = MODERATE / H = HIGH • SEE SHEET 8 FOR PLANTING NOTES & DETAILS.

• QUANTITIES ARE FOR REFERENCE ONLY, CONTRACTOR IS RESPONSIBLE FOR VERIFYING

CONCRETE - 6,200 SF **GREY - BRUSHED FINISH**

PEA GRAVEL - 4,100 SF 3/8" SMOOTH - 6" DEEP

(SEE SHEET 8 FOR MORE INFORMATION) ROCK MULCH - 1,630 SF

3"-4" COBBLE (SEE SHEET 8 FOR MORE INFORMATION)

WOOD MULCH - 7,240 SF (SEE SHEET 8 FOR MORE INFORMATION)

FIBAR PLAY SURFACE - 2,220 SF (SEE SHEET 7 FOR MORE INFORMATION)

FLAGSTONE STEPS (SEE SHEET 5 FOR MORE INFORMATION)




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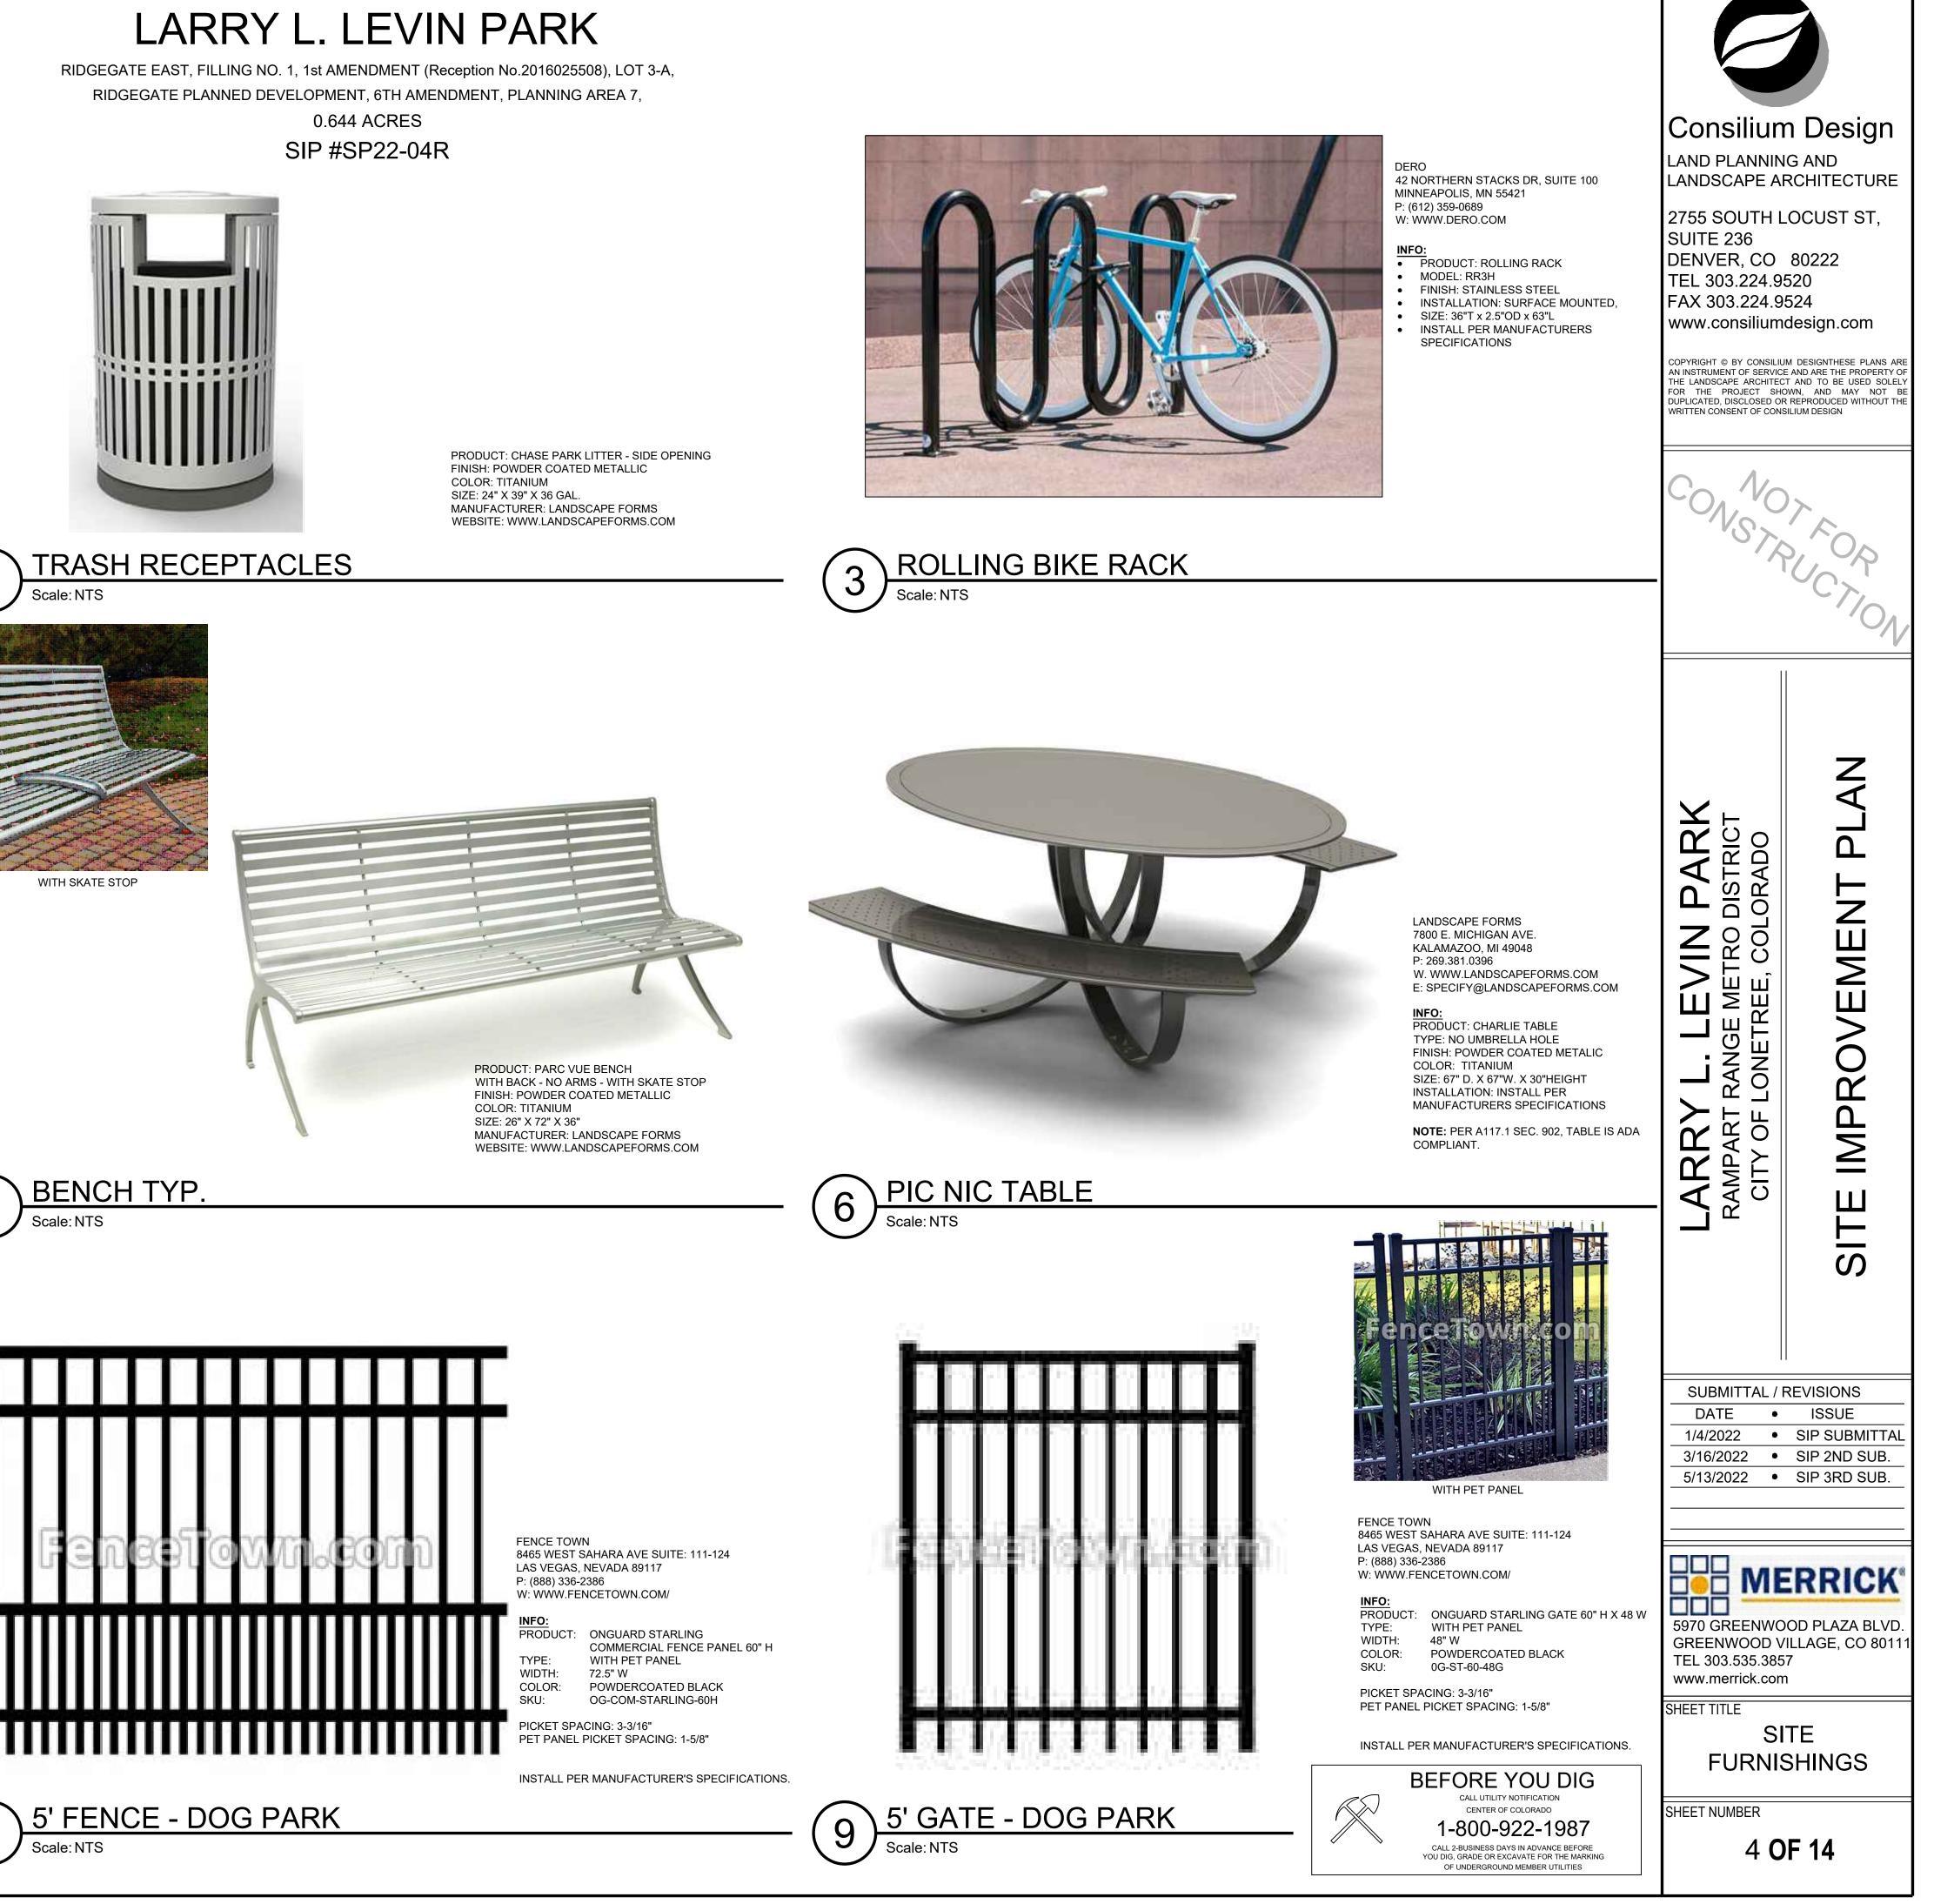


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LARRY L. LEVIN PARK RAMPART RANGE METRO DISTRICT CITY OF LONETREE, COLORADO	SITE IMPROVEMENT PLAN
SUBMITTAL / DATE • 1/4/2022 • 3/16/2022 • 5/13/2022 •	ISSUE SIP SUBMITTAL SIP 2ND SUB.
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SHEET NUMBER

3 **OF 14**






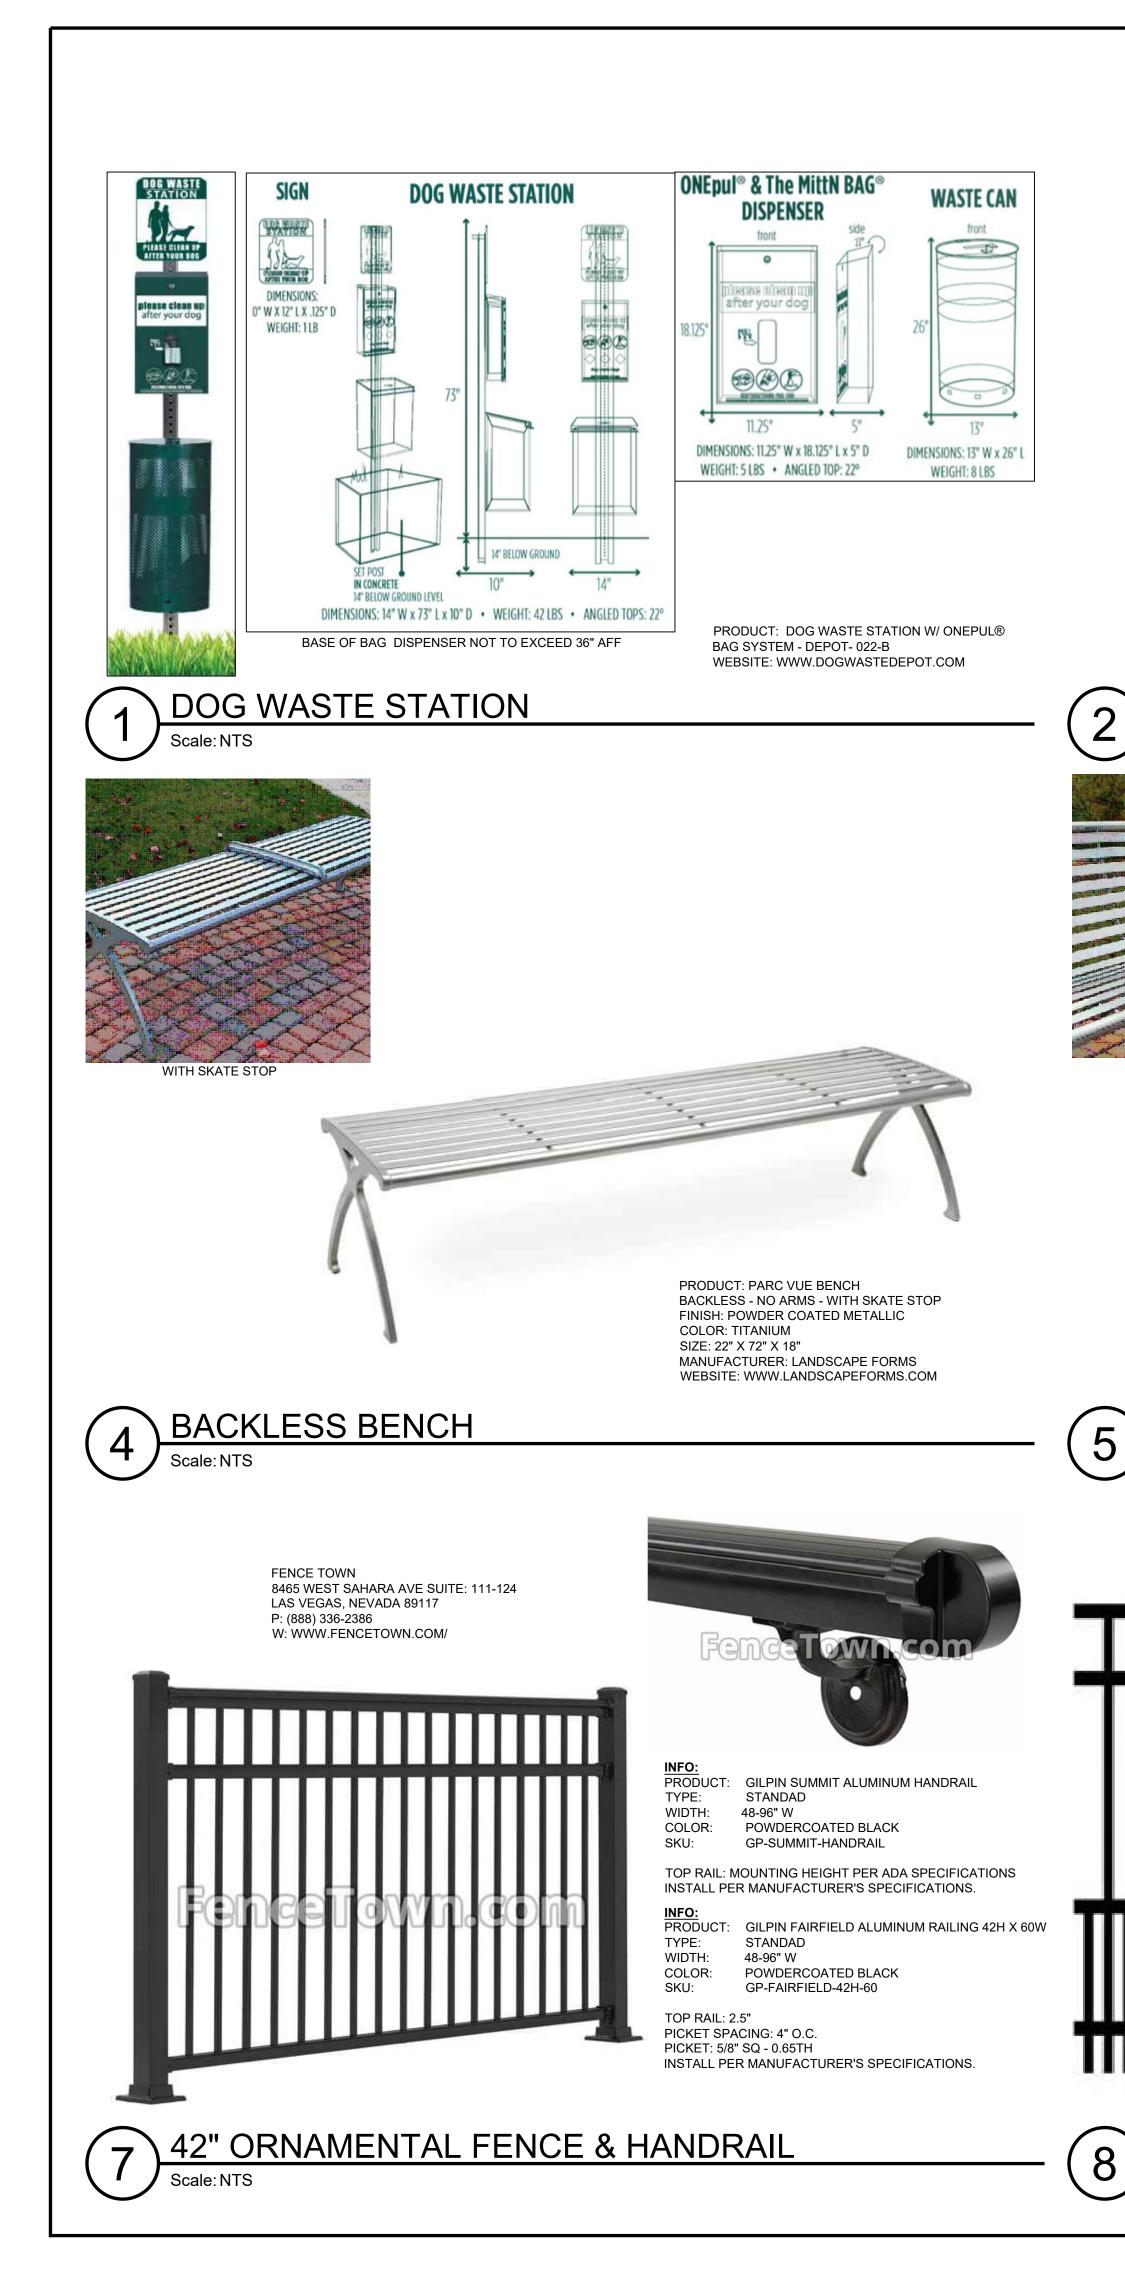






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GENERAL NOTES

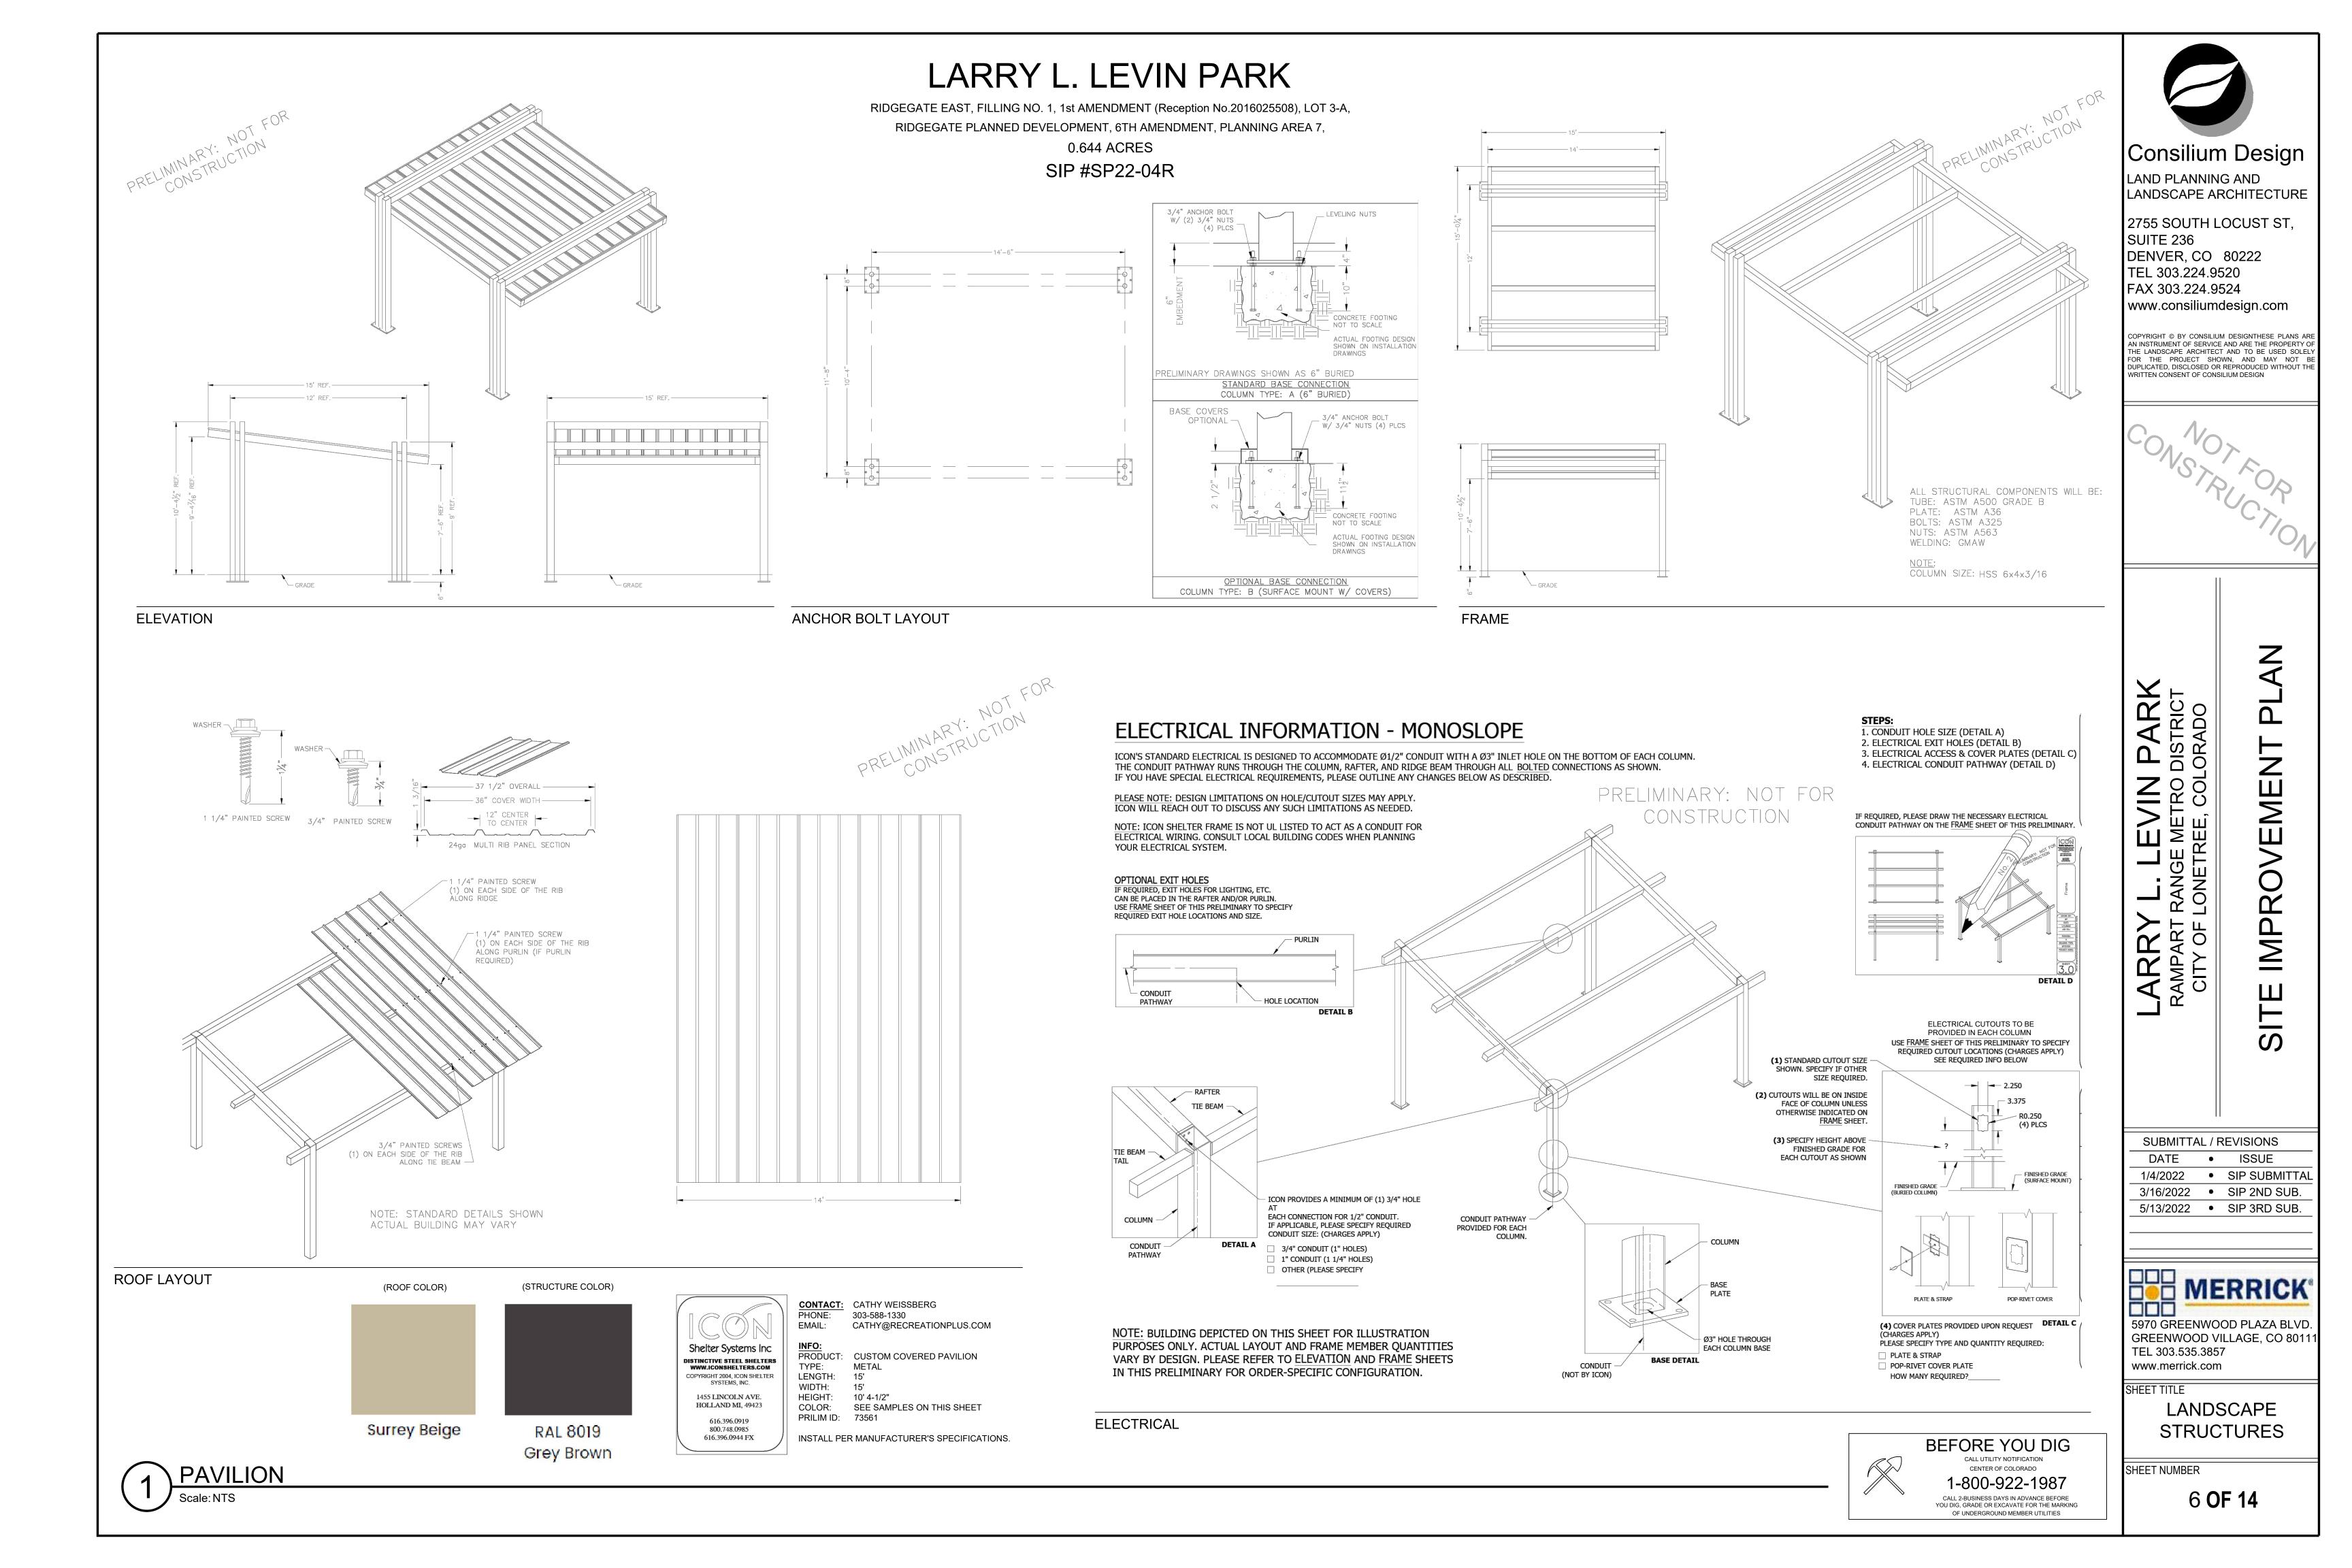1. ALL WORK SHALL CONFORM TO FEDERAL, STATE, CITY, AND COUNTY CODES. ALL WORK SHALL BE IN ACCORDANCE WITH OSHA CODES AND STANDARDS. NOTHING INDICATED ON THE LANDSCAPE DRAWINGS SHALL RELIEVE THE CONTRACTOR FROM COMPLYING WITH ANY APPROPRIATE SAFETY REGULATIONS.

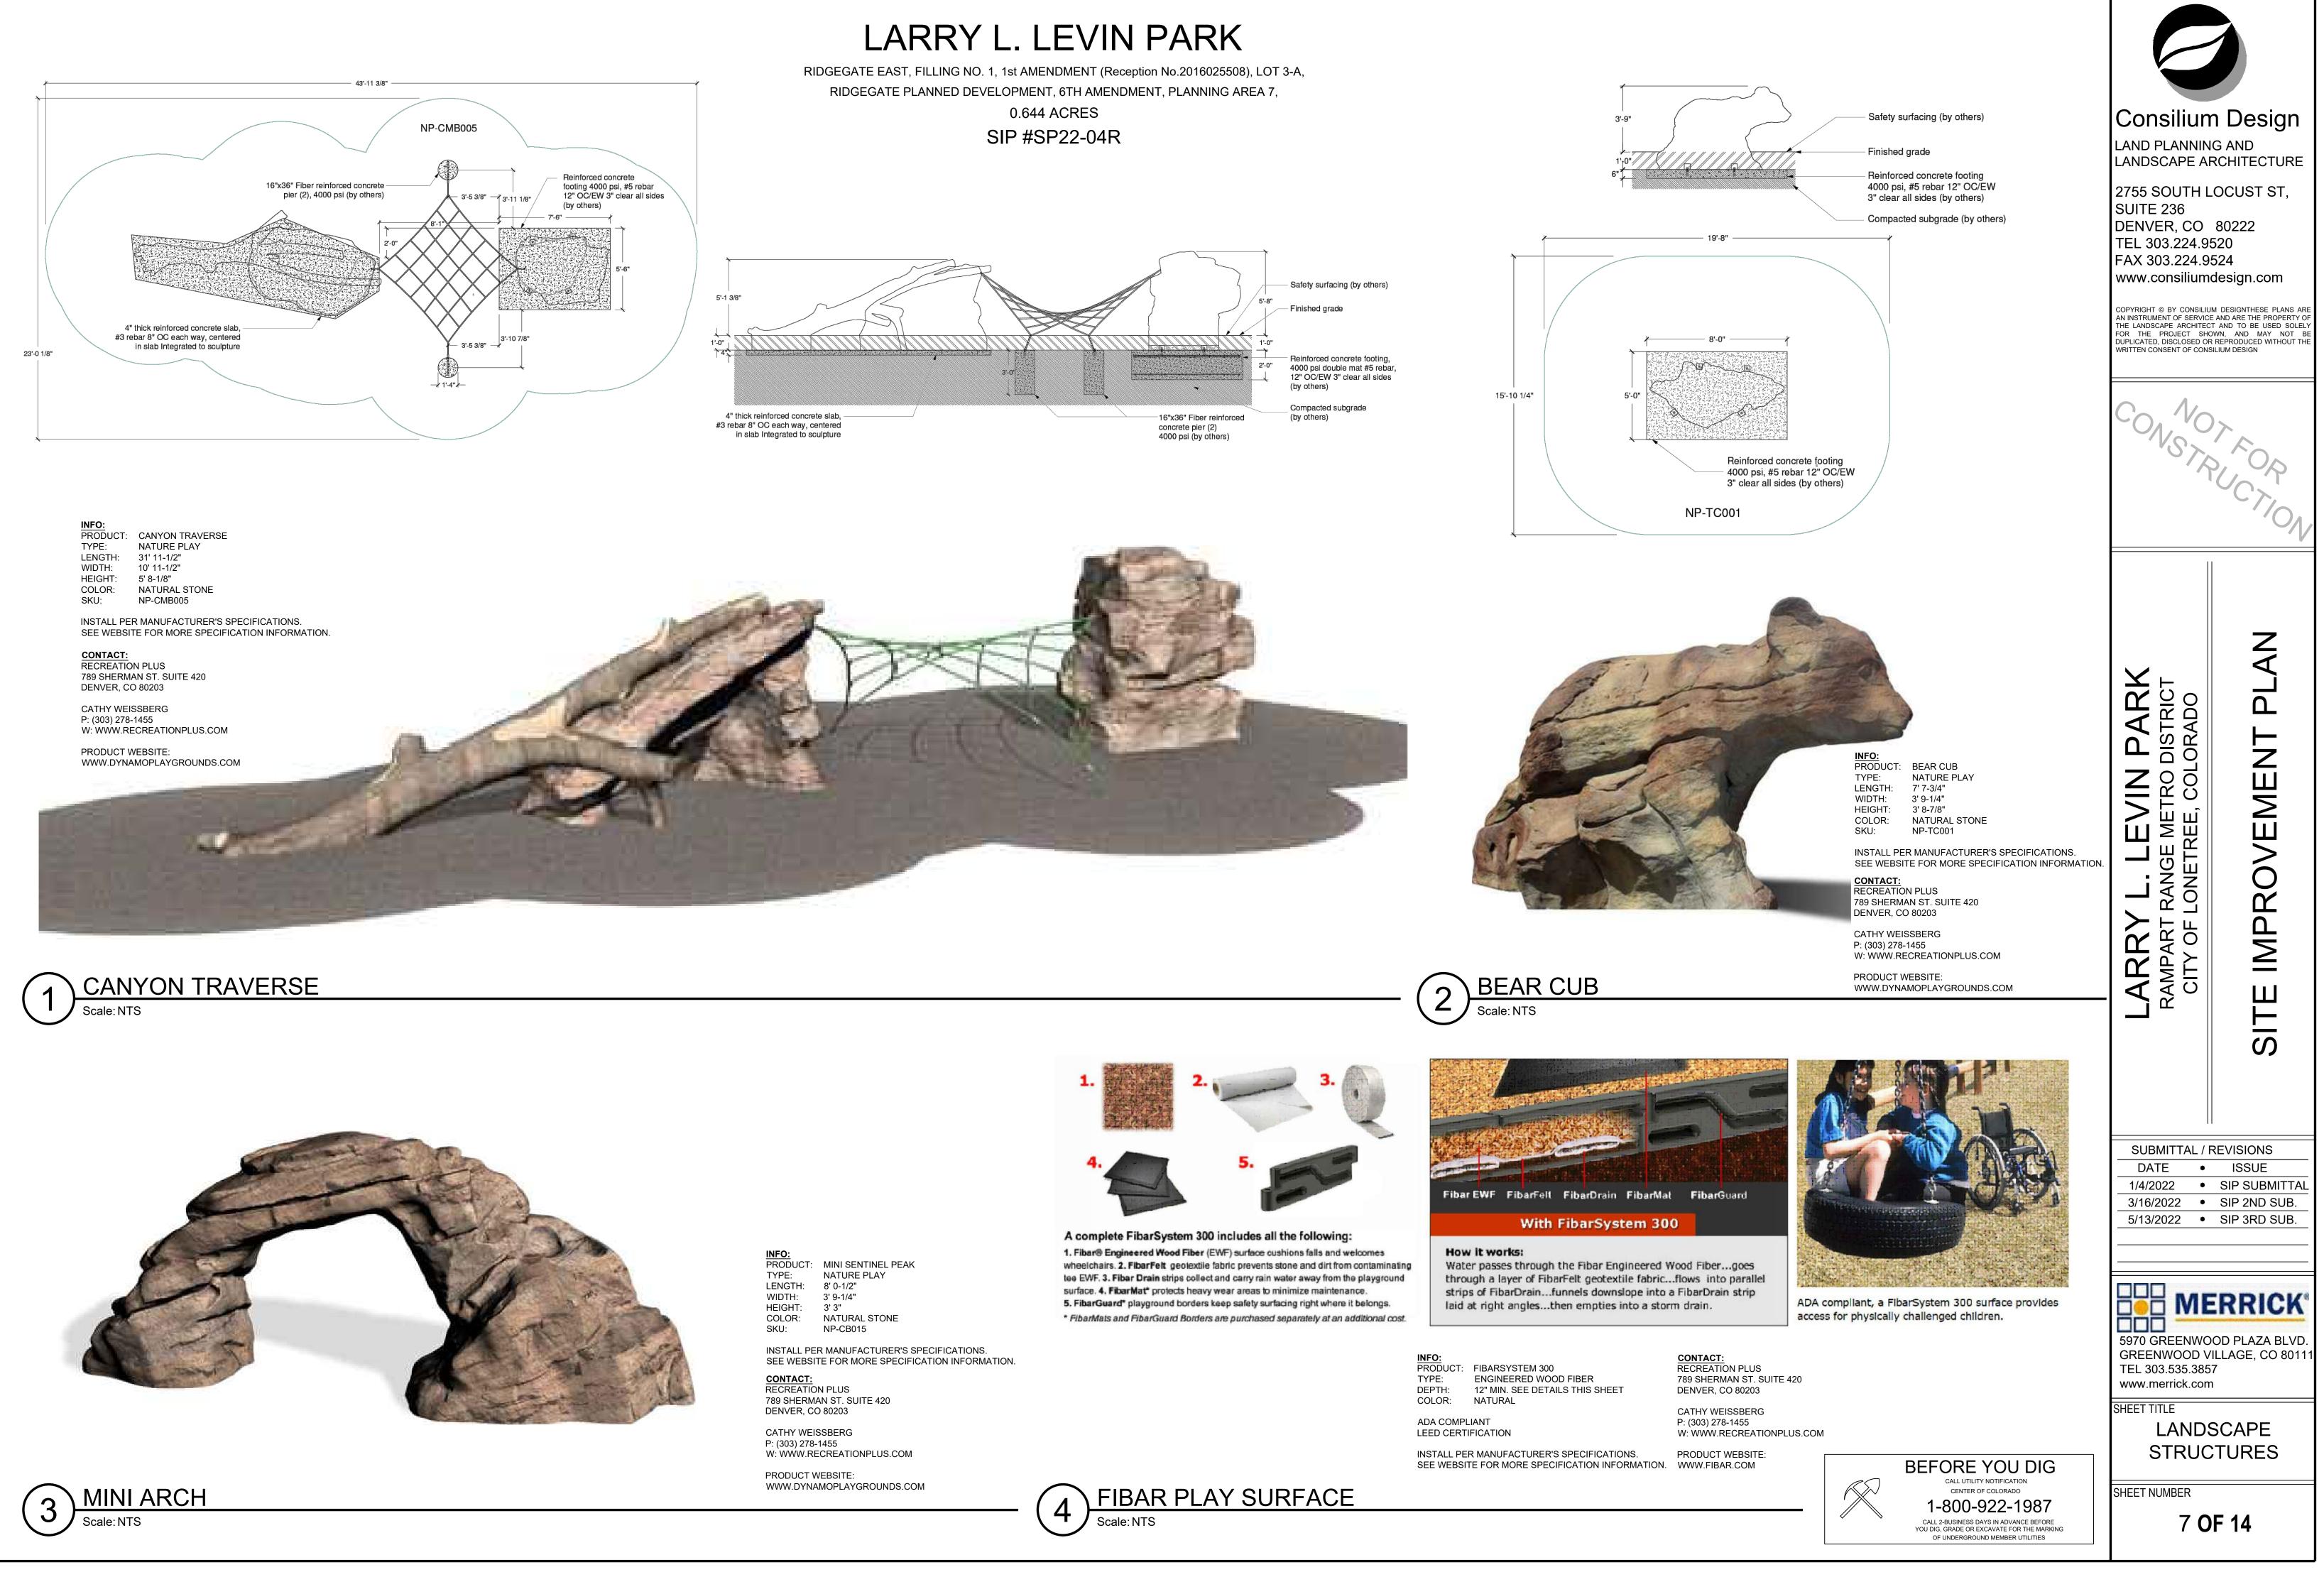2. THESE PLANS SHALL NOT BE UTILIZED FOR CONSTRUCTION OR PERMITTING UNLESS STATED FOR SUCH USE IN THE TITLE BLOCK.

3. DRAWINGS ARE INTENDED TO BE PRINTED ON 24" X 36" PAPER. PRINTING THESE DRAWINGS AT A DIFFERENT SIZE WILL IMPACT THE SCALE. VERIFY THE GRAPHIC SCALE BEFORE REFERENCING ANY MEASUREMENTS ON THESE SHEETS.

4. RECIPIENTS OF THESE DRAWINGS SHALL BE RESPONSIBLE FOR ANY ERRORS RESULTING FROM INCORRECT PRINTING, COPYING, OR ANY OTHER CHANGES THAT ALTER THE SCALE OF THE DRAWINGS.

5. VERIFY ALL PLAN DIMENSIONS PRIOR TO START OF CONSTRUCTION. NOTIFY THE OWNER'S REPRESENTATIVE TO ADDRESS ANY QUESTIONS OR CLARIFY ANY DISCREPANCIES.

6. WRITTEN DIMENSIONS TAKE PRECEDENCE OVER SCALED DIMENSIONS.

7. CONTRACTOR SHALL VERIFY (CALL FOR UTILITY LOCATES) LOCATION OF ALL EXISTING UTILITIES AND STRUCTURES PRIOR TO EXCAVATION OR TRENCHING. REFER TO ENGINEERING UTILITY PLANS FOR ALL PROPOSED UTILITY LOCATIONS AND DETAILS. NOTIFY OWNER'S REPRESENTATIVE IF EXISTING OR PROPOSED UTILITIES INTERFERE WITH THE ABILITY TO PERFORM WORK.

8. CONTRACTOR IS RESPONSIBLE FOR THE REPAIR OF ANY SETTLING DUE TO EXCAVATION AND TRENCHING.

9. CONTRACTOR SHALL PROTECT AND PRESERVE ALL EXISTING ADJACENT PROPERTY'S AMENITIES/ IMPROVEMENTS, UNLESS OTHERWISE NOTED.

10. CONTRACTOR SHALL REMOVE ALL DEBRIS FROM THE RIGHT-OF-WAY AND/ OR PUBLIC PROPERTY AT THE END OF EACH WORK DAY.

11. CONTRACTOR SHALL BE RESPONSIBLE FOR REPLACEMENT OF ANY DAMAGE DUE TO PROJECT'S CONSTRUCTION. CONTRACTOR SHALL BE RESPONSIBLE FOR THE COST OF REPAIR TO UTILITIES, ADJACENT LANDSCAPE, AND THE SUBCONTRACTOR'S OPERATIONS DURING CONSTRUCTION AND/ OR THE SPECIFIED MAINTENANCE PERIOD. THE CONTRACTOR SHALL FULLY COMPENSATE THE OWNER FOR ANYTHING DISTURBED AND/ OR DESTROYED THAT IS NOT DESIGNATED FOR DEMOLITION.

12. ALL UTILITY EASEMENTS SHALL REMAIN UNOBSTRUCTED AND FULLY ACCESSIBLE ALONG THEIR ENTIRE LENGTH FOR USE OF MAINTENANCE EQUIPMENT.

14. SUBMIT A CHANGE ORDER FOR APPROVAL FOR ANY CHANGES TO WORK SCOPE RESULTING FROM FIELD CONDITIONS OR DIRECTED BY OWNER'S REPRESENTATIVE WHICH REQUIRE ADDITIONAL COST TO THE OWNER PRIOR TO PERFORMANCE OF WORK.

15. THE CONTRACTOR SHALL PROVIDE A STAKED LAYOUT OF ALL SITE IMPROVEMENTS FOR INSPECTION BY THE OWNER'S REPRESENTATIVE AND MAKE MODIFICATIONS AS REQUIRED. ALL LAYOUT INFORMATION IS AVAILABLE IN DIGITAL FORMAT FOR USE BY THE CONTRACTOR.

16. THE CONTRACTOR SHALL BE RESPONSIBLE FOR ANY FINES OR PENALTIES ASSESSED TO THE OWNER RELATION TO ANY VIOLATIONS OR NON-CONFORMANCE WITH THE PLANS. SPECIFICATIONS. CONTRACT DOCUMENTS. JURISDICTIONAL CODES. AND REGULATORY AGENCIES.

17. CONTRACTOR IS RESPONSIBLE TO PAY FOR, AND OBTAIN, ANY REQUIRED APPLICATIONS, PERMITTING, LICENSES, INSPECTIONS AND METERS ASSOCIATED WITH WORK.

18. CONTRACTOR SHALL CONFIRM THAT SITE CONDITIONS ARE SIMILAR TO THE PLANS, WITHIN TOLERANCES STATED IN THE CONTRACT DOCUMENTS, AND SATISFACTORY TO THE CONTRACTOR PRIOR TO START OF WORK. SHOULD SITE CONDITIONS BE DIFFERENT THAN REPRESENTED ON THE PLANS OR UNSATISFACTORY TO THE CONTRACTOR. THE CONTRACTOR SHALL CONTACT THE OWNERS REPRESENTATIVE FOR CLARIFICATION AND FURTHER DIRECTION.

19. SITE TRIANGLES AND SIGHT LINES SHALL REMAIN UNOBSTRUCTED BY EQUIPMENT, CONSTRUCTION MATERIALS, PLANT MATERIAL OR ANY OTHER VISUAL OBSTACLE DURING THE CONTRACT PERIOD AND AT MATURITY OF PLANTS PER LOCAL JURISDICTIONAL REQUIREMENTS. NO PLANT MATERIAL OTHER THAN GROUND COVER IS ALLOWED TO BE PLANTED ADJACENT TO FIRE HYDRANTS AS STIPULATED BY JURISDICTIONAL REQUIREMENTS.

20. CONTRACTOR WILL BE RESPONSIBLE FOR PROTECTION OF THEIR MATERIAL STOCK PILES AND WORK FROM VANDALISM, EROSION OR UNINTENDED DISTURBANCE DURING THE CONSTRUCTION PERIOD AND UNTIL FINAL ACCEPTANCE IS ISSUED.

21. MAINTAIN ANY STORM WATER MANAGEMENT FACILITIES THAT EXIST ON SITE FOR FULL FUNCTIONALITY. THE CONTRACTOR SHALL INSTALL AND MAINTAIN ANY NEW STORM WATER MANAGEMENT FACILITIES THAT ARE IDENTIFIED IN THE SCOPE OF WORK TO FULL FUNCTIONALITY. THE CONTRACTOR SHALL BE RESPONSIBLE FOR ANY FINES OR PENALTIES ASSESSED TO THE OWNER FOR FAILURE TO MAINTAIN STORM WATER MANAGEMENT FACILITIES DURING THEIR CONTRACTED COURSE OF WORK.

22. THE CONTRACTOR SHALL PREVENT SEDIMENT, DEBRIS, AND ALL OTHER POLLUTANTS FROM EXITING THE SITE OR ENTERING THE STORM SEWER SYSTEM DURING ALL DEMOLITION OR CONSTRUCTION OPERATIONS THAT ARE PART OF THIS PROJECT. THE CONTRACTOR SHALL BE RESPONSIBLE FOR ANY FINES OR PENALTIES ASSESSED TO THE OWNER RELATING TO THESE REQUIREMENTS DURING THEIR CONTRACTED COURSE OF WORK.

23. THE CLEANING OF EQUIPMENT IS PROHIBITED AT THE JOB SITE UNLESS AUTHORIZED BY THE OWNER'S REPRESENTATIVE IN A DESIGNATED AREA. THE DISCHARGE OF WATER, WASTE CONCRETE, POLLUTANTS, OR OTHER MATERIALS SHALL ONLY OCCUR IN AREAS DESIGNED FOR SUCH USE AND APPROVED BY THE OWNER'S REPRESENTATIVE.

24. THE CLEANING OF CONCRETE IS PROHIBITED AT THE JOB SITE EXCEPT IN DESIGNATED CONCRETE WASHOUT AREAS. THE DISCHARGE OF WATER CONTAINING WASTE CONCRETE IN THE STORM SEWER IS PROHIBITED.

MAINTENANCE

- 1. WITH THE EXCEPTION OF WATERING FOR NEW PLANT ESTABLISHMENT, IRRIGATION SHALL BE SET FOR NIGHTTIME OR EARLY MORNING TO MINIMIZE EVAPORATIVE LOSS AND REDUCE CONFLICTS WITH PEDESTRIAN
- 2. WINTER WATERING OF TREES SHALL BE PROVIDED MONTHLY FOR THE FIRST THREE YEARS, AND IN SUBSEQUENT YEARS DURING DROUGHT PERIODS, AS DESIGNATED BY THE NATIONAL INTEGRATED DROUGHT INFORMATION SYSTEM.

SOIL AMENDMENT

- 1. ALL SOILS FOR GENERAL LANDSCAPING AREAS OR ON WHICH ANY COOL-SEASON LAWN, TURF OR SOD IS TO BE INSTALLED MUST BE PROPERLY AMENDED WITH ORGANIC MATTER SUCH AS COMPOST AND AGED MANURE. A MINIMUM OF FOUR (4) CUBIC YARDS OF COMPOST PER EACH ONE THOUSAND (1,000) SQUARE FEET OF SOIL SHOULD BE INCORPORATED TO A DEPTH OF AT LEAST FOUR (4) TO SIX (6) INCHES BY ROTOTILLING OR OTHER SUITABLE MEASURE. SOIL AMENDMENTS FOR NATIVE PLANTS AND GRASSES ARE NOT REQUIRED.
- 2. STRUCTURED SOILS THAT INCLUDE ROCK AND SAND TO REDUCE COMPACTION AND INCREASE POROSITY FOR ROOT GROWTH MAY BE REQUIRED WHERE TREE GRATES ARE PROPOSED.

MULCH AND GROUNDCOVERS

- 1. ORGANIC MULCH SUCH AS WOOD/BARK SHALL BE INSTALLED AND MAINTAINED TO A DEPTH OF FOUR (4) INCHES. ROCK MULCH IS DISCOURAGED AS MULCH EXCEPT IN AREAS OF HIGH WINDS OR AREAS PRONE TO EROSION AS EVALUATED BY THE COMMUNITY DEVELOPMENT DEPARTMENT. WHERE ROCK MULCH IS USED, PLACE TO A DEPTH OF THREE (3) INCHES. THE USE OF IMPERMEABLE SHEET PLASTIC AS A WEED BARRIER IS NOT PERMITTED.
- 2. COBBLE: 3"-4" COBBLE TO BE TRI-COLOR STONE. PREDOMINATELY GRAY AND TAN WITH MINIMAL RED. USE IN AREAS SHOWN ON PLANS TO REDUCE EROSION AND RUN-OFF VELOCITY IN DRAIN DAY-LIGHTING AREAS. INSTALL AND MAINTAIN TO A DEPTH OF FOUR (4) INCHES. SEE #1 ABOVE FOR WEED BARRIER INFORMATION. METAL EDGING NOT REQUIRED.

2. THE OWNER'S REPRESENTATIVE RESERVES THE RIGHT TO INSPECT AND TAG ALL PLANT MATERIAL PRIOR TO SHIPPING TO THE SITE. IN ALL CASES, THE OWNER'S REPRESENTATIVE MAY REJECT PLANT MATERIAL AT THE SITE IF MATERIAL IS DAMAGED. DISEASED, OR DECLINING IN HEALTH AT THE TIME OF ONSITE INSPECTIONS OR IF THE PLANT MATERIAL DOES NOT MEET THE MINIMUM SPECIFIED STANDARD IDENTIFIED ON THE PLANS AND IN THE SPECIFICATIONS. THE CONTRACTOR SHALL COORDINATE WITH THE OWNER'S REPRESENTATIVE FOR INSPECTION AND APPROVAL OF ALL MATERIALS AND PRODUCTS PRIOR TO INSTALLATION.

3. REFER TO IRRIGATION PLANS FOR LIMITS AND TYPES OF IRRIGATION DESIGNED FOR THE LANDSCAPE. IN NO CASE SHALL IRRIGATION BE EMITTED WITHIN THE MINIMUM DISTANCE FROM BUILDING OR WALL FOUNDATIONS AS STIPULATED IN THE GEOTECHNICAL REPORT. ALL IRRIGATION DISTRIBUTION LINES, HEADS AND EMITTERS SHALL BE KEPT OUTSIDE THE MINIMUM DISTANCE AWAY FROM ALL BUILDING AND WALL FOUNDATIONS AS STIPULATED IN THE GEOTECHNICAL REPORT.

4. LANDSCAPE MATERIAL LOCATIONS SHALL HAVE PRECEDENCE OVER IRRIGATION MAINLINE AND LATERAL LOCATIONS. COORDINATE INSTALLATION OF IRRIGATION EQUIPMENT SO THAT IT DOES NOT INTERFERE WITH THE PLANTING OF TREES OR OTHER LANDSCAPE MATERIAL.

5. THE LANDSCAPE CONTRACTOR SHALL BE RESPONSIBLE FOR ENSURING POSITIVE DRAINAGE EXISTS IN ALL LANDSCAPE AREAS. SURFACE DRAINAGE ON LANDSCAPE AREAS SHALL NOT FLOW TOWARD STRUCTURES AND FOUNDATION. MAINTAIN SLOPE AWAY FROM FOUNDATIONS PER THE GEOTECHNICAL REPORT RECOMMENDATIONS. ALL LANDSCAPE AREAS BETWEEN WALKS AND CURBS SHALL DRAIN FREELY TO THE CURB UNLESS OTHERWISE IDENTIFIED ON THE GRADING PLAN. IN NO CASE SHALL THE GRADE, TURF THATCH, OR OTHER LANDSCAPE MATERIAL DAM WATER AGAINST WALKS. MINIMUM SLOPES ON LANDSCAPE SHALL BE 2%: MAXIMUM SLOPE SHALL BE 25% UNLESS SPECIFICALLY IDENTIFIED ON THE PLANS OR APPROVED BY THE OWNER'S REPRESENTATIVE.

6. TREES SHALL NOT BE LOCATED IN DRAINAGE SWALES, DRAINAGE AREAS, OR UTILITY EASEMENTS. CONTACT OWNER'S REPRESENTATIVE FOR RELOCATION OF PLANTS IN QUESTIONABLE AREAS PRIOR TO INSTALLATION.

8. TO THE MAXIMUM EXTENT FEASIBLE, TOPSOIL THAT IS REMOVED PRIOR TO CONSTRUCTION SHALL BE COLLECTED. SAVED. AND PROTECTED FOR LATER USE ON AREAS REQUIRING REVEGETATION (SEED) AND/ OR LANDSCAPING.

9. ALL TURF AND BED AREAS SHALL RECEIVE ORGANIC SOIL PREPARATION AT A RATE OF (4) FOUR CUBIC YARDS PER 1000 SQUARE FEET TILLED TO A DEPTH OF 6 INCHES OR AS NOTED IN THE TECHNICAL SPECIFICATIONS. ALL SEEDED AREAS SHALL RECEIVE ORGANIC SOIL PREPARATION AT A RATE RATE RECOMMENDED BY SEED PRODUCER. SEE TECHNICAL SPECIFICATIONS FOR ADDITIONAL INFORMATION.

10. PRIOR TO INSTALLING OF PLANT MATERIALS, ALL AREAS THAT HAVE BEEN COMPACTED OR DISTURBED BY CONSTRUCTION ACTIVITY SHALL BE THOROUGHLY LOOSENED, REPAIRED AND SEEDED IF NECESSARY. SEE SPECIFIED SEED MIX INFORMATION.

11. THE CONTRACTOR IS EXPECTED TO KNOW AND UNDERSTAND THE CITY AND COUNTY'S SPECIFICATIONS FOR LANDSCAPE AND IRRIGATION. IN CASES OF DISCREPANCIES THE HIGHER OF THE TWO STANDARDS SHALL HAVE PRECEDENCE (SPECIFICATIONS AND DETAILS PROVIDED WITH THE PLANS VERSUS THE CITY AND COUNTY'S SPECIFICATIONS AND DETAILS).

12. ALL PLANTS OF THE SAME SPECIES AND SIZE SHALL HAVE MATCHING HEIGHT AND FORM, UNLESS OTHERWISE NOTED. ALL PLANTS SHALL CONFORM TO THE "AMERICAN STANDARD FOR NURSERY STOCK."

13. THE CONTRACTOR IS RESPONSIBLE FOR VERIFYING ALL PLANT QUANTITIES. GRAPHIC SYMBOLS ON LANDSCAPE DRAWINGS TAKES PRECEDENCE OVER WRITTEN PLANT QUANTITIES.

14. ALL PLANTS SHALL BE PLANTED USING AN EQUALLY SPACED TRIANGULAR PATTERN, UNLESS OTHERWISE NOTED AND/ OR SHOWN ON THE LANDSCAPE DRAWINGS.

15. ALL PLANTS INSTALLED SHALL FOLLOW THE PLANT SCHEDULE ON THE APPROVED LANDSCAPE DRAWINGS. SUBSTITUTIONS MUST BE APPROVED BY THE LANDSCAPE ARCHITECT.

16. CONTRACTOR SHALL REPORT ANY DISCREPANCY FOUND IN THE FIELD VERSUS THE LANDSCAPE DRAWINGS IMMEDIATELY TO THE LANDSCAPE ARCHITECT AND/ OR OWNER'S REPRESENTATIVE PRIOR TO ANY CONSTRUCTION OR DEMOLITION ACTIVITY. FAILURE TO MAKE SUCH CONFLICTS KNOWN WILL RESULT IN THE CONTRACTOR'S LIABILITY TO RELOCATE OR RFPAIR

17. THE FINAL LOCATION OF ALL PLANTS SHALL BE SUBJECT TO THE APPROVAL OF THE OWNER'S REPRESENTATIVE PRIOR TO INSTALLATION.

18. CONTRACTOR SHALL PROVIDE AT LEAST A ONE YEAR WARRANTY FOR ALL PLANT MATERIAL FROM THE DATE OF FINAL INSPECTION, UNLESS OTHERWISE DIRECTED BY LANDSCAPE ARCHITECT AND/OR OWNER.

21. ALL TREES ARE TO BE STAKED WITH WOOD STAKES AND GUYED FOR A PERIOD OF ONE YEAR PER THE DETAILS. THE CONTRACTOR SHALL BE RESPONSIBLE FOR REMOVING WOOD STAKES AT THE END OF 1 YEAR FROM ACCEPTANCE OF LANDSCAPE INSTALLATION BY THE OWNER'S REPRESENTATIVE. OBTAIN APPROVAL BY OWNER'S REPRESENTATIVE PRIOR TO

REMOVAL.

WORK.

23. TREE WRAP SHALL BE APPLIED IN LATE FALL AFTER INSTALLATION AND REMOVED THE FOLLOWING SPRING. TREES GREATER THAN 4" IN CALIPER MAY NOT REQUIRE TREE WRAP IF BARK IS SUFFICIENTLY DEVELOPED. OBTAIN APPROVAL FROM OWNER'S REPRESENTATIVE FOR ANY TREES THAT WILL NOT BE WRAPPED.

24. CONTRACTOR SHALL OBTAIN SOIL SAMPLES FROM A MINIMUM OF 5 SUITABLE LOCATIONS AND SUBMIT SAMPLES TO A STATE-LICENSED SOIL TESTING LABORATORY, SUCH AS COLORADO ANALYTICAL OR COLORADO STATE UNIVERSITY SOILS LAB, SPECIALIZING IN THE ANALYSIS OF SOIL AND IN MAKING RECOMMENDATIONS FOR THE INTRODUCTION OF ORGANIC AMENDMENTS IN LANDSCAPE PLANTING AREAS. THE RESULTS OF THE SOIL ANALYSIS AND RECOMMENDATIONS SHALL BE FORWARDED TO THE OWNER'S REPRESENTATIVE ALONG WITH THE CONTRACTOR'S RECOMMENDATIONS FOR SOIL AMENDMENT MATERIALS AND QUANTITIES.



SOD BLEND: FESCUES AND OTHER DROUGHT TOLERANT VARIETIES SUN: FULL SUN TO 60% SHADE MOWING HEIGHT: 2" TO 5" **INFORMATION:** TURF MASTER ENVIROTURF[™] IS A PATENTED AND PROPRIETARY TURF BLEND THAT IS EXTRA DURABLE AND DROUGHT TOLERANT TO HELP CONSERVE OUR NATURAL RESOURCES AND STILL PROVIDE A HIGH-QUALITY GROUNDCOVER.

ENVIROTURF™ IS BLENDED TO IMPROVE TURF QUALITY ON YOUR TOUGHEST SITES SUCH AS PARKS, SPORTS FIELDS, COMMERCIAL SITES, GOLF COURSE ROUGHS, AND BACKYARDS. IT THRIVES AT COLD HIGH ALTITUDES AS WELL AS THE DRY SUNNY CONDITIONS OF THE ROCKY MOUNTAIN PLAINS. IT PROVIDES HIGH QUALITY, DURABLE PLAYING SURFACES. YET, IT WILL STILL GIVE YOU A LOWER WATER AND FERTILIZING COSTS.

IT IS A VERY DENSE, HARDY BLEND OF TURF. WITHIN THE FIRST 18 MONTHS OF ESTABLISHMENT, TURF MASTER ENVIROTURF CAN USE 30%-40% LESS WATER THAN KENTUCKY BLUEGRASS. IT CONTAINS ENDOPHYTES WHICH ARE THE BEST NATURAL WAY TO WARD OFF INSECTS. IT IS DEEP ROOTING, WHICH MAKES IT A MORE DROUGHT TOLERANT PLANT. IT THRIVES IN SUN OR SHADE, MAKING IT ADAPTABLE TO EVERY SITUATION. THIS LOWER MAINTENANCE TURF USES 50% LESS NITROGEN THAN KENTUCKY BLUEGRASS. IT IS A DURABLE TURFGRASS WHICH IS IDEAL FOR AREAS OF HIGH TRAFFIC AND WEAR.

LARRY L. LEVIN PARK

RIDGEGATE EAST, FILLING NO. 1, 1st AMENDMENT (Reception No.2016025508), LOT 3-A, RIDGEGATE PLANNED DEVELOPMENT, 6TH AMENDMENT, PLANNING AREA 7

0.644 ACRES SIP #SP22-04R

PLANTING NOTES

1. WEED FABRIC SHALL NOT BE INSTALLED IN PLANTING BEDS UNLESS SPECIFICALLY SPECIFIED ON PLANS. PLANTING DESIGN IS INTENDED TO ALLOW PLANTS TO SPREAD THROUGHOUT PLANTING BEDS.

7. ALL EXISTING TREES SHALL BE SAVED AND PROTECTED (TRANSPLANTED IF NECESSARY), UNLESS OTHERWISE NOTED.

19. ALL PLANTS SHALL BE WATERED, CARED FOR, AND PROTECTED FROM DAMAGING WEATHER EFFECTS WHEN NECESSARY.

20. ALL PLANTS SHALL BE INSTALLED IMMEDIATELY UPON DELIVERY TO THE PROJECT SITE. IF THIS IS NOT POSSIBLE, PLANTS SHALL BE HEELED IN AND WATERED TO HELP PREVENT ANY DAMAGE.


22. ALL TREES INSTALLED ABOVE RETAINING WALLS UTILIZING GEO-GRID MUST BE HAND DUG TO PROTECT GEO-GRID. IF GEO-GRID MUST BE CUT TO INSTALL TREES, APPROVAL MUST BE GIVEN BY OWNER'S REPRESENTATIVE PRIOR TO DOING


MAKE: TURF MASTER ENVIROTURF™


TURF MASTER LLC 3327 N Gidding Road Fort Collins, CO 80524 W: www.turfmastersod.com/enviroturf P: (970) 493-8311

Scale: 1/2" = 1' - 0"

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PREVAILING WINDS

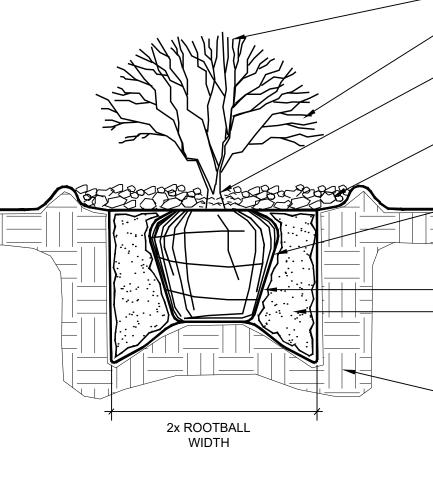- DO NOT CUT CENTRAL LEADER - PRUNE ALL DEAD OR DAMAGED WOOD PRIOR TO PLANTING

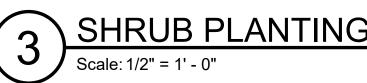- 4" TREE WRAP (APPLY IN WINTER

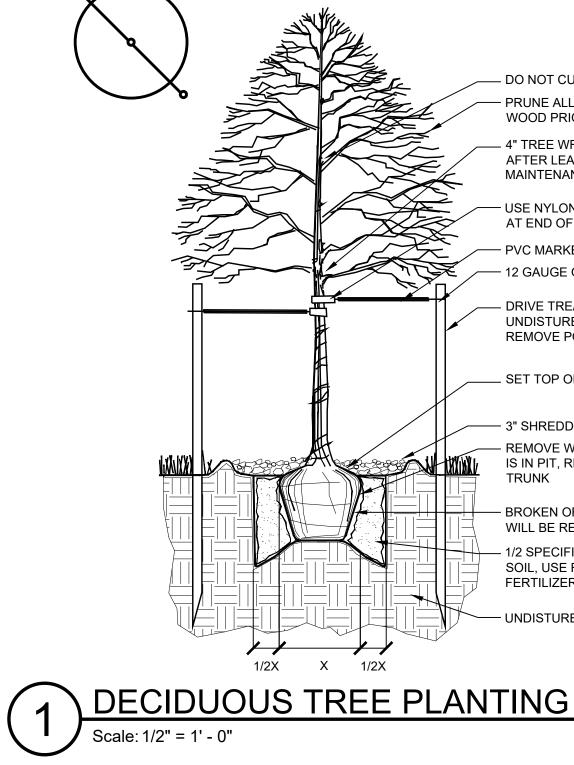AFTER LEAVES DROP), REMOVE PER

MAINTENANCE AGREEMENT WITH OWNER

- USE NYLON TREE STRAPS

AT END OF EACH WIRE — PVC MARKERS TYP

- DRIVE TREATED WOOD POST 30" INTO UNDISTURBED GRADE, 2 PER TREE REMOVE POSTS 1 YEAR AFTER PLANTING

__ SET TOP OF ROOTBALL 2" ABOVE FINISHED GRADE — 3" SHREDDED WOOD MULCH IN TREE WELL

- REMOVE WIRE BASKET AFTER TREE IS IN PIT, REMOVE TWINE AND PULL BURLAP FROM TREE TRUNK

- BROKEN OR DAMAGED ROOTBALLS WILL BE REJECTED

1/2 SPECIFIED BACKFILL MIX & 1/2 PIT SOIL, USE ROOT STIMULATOR & RELEASE FERTILIZER FOR NEW PLANTING

UNDISTURBED SUBGRADE

– DO NOT CUT CENTRAL LEADER PRUNE ALL DEAD OR DAMAGED WOOD PRIOR TO PLANTING

USE NYLON TREE STRAPS AT END OF EACH WIRE, GUY TO MID POINT OF TREE

- 12 GAUGE GALVANIZED WIRE

- SET TOP OF ROOTBALL 4" ABOVE FINISHED GRADE IN IRRIGATED AREAS & 2" ABOVE GRADE IN NON-IRRIGATED AREAS

7 3" SHREDDED WOOD MULCH IN TREE WELL

INSTALL A 5" HIGH BERM AROUND TREES TO CREATE A WATERING BASIN. BERM IS TEMPORARY IN IRRIGATED AREAS, REMOVE AFTER 2 THOROUGH WATERINGS, ADD MULCH. LEAVE BERM AND MULCH IN NON-IRRIGATED AREAS.

PVC MARKERS TYP.

DRIVE 30" T STAKES INTO UNDISTURBED GRADE. 3 PER TREE, FLUSH TO GRADE. REMOVE POSTS 1 YEAR AFTER PLANTING

- REMOVE WIRE BASKET AFTER TREE IS IN PIT, REMOVE TWINE AND PULL BURLAP FROM TREE TRUNK

BROKEN OR DAMAGED ROOTBALLS WILL BE REJECTED

1/2 SPECIFIED BACKFILL MIX & 1/2 PIT SOIL, USE ROOT STIMULATOR & RELEASE FERTILIZER FOR NEW PLANTING

- UNDISTURBED SUBGRADE

EVERGREEN TREE PLANTING

- SPACE PLANTS FOR BEST EFFECT - PRUNE DEAD OR DAMAGED WOOD PRIOR TO PLANTING

- SET SHRUB PLUMB, TOP OF ROOTBALL MATCH FINISH GRADE, 2" ABOVE GRADE FOR EVERGREENS.

- 3" DEEP SHREDDED WOOD MULCH. BUILD AS 4" BASIN IN NON-IRRIGATED AREAS ONLY.

- REMOVE ALL CONTAINERS, BASKETS, WIRE ETC. FROM ROOTBALL. BROKEN OR DAMAGED ROOTBALLS WILL BE REJECTED.

 LOOSEN SIDES OF ROOTBALL - 1/2 SPECIFIED BACKFILL MIX & 1/2 PIT SOIL. MOUND COMPACTED BACKFILL UNDER ROOTBALL, OR SET ON UNDISTURBED SOIL.

CALL UTILITY NOTIFICATION

CENTER OF COLORADO

1-800-922-1987

CALL 2-BUSINESS DAYS IN ADVANCE BEFORE

YOU DIG, GRADE OR EXCAVATE FOR THE MARKING

OF UNDERGROUND MEMBER UTILITIES

– UNDISTURBED SUBGRADE



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Consilium Design

LANDSCAPE ARCHITECTURE

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SUBMITTAL / REVISIONS DATE • ISSUE 1/4/2022 • SIP SUBMITTA 3/16/2022 • SIP 2ND SUB. 5/13/2022 • SIP 3RD SUB



5970 GREENWOOD PLAZA BLVD GREENWOOD VILLAGE, CO 8011 TEL 303.535.3857 www.merrick.com


SHEET TITLE

LANDSCAPE NOTES

8 **OF 14**

SHEET NUMBER

	IRRIGATION SCHEDULE						
SYMBOL	DESCRIPTION	DETAIL NO.					
(A)	ELECTRIC CONTROLLER	2					
Ŵ	WEATHER SENSOR DEVICE	6					
	RP BACKFLOW PREVENTER	1					
	PVC MAINLINE	3					
	PVC SLEEVING	4					
	HOSE BIB	5					
M	WATER METER	BY OTHERS					

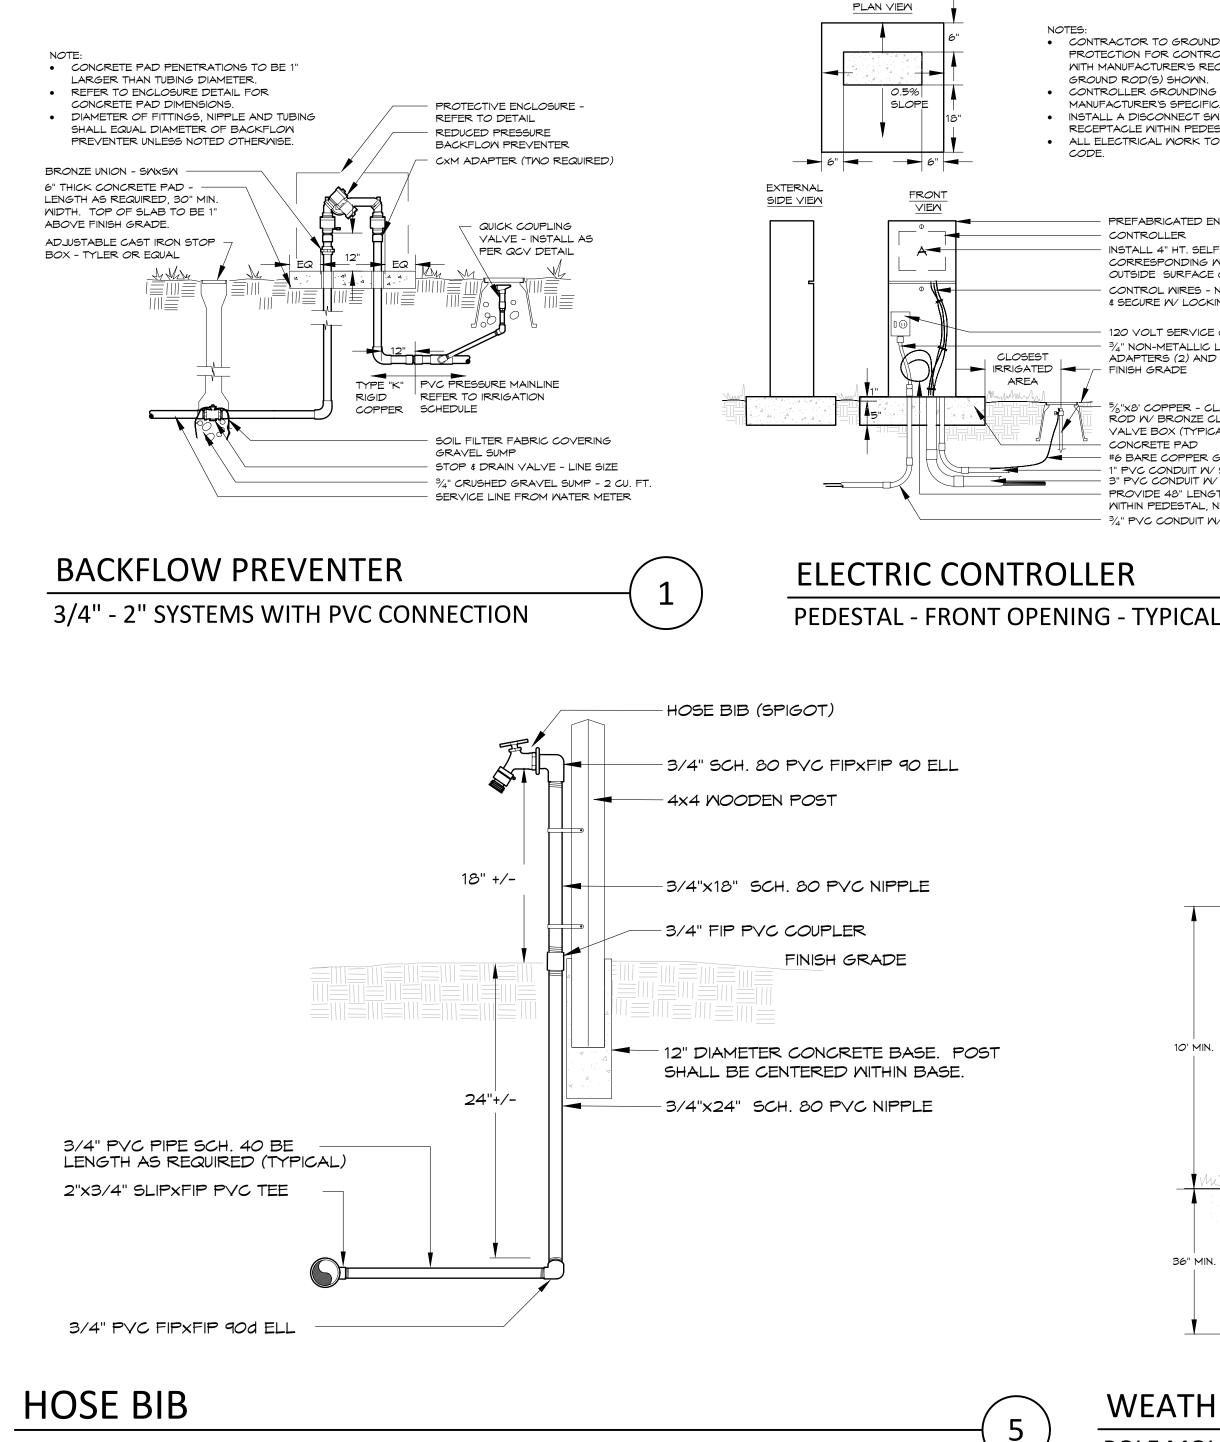

LARRY L. LEVIN PARK


RIDGEGATE EAST, FILLING NO. 1, 1st AMENDMENT (Reception No.2016025508), LOT 3-A,

RIDGEGATE PLANNED DEVELOPMENT, 6TH AMENDMENT, PLANNING AREA 7,

0.644 ACRES

SIP #SP22-04R

	IRRIC	GATION DESIGN	I STRATEGY	
HATCH	DESCRIPTION	AREAS < 6'	AREAS 6'-25'	AREAS > 25'
· · · · · · · · · · · · · · · · · · ·	TURF GRASS	INLINE SUBSURFACE DRIP	6" POPUP SPRAY	6" ROTOR
	TREES & SHRUBS	POINT SOURCE DRIP	POINT SOURCE DRIP	POINT SOURCE DRIP
	POINT SOURCE DRIP OR INL HER THAN AREA DIMENSIONS	INE SUBSURFACE DRIP MAY B	E DETERMINED BY PLANT DE	ENSITY, GROWTH HABIT OR

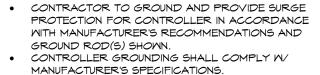

- INSTALL A DISCONNECT SWITCH AND 120 VOLT GFIC RECEPTACLE WITHIN PEDESTAL.
- ALL ELECTRICAL WORK TO CONFORM TO LOCAL CODE

PREFABRICATED ENCLOSURE CONTROLLER

INSTALL 4" HT. SELF ADHESIVE VINYL LETTERING CORRESPONDING WITH CONTROLLER # ON OUTSIDE SURFACE OF ENCLOSURE DOOR. CONTROL WIRES - NEATLY BUNDLE WIRING & SECURE W/ LOCKING WIRE TIES

120 VOLT SERVICE GFI & POWER SWITCH $\frac{3}{4}$ " NON-METALLIC LIQUIDTITE CONDUIT W/ MALE ADAPTERS (2) AND LOCK RINGS, WASHERS FINISH GRADE

AREA

 $\frac{5}{8}$ "x8' COPPER - CLAD GROUNDING ROD W/ BRONZE CLAMP & 10" ROUND VALVE BOX (TYPICAL) CONCRETE PAD #6 BARE COPPER GROUNDING WIRE - 3" PVC CONDUIT W/ SWEEP ELL - CONTROL WIRES


PROVIDE 48" LENGTH OF ALL SPARE WIRES WITHIN PEDESTAL, NEATLY COILED. 3/4" PVC CONDUIT W/ SWEEP ELL - 120V SERVICE

10' MIN.

36" MIN.



24" MAINLINE

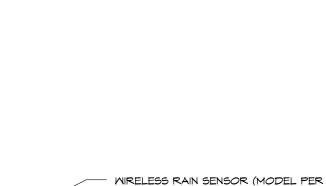

2

SCHEDULE) - TOP OF SENSOR TO BE ABOVE RAIN SHADOW OF BUILDING GUTTERS, TREES AND/OR ANY OTHER OBSTRUCTIONS $1\frac{1}{2}$ "x $\frac{1}{2}$ " FxF SCH. 40 GALVANIZED TEE W/ 11/2" MIPT PLUG $1\frac{1}{2}$ " DIAMETER SCH. 40 GALVANIZED STEEL POST


MAN IN MANANY FINISH GRADE 12" DIAMETER CONCRETE BASE - FORM W/ SONA-TUBE OR EQUAL. POST SHALL BE CENTERED WITHIN BASE. NOTE: MOUNT RAIN SENSOR RECEIVER PER CONTROLLER DETAIL.




WEATHER SENSOR **POLE MOUNTED - Wireless**





Know what's below. Call before you dig. CALL 3 BUSINESS DAYS IN ADVANCE BEFORE YOU DIG GRADE OR EXCAVATE FOR THE MARKING OF UNDERGROUND MEMBER UTILITIES.

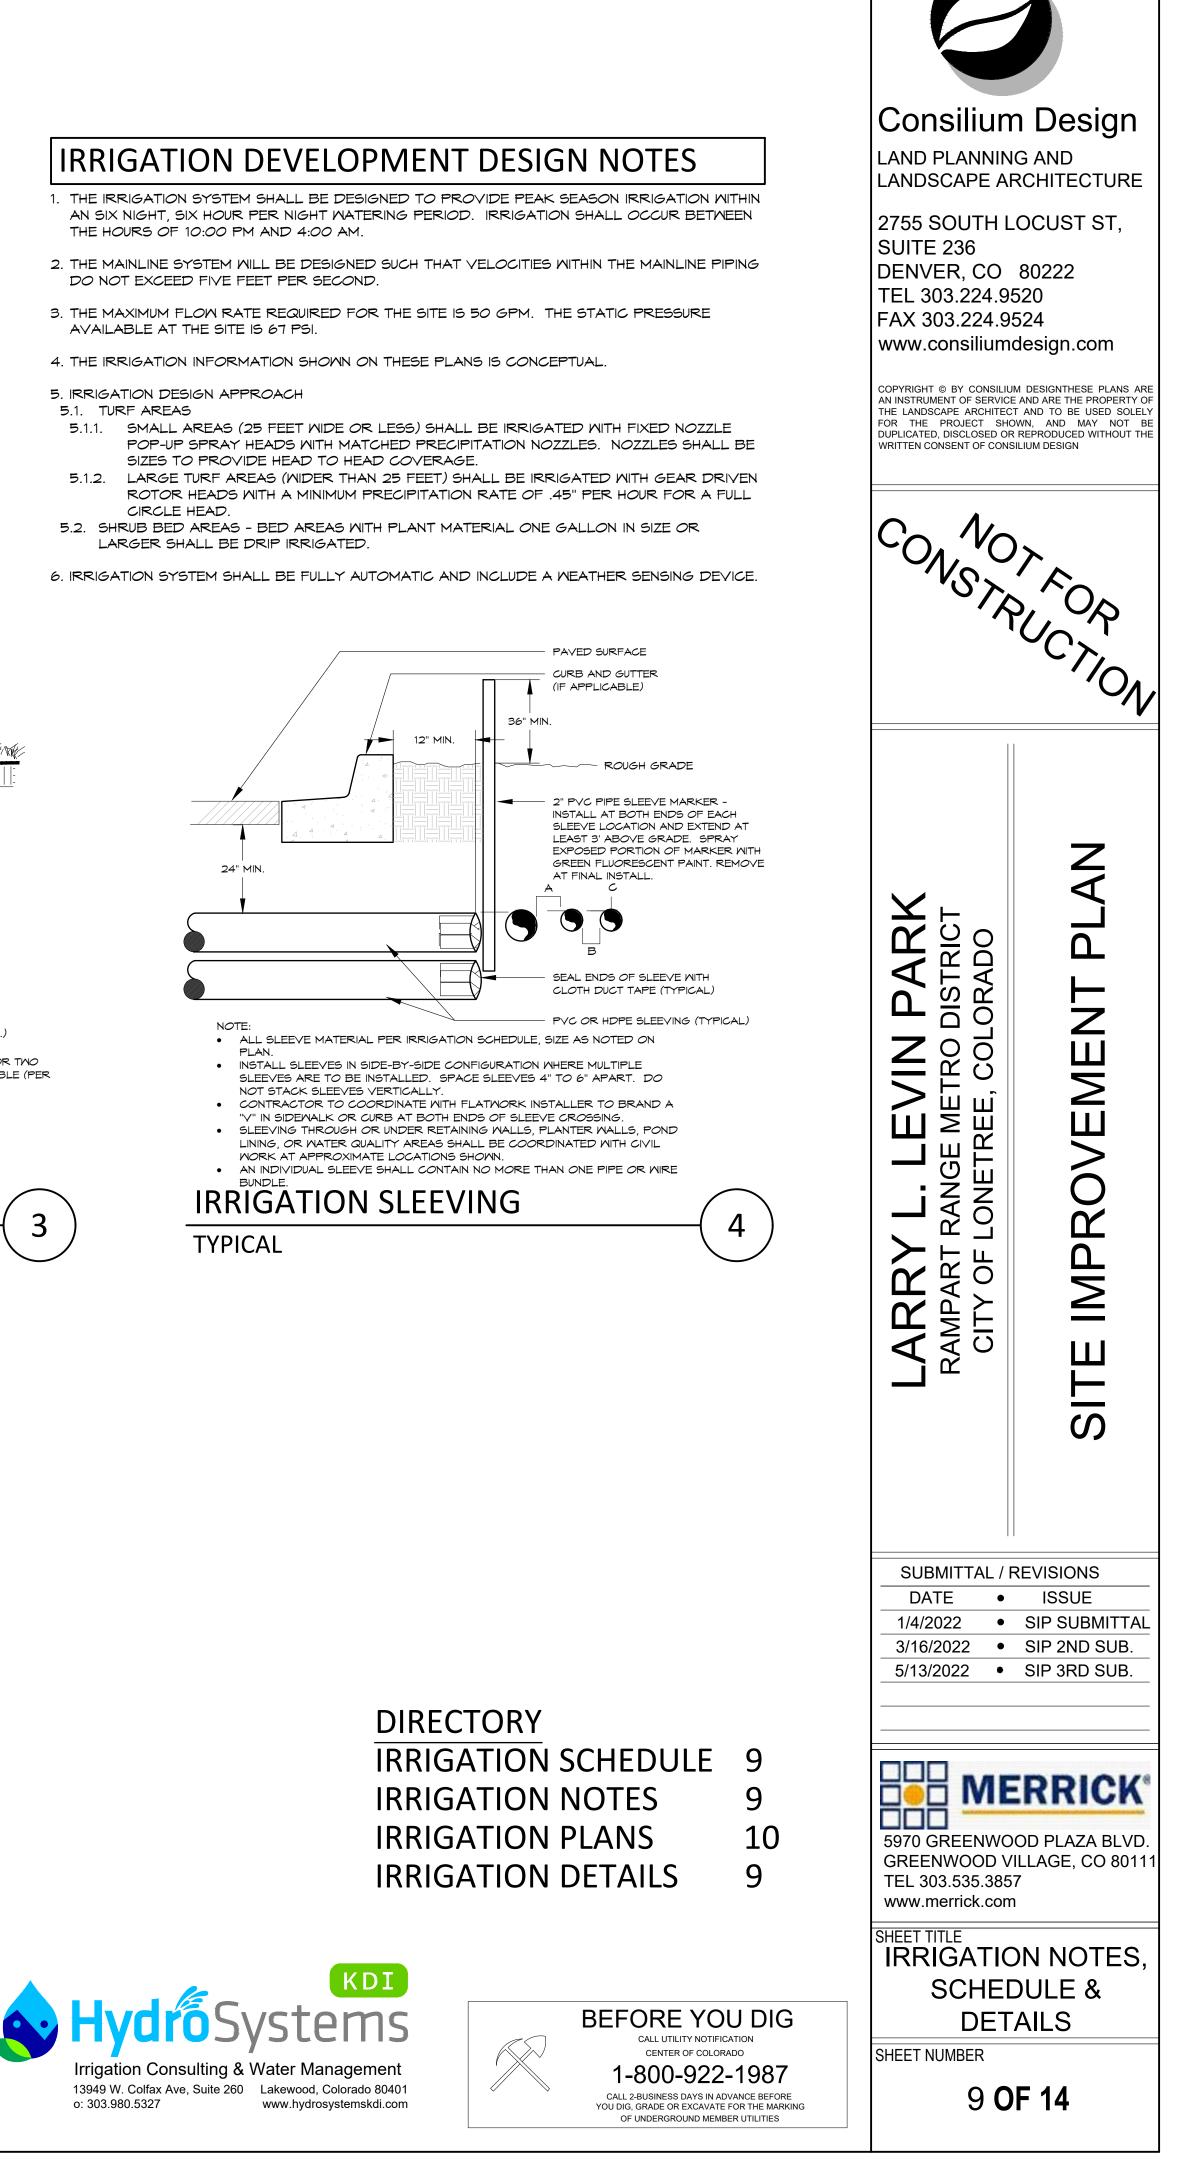


NOTE: REFER TO TECHNICAL SPECIFICATIONS FOR MINIMUM TRENCH WIDTHS. FINISH KANA GRADE V-KA/M /W/M 4-6" BODIES: 14 12" BODIES: 18 4-6" BODIES: 1 12" BODIES: 24 SPRAY HEAD LATERAL PIPING OR DRIP LINE HEADER. ROTOR LATERAL PIPING BACKFILL MATERIAL (TYP.) MAINLINE CONTROL WIRE BUNDLE OR TWO WIRE COMMUNICATION CABLE (PER SPECIFICATIONS)

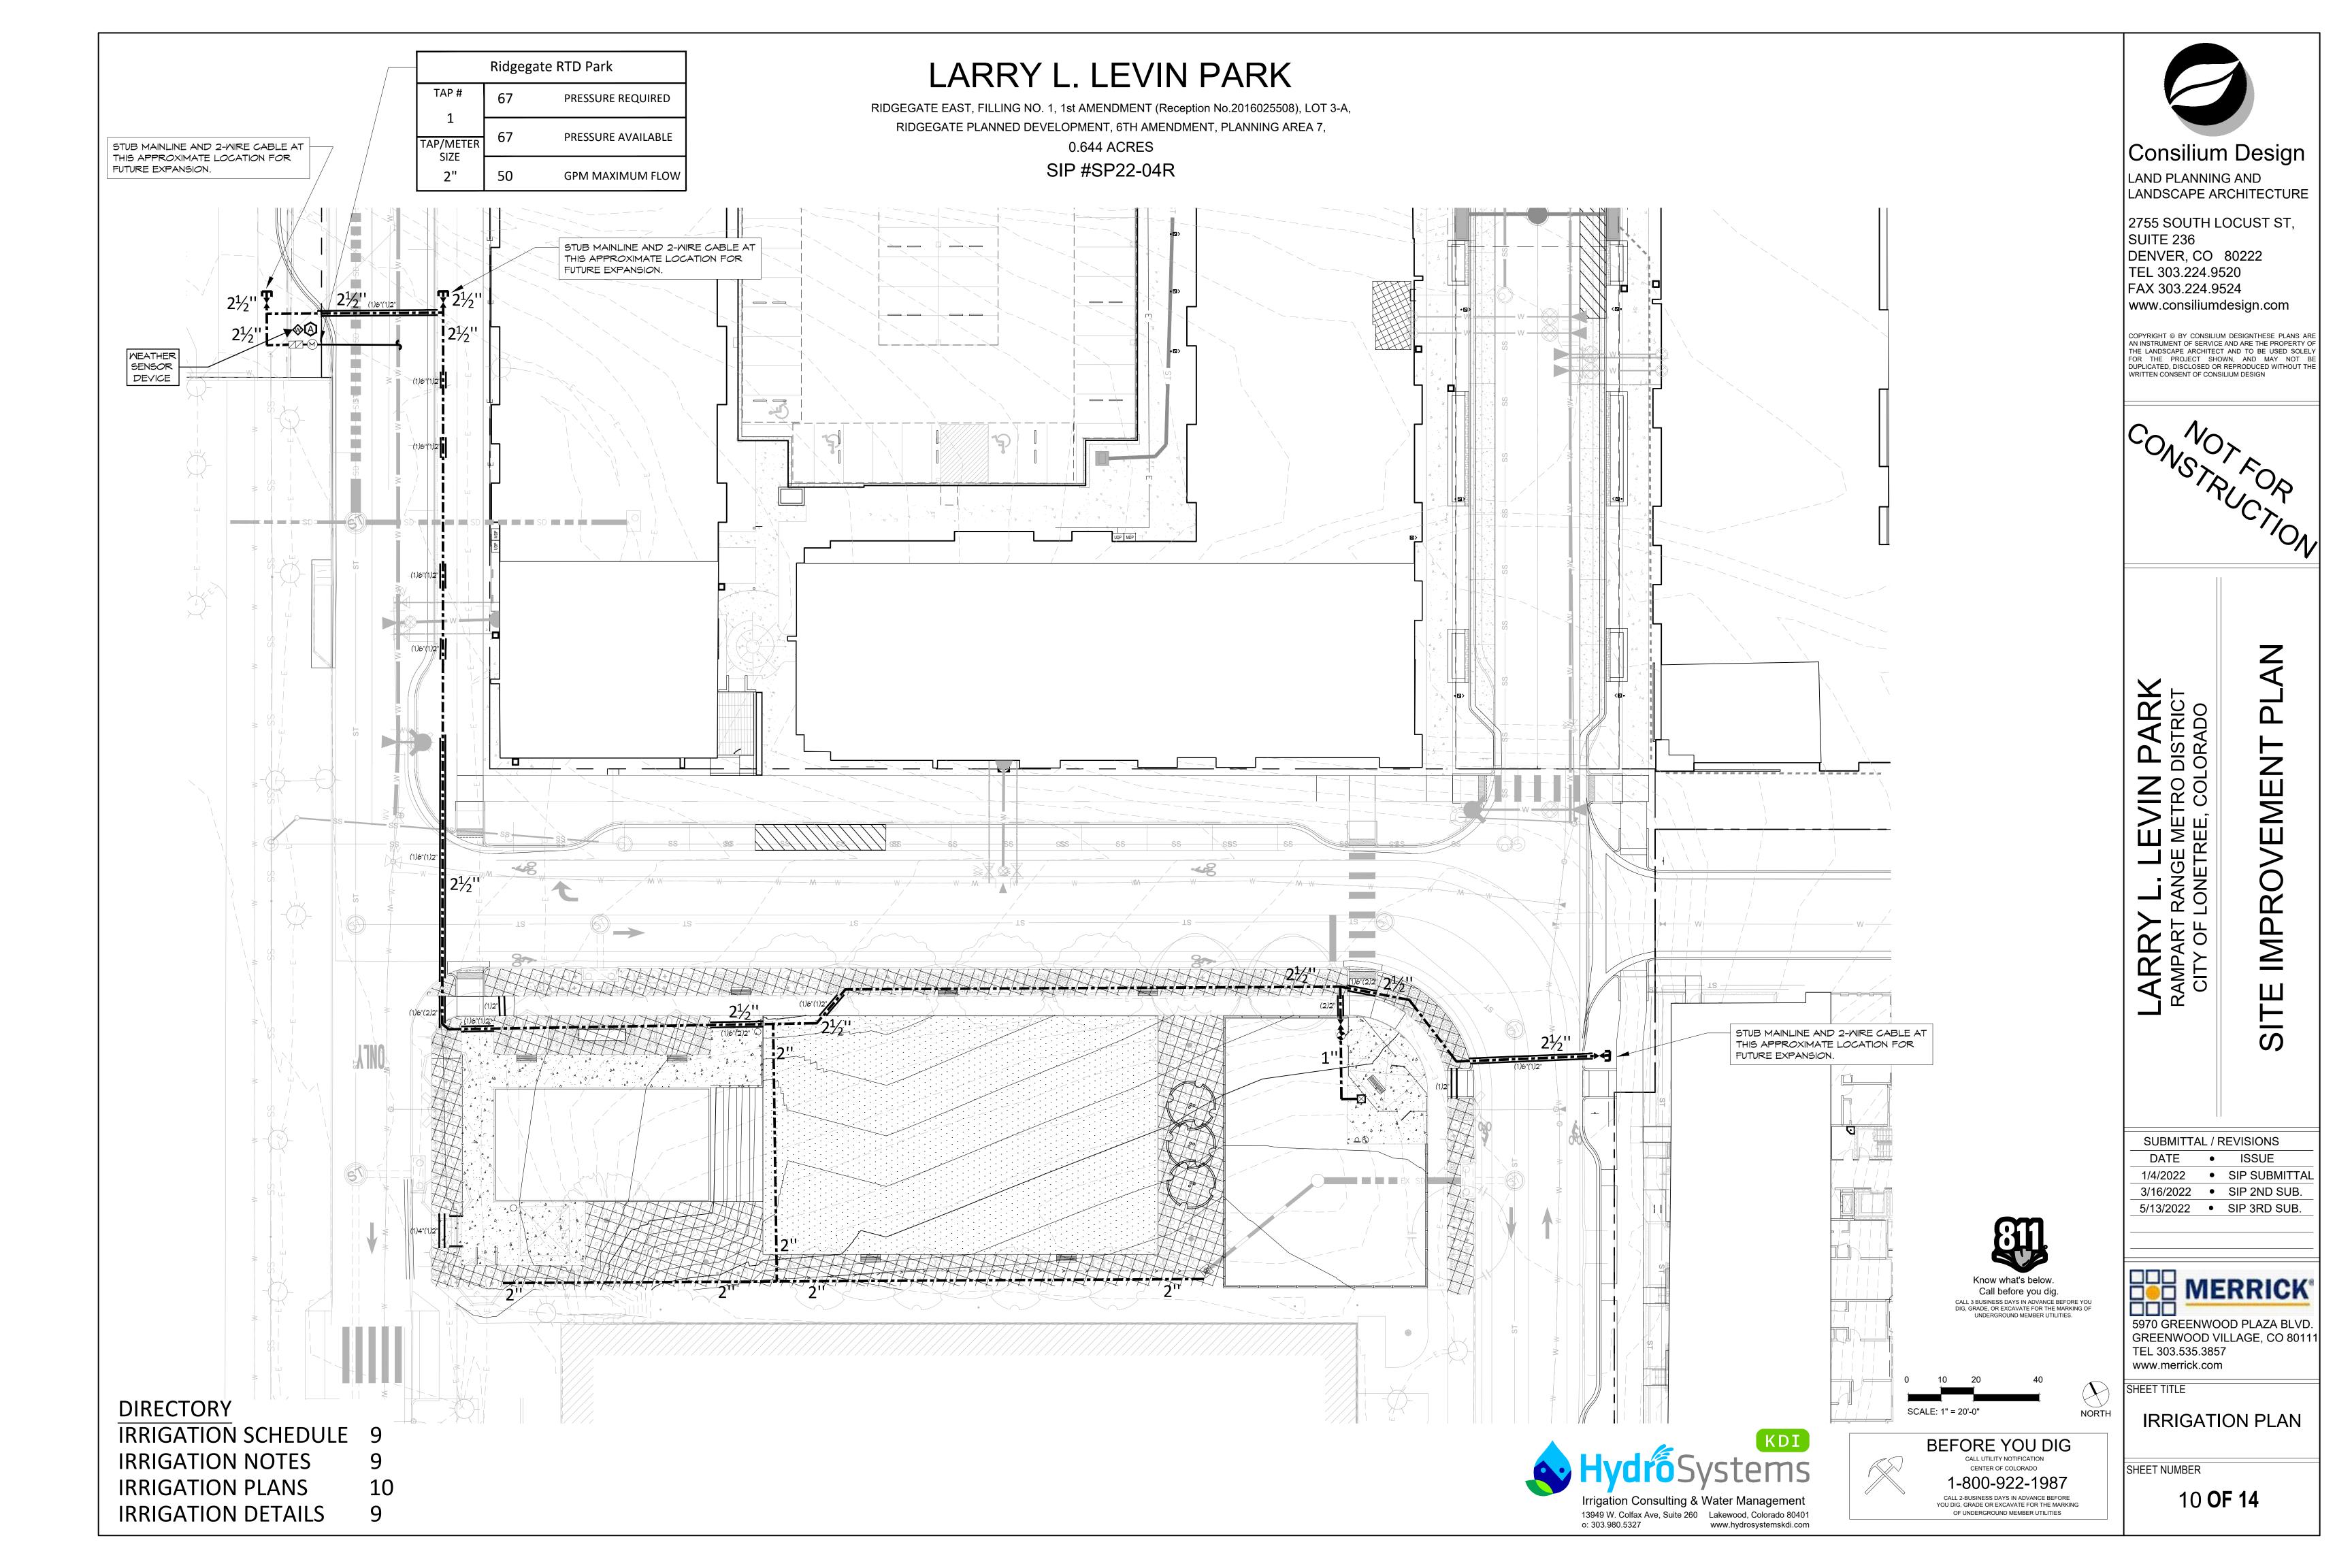

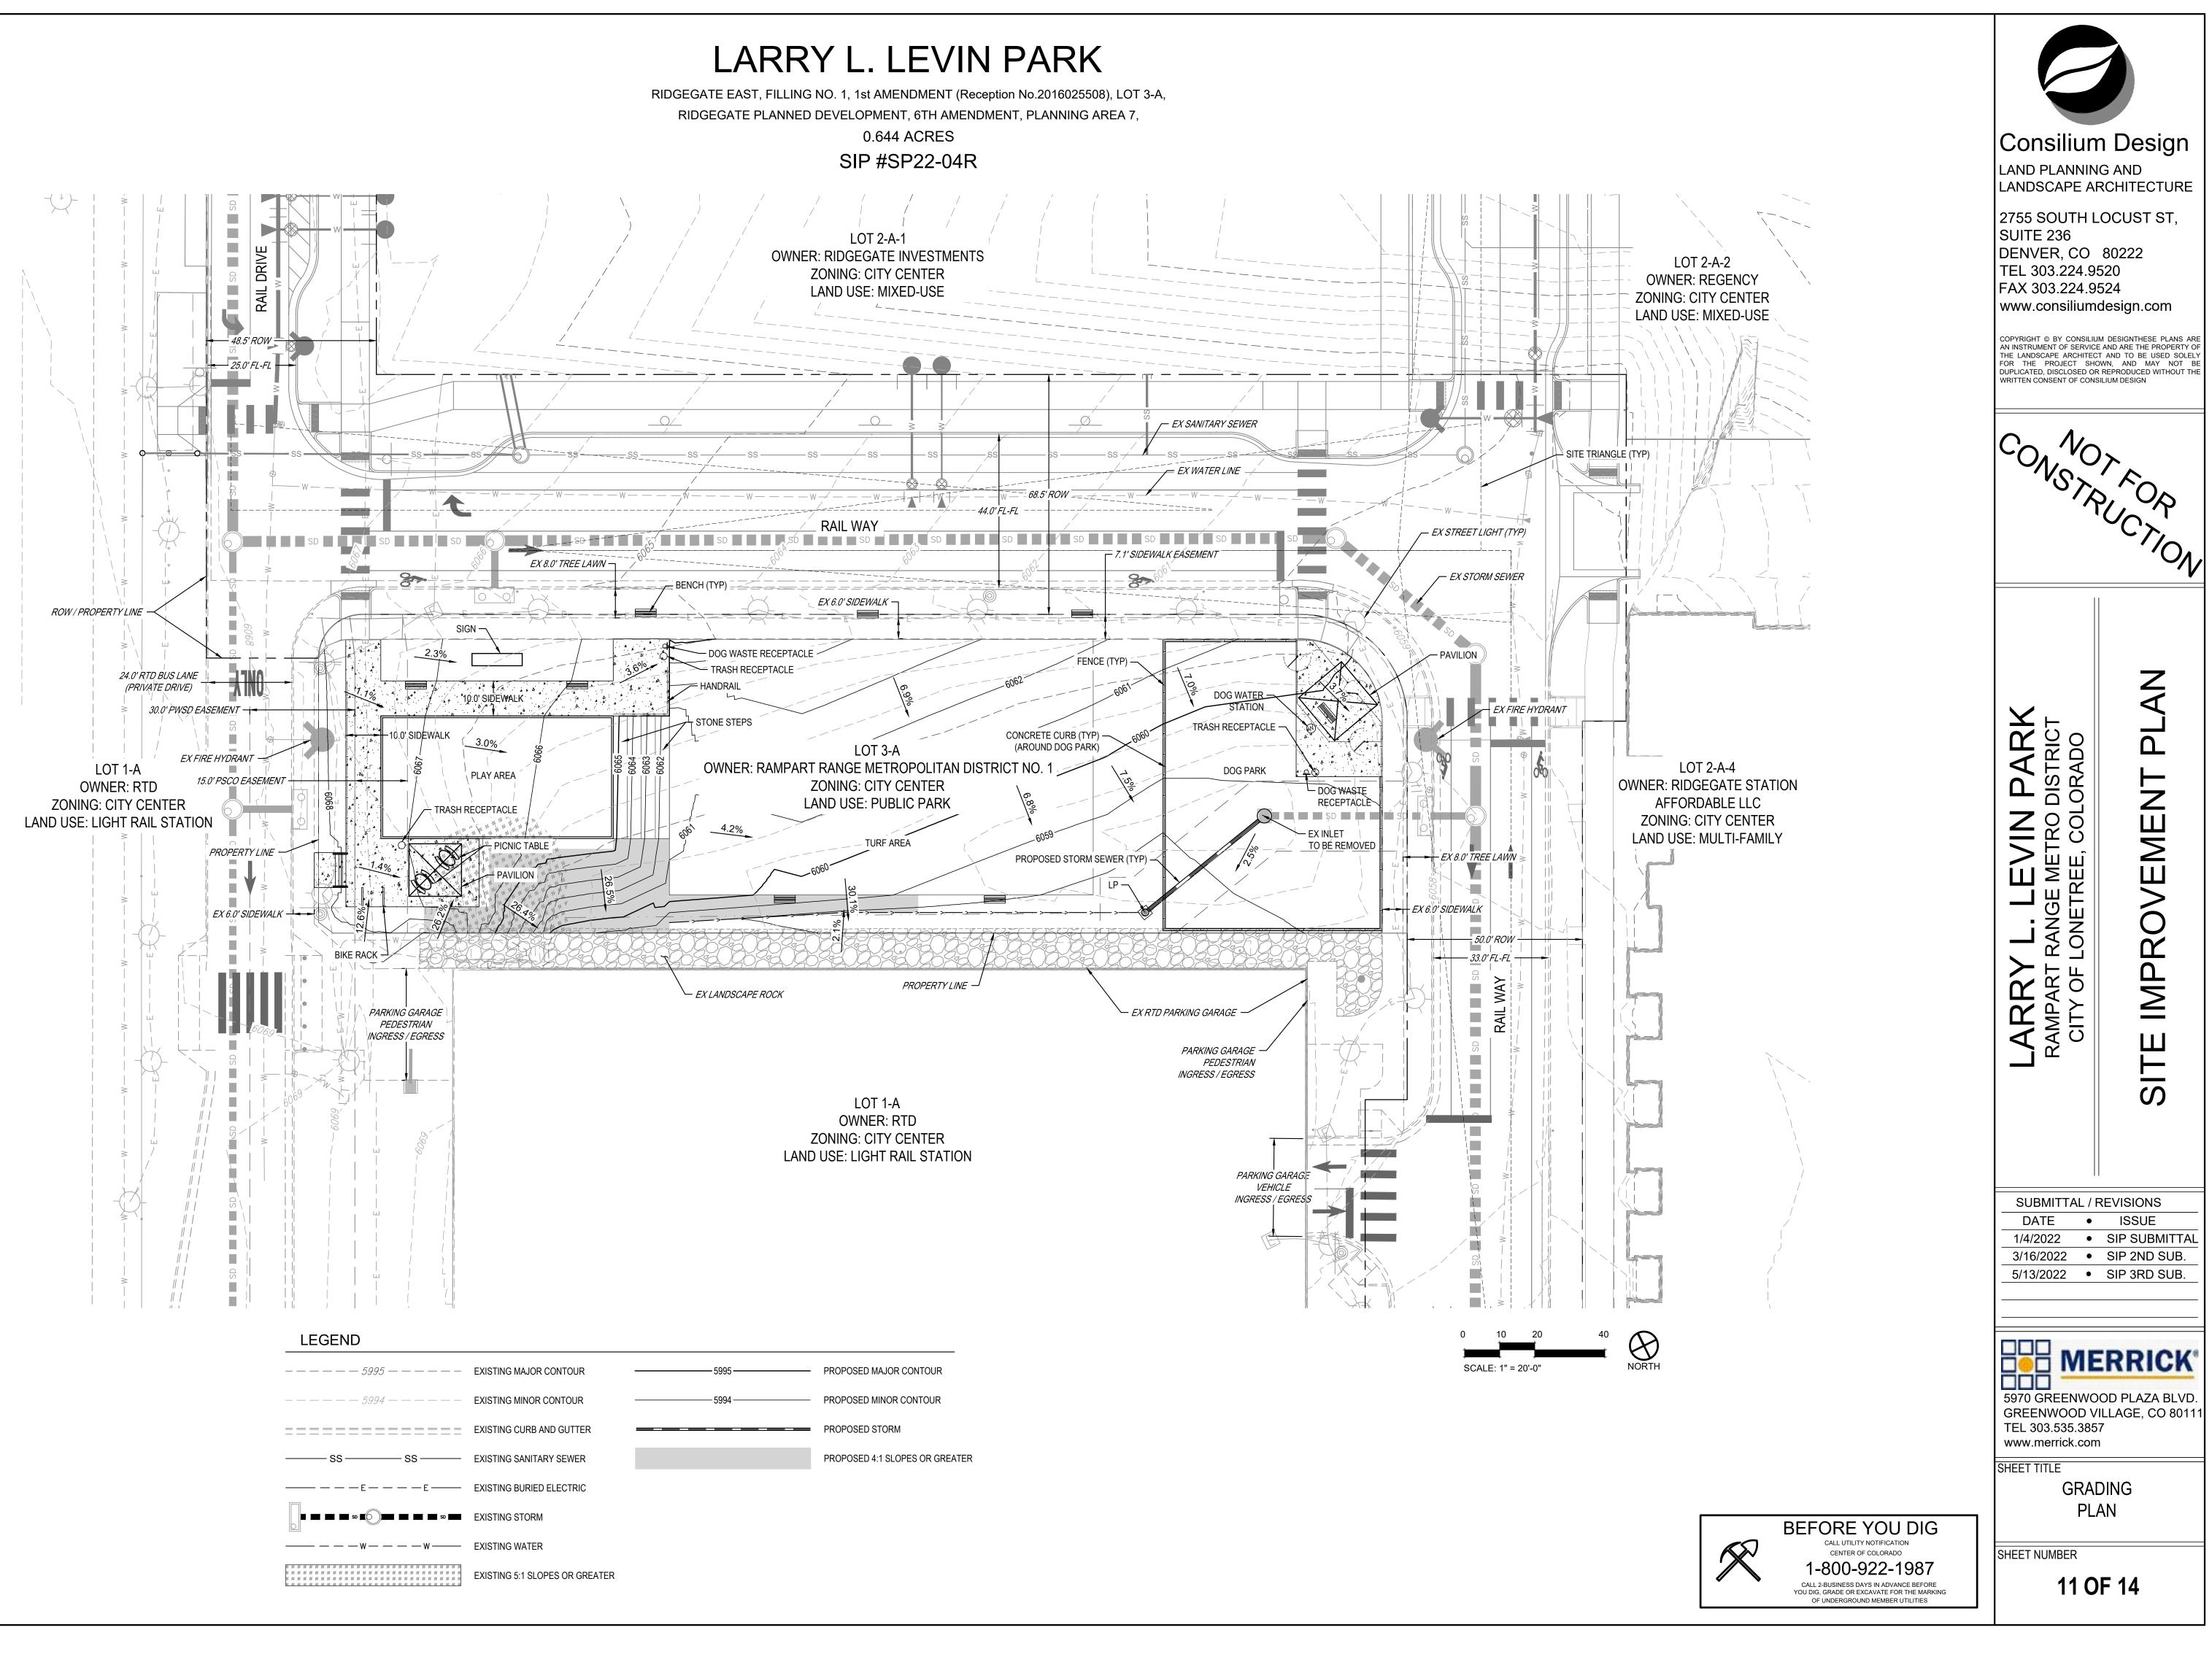

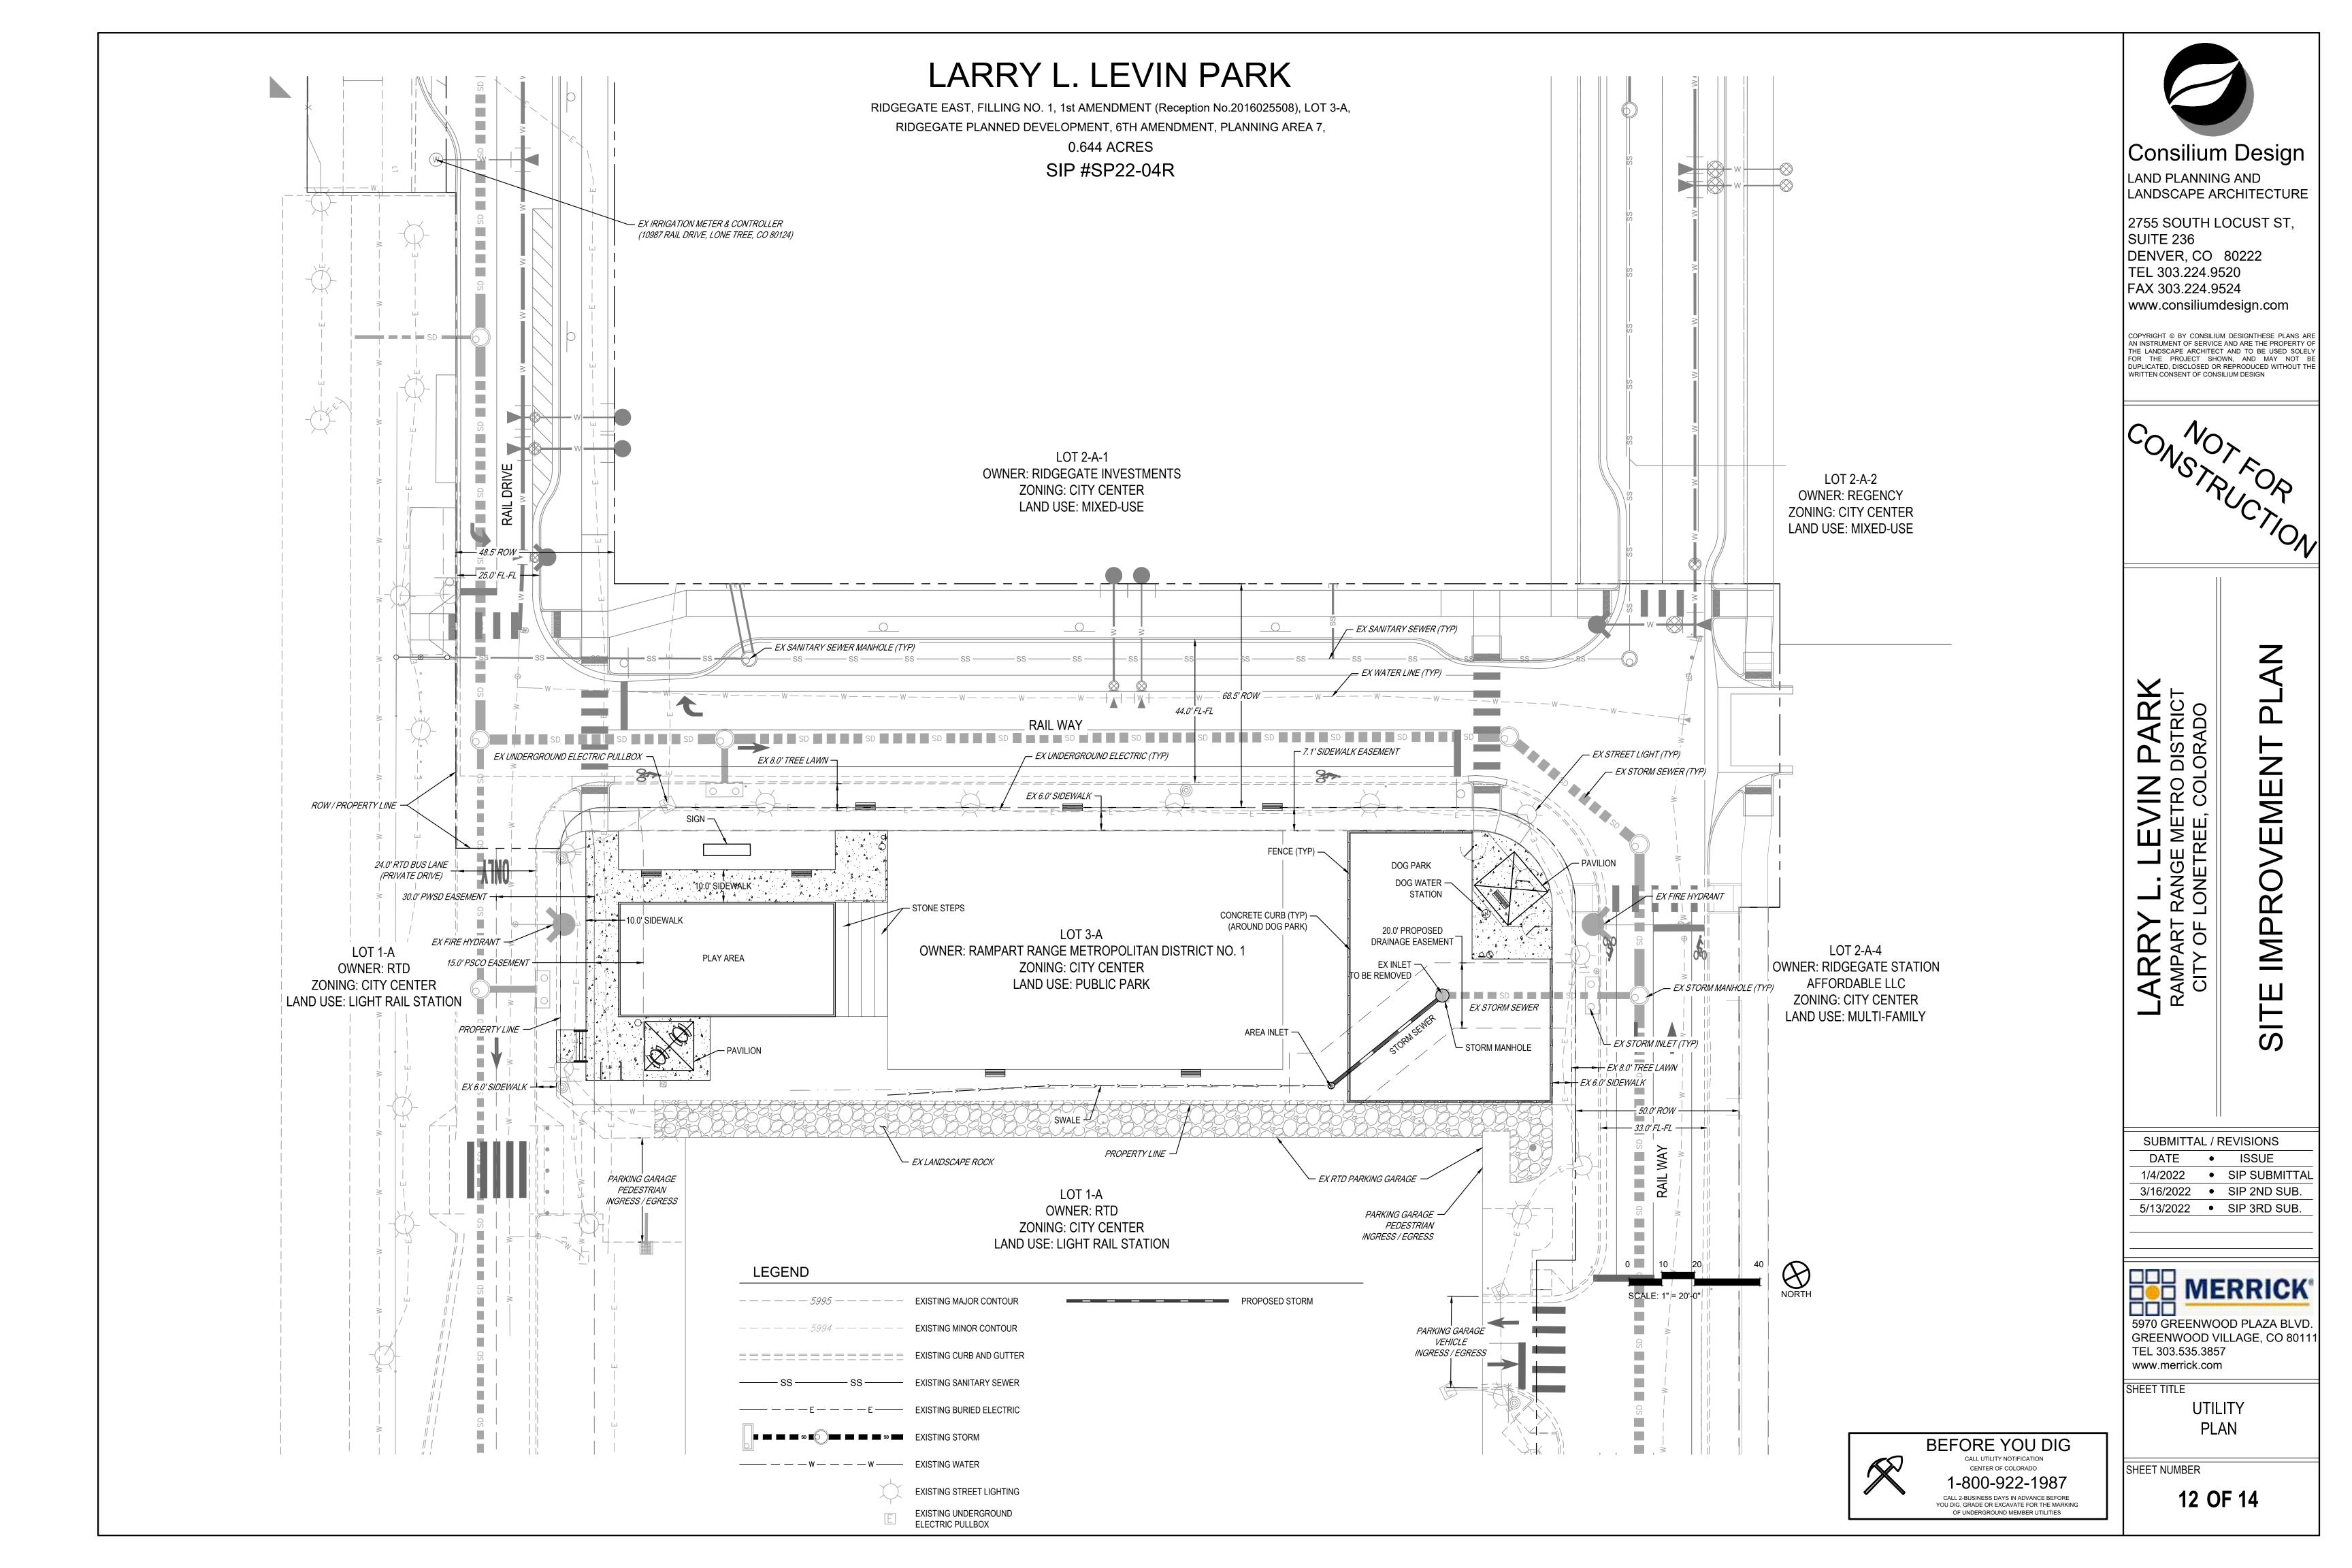

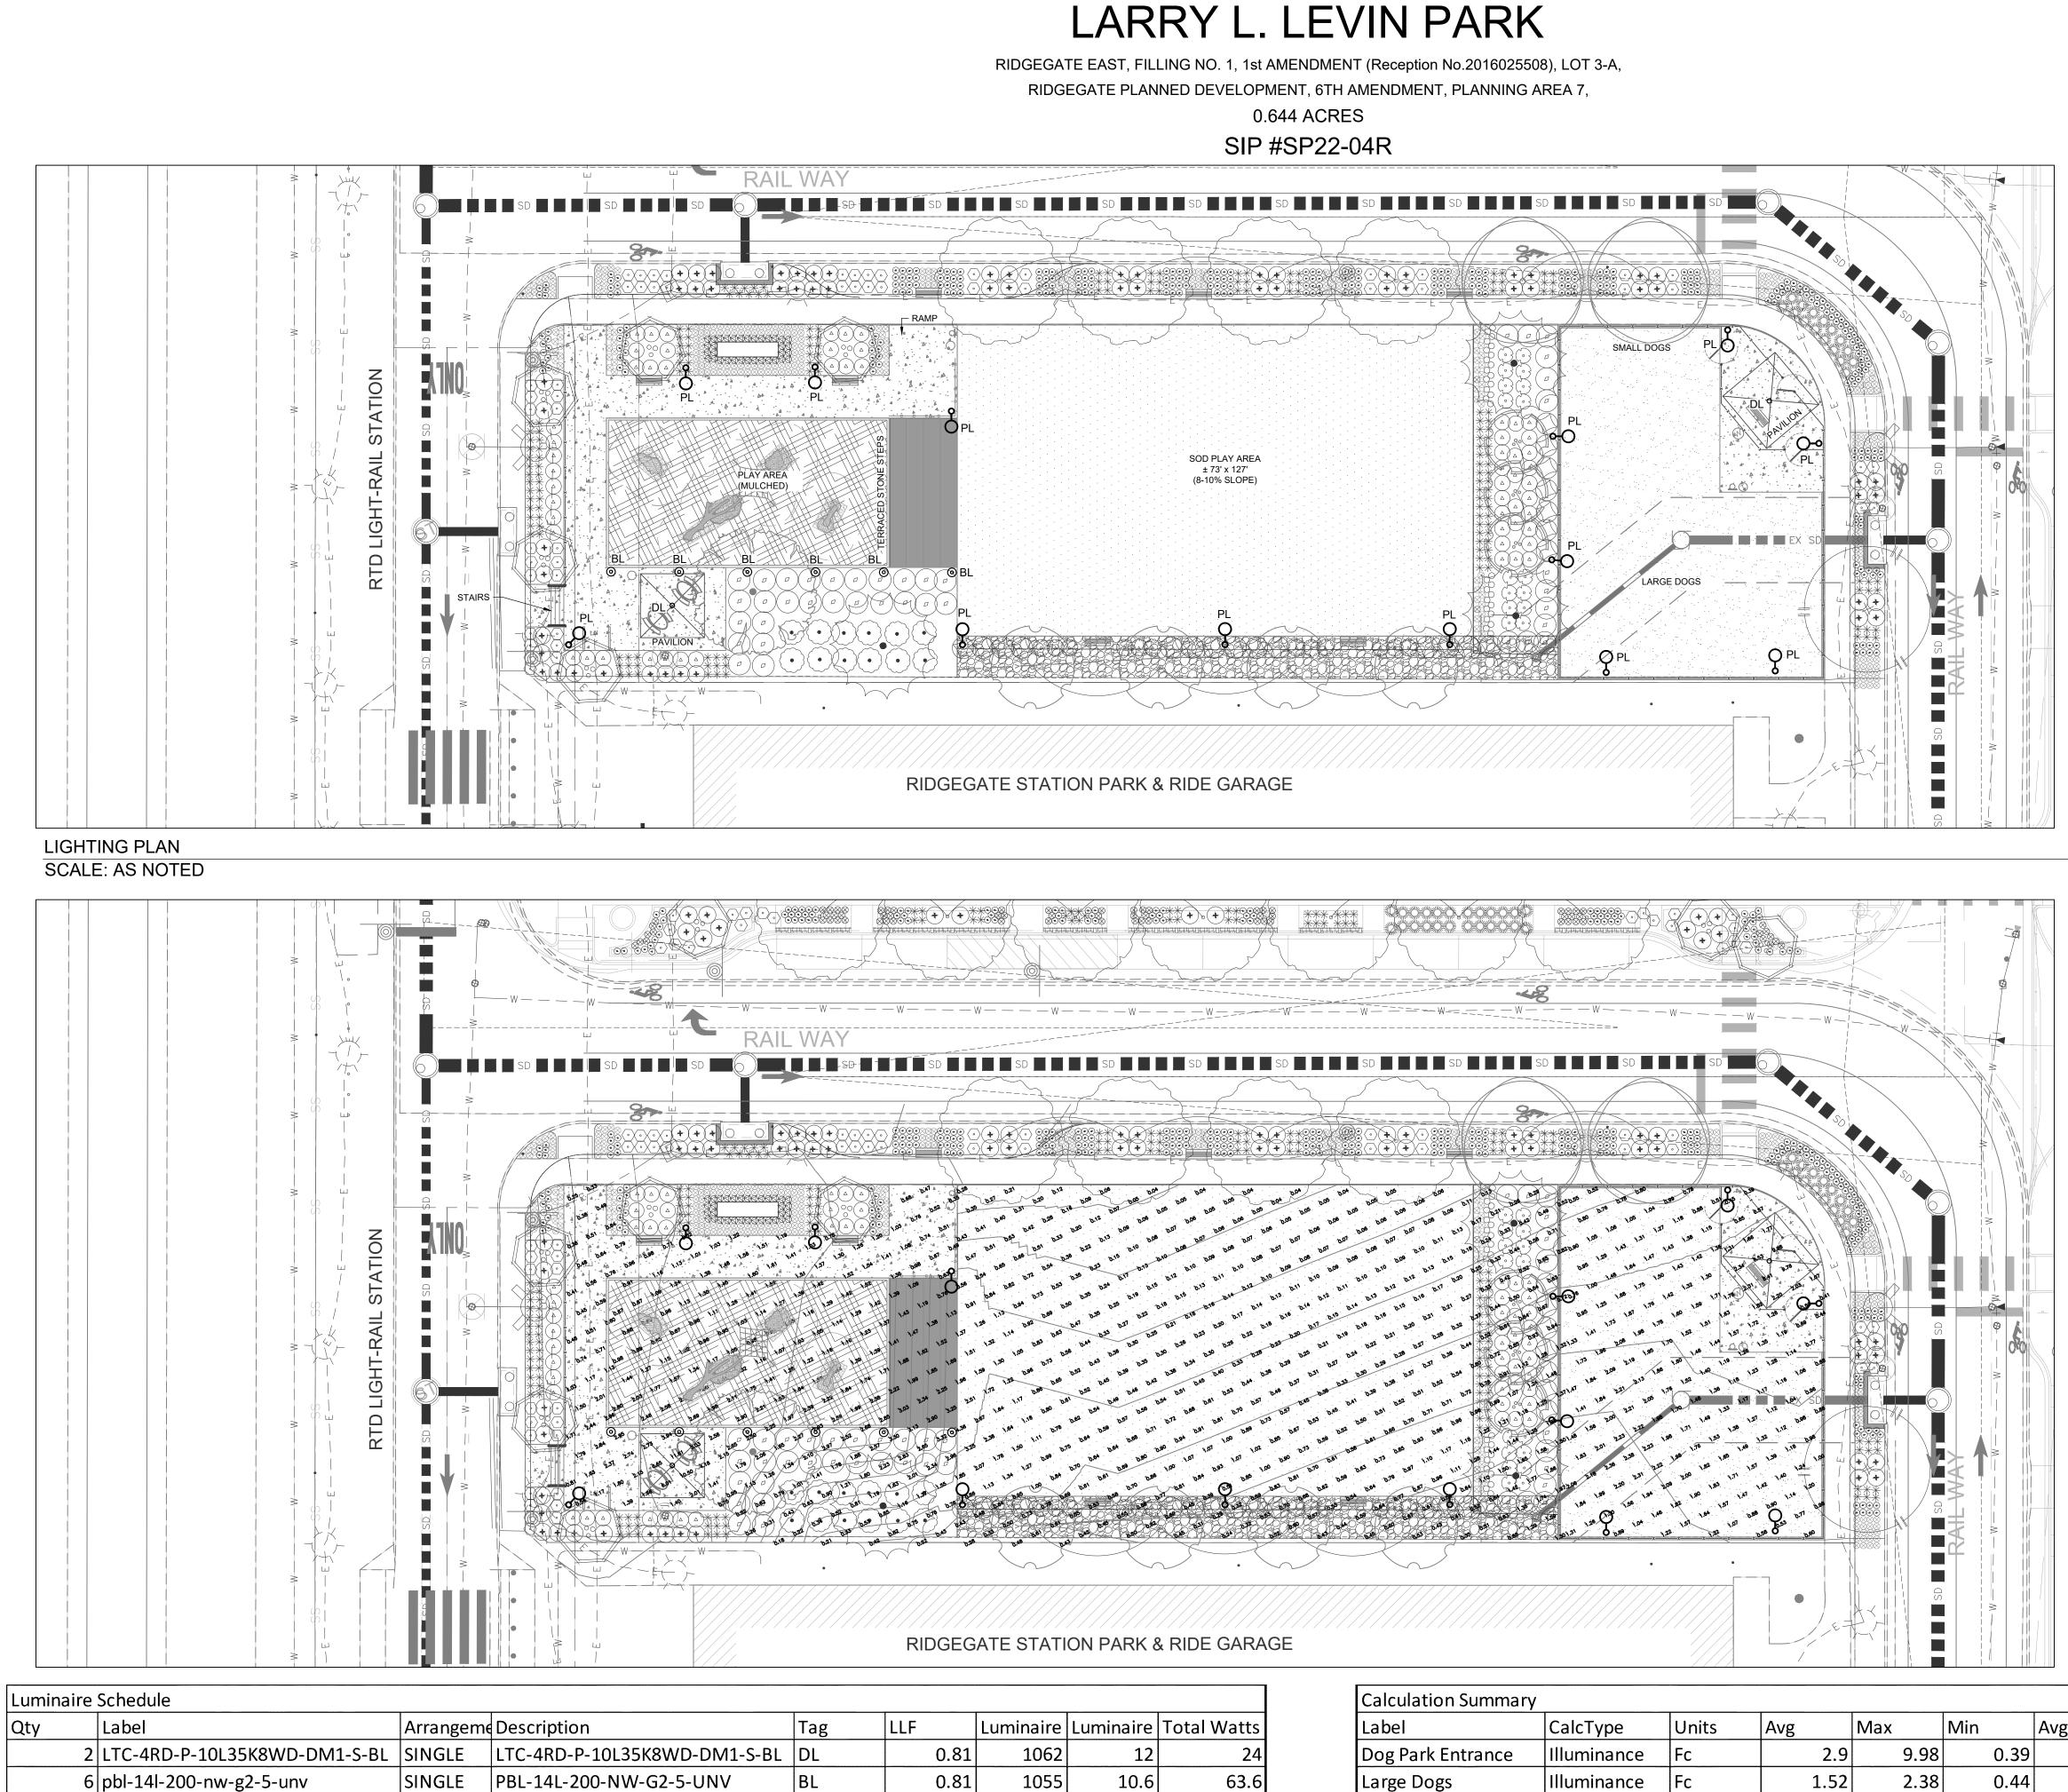

PHOTOMETRIC PLAN SCALE: AS NOTED

13 ppt-140l-650-ww-g2-3-ehs

PPT-140L-650-WW-G2-3-EHS

ΡL

SINGLE

	Luminaire	Luminaire	Total Watts
0.81	1062	12	24
0.81	1055	10.6	63.6
0.81	2477	30.40793	395.303

Calculation Summary	/						
Label	CalcType	Units	Avg	Max	Min	Avg/Min	Max/Min
Dog Park Entrance	Illuminance	Fc	2.9	9.98	0.39	7.44	25.59
Large Dogs	Illuminance	Fc	1.52	2.38	0.44	3.45	5.41
Play area	Illuminance	Fc	0.82	4.36	0.04	20.5	109
Small Dogs	Illuminance	Fc	1.18	1.76	0.51	2.31	3.45

CLANTON & ASSOCIATES

LIGHTING DESIGN AND ENGINEERING 4699 NAUTILUS COURT SOUTH STE. 102 BOULDER, CO 80301 303-530-7229





Consilium Design LAND PLANNING AND

LANDSCAPE ARCHITECTURE 2755 SOUTH LOCUST ST,

SUITE 236 DENVER, CO 80222 TEL 303.224.9520 FAX 303.224.9524 www.consiliumdesign.com

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LIGHTING AND ELECTRICAL LEGEND

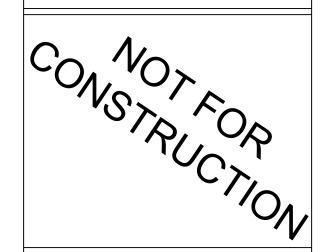SYMBOL DESCRIPTION
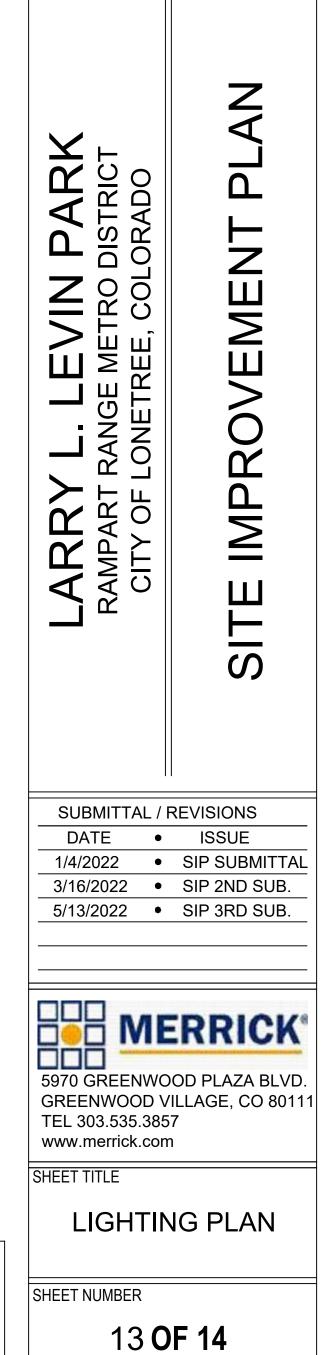
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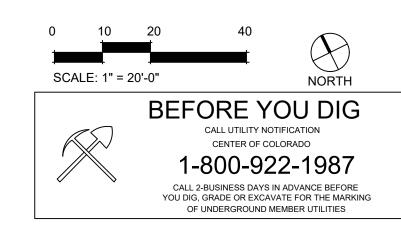
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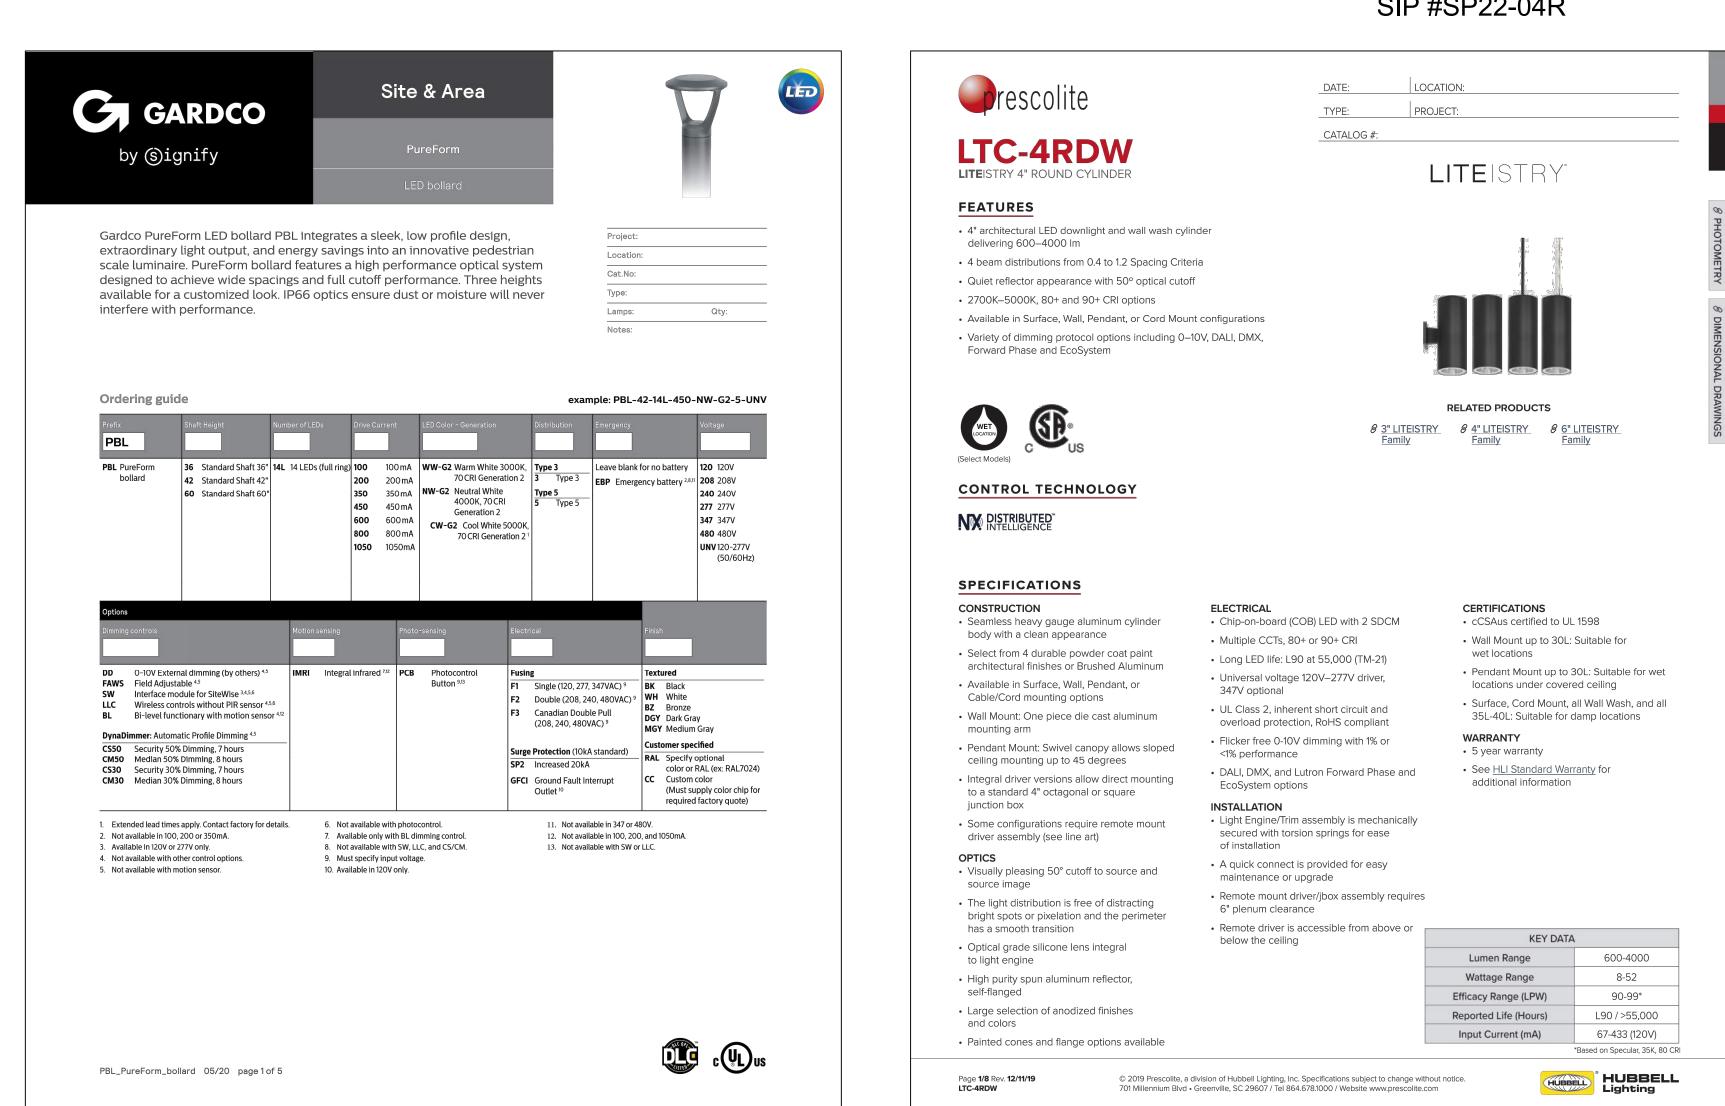
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- TYPE 'PL' PEDESTRIAN LIGHT STANDARD
- TYPE 'DL' SURFACE MOUNTED DOWN LIGHT
- TYPE 'BL' LIGHTING BOLLARD
- EXISTING PEDESTRIAN AND ROADWAY LIGHT TO REMAIN.





LARRY L. LEVIN PARK

RIDGEGATE EAST, FILLING NO. 1, 1st AMENDMENT (Reception No.2016025508), LOT 3-A,

RIDGEGATE PLANNED DEVELOPMENT, 6TH AMENDMENT, PLANNING AREA 7,

0.644 ACRES SIP #SP22-04R

PHIL Ca	IPS GARDCO	O				7	7			
Site &	Area					Ď	₽7. ■	r (U) us	Project: Location: Cat.No: Type: Qty:	
LED post with com	top fort optics			Comfort Type 1, 2 to 9000 savings.	optics ar , 3, and 5 lumens. / Optional	e designed t optical distr A full range d	o enha ibutio of cont	ance visual co ns are availab trol options pr	Notes: sleek, low prof mfort by reduc le with lumen o ovides additio kup is available	cing glare. Output up nal energy
Ordering gu	uide							example: PI	PT-140L-450-NW-	-G2-T3-1-UNV-D0
Prefix PPT	Number of LEDs	Drive Curre	nt	LED Color - Gene	ration	Mounting T3		Distribution 5	Emergency	Voltage
PPT PureForm post top, comfort optics	140L 140 LEDs	1675 1675	1mA 0mA ¹ 5mA ¹ 0mA ^{1,2}	NW-G2 Neutra 70 CRI CW-G2 Cool W 70 CRI WY-G2 Warm ¹ 2700K Genera	Seneration 2 White 4000K, Generation 2 hite 5000K, Generation 2 Yellow 80 CRI tion 2 ³ Amber (590nm)	 T3 Mounts to a 3" (standard) T2 Mounts to a 2 Tenon (must be ordered and sh a separate acce 	8/8" x 4" ipped as	 Comfort Type 1 Comfort Type 2 Comfort Type 3 Comfort Type 5 	Leave blank for no battery EBPC Emergency battery pack cold weather ^{24,5,67} EBP Emergency battery pack ^{14,57}	120 120V 208 208V 240 240V 277 277V 347 347V 480 480V UNV 120-277V (50/60Hz) HVU 347-480V (50/60Hz)
Options Dimming controls					Photo-sensing		Electrical	17.	Finish	1
			ion sensin	5						
FAWS Field Adjus SW Interface m LLC3 Integral win BL Bi-level fur DynaDimmer: Automa CS50 Security 5C CM50 Median 50 Cc500 CC530 Security 3C CM30 Median 30 CC302 Security 3C CM30 Median 30 CE30 Economy 3	Irral dimming (by other: stable ⁴⁵ lodule for SiteWise ^{45,8} reless module with #3 li actionary with motion s atic Profile Dimming ⁴⁷ % Dimming, 8 hours 10% Dimming, 9 hours % Dimming, 9 hours % Dimming, 8 hours 10% Dimming, 9 hours 0% Dimming, 9 hours % Dimming, 9 hours % Dimming, 9 hours	ens ^{4,5,6,7}	13 Integ	yral with #3 lens	TLRD5 Twist Lo		F2 Do F3 Ca (2) Surge Prot	ngle (120, 277, 347VAC) ⁹ ouble (208, 240, 480VAC) ⁹ anadian Double Pull 08, 240, 480VAC) ⁹ tection (10KA standard) creased 20kA	Textured BK Black WH White BZ Bronze DGY Dark Gray MGY Medium Gray Customer specified RAL Specify optional color or RAL (estimation of the color or RAL (estimation of the color or equired factor) CC Custom color (Must supply color required factor)	a: RAL7024) Alor chip for
-	100mA not available EBP).	with emerge y battery bac		5. N	ot available wit	h other control optior h motion sensor. h photocontrol.	I IS.		. Must specify input volt. D. Dimming will not be con with other control optic	nnected to NEMA recepta

CLANTON	&	ASSOCIATES
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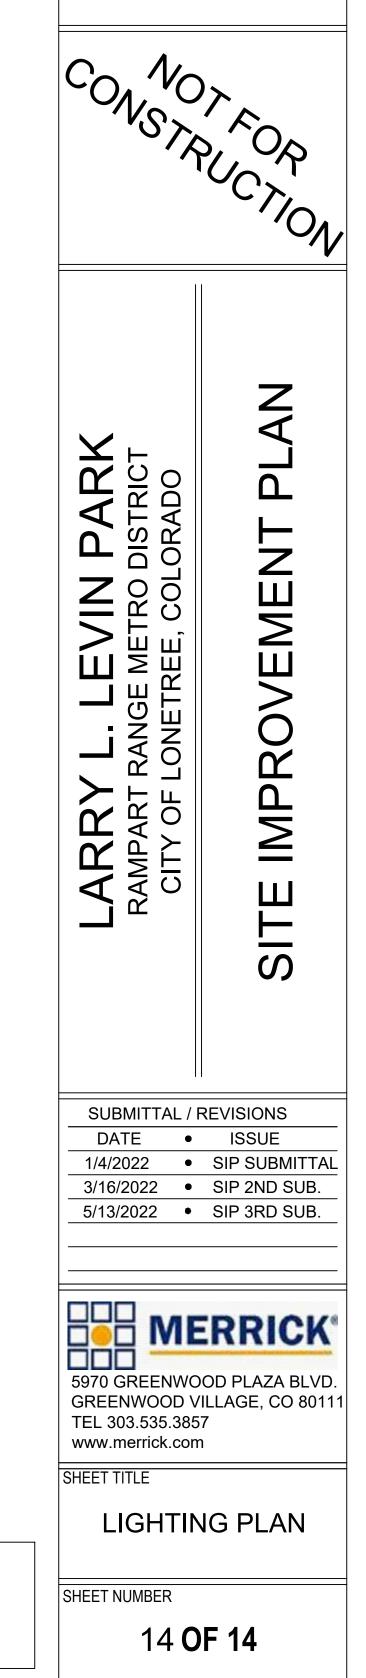
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Consilium Design LAND PLANNING AND LANDSCAPE ARCHITECTURE

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SCA	LE: 1" = 2	20'-0"		NORTH	
CALL UTILITY NOTIFICATION CENTER OF COLORADO					
1-800-922-1987					
CALL 2-BUSINESS DAYS IN ADVANCE BEFORE YOU DIG, GRADE OR EXCAVATE FOR THE MARKING OF UNDERGROUND MEMBER UTILITIES					