
BASIS OF BEARING:

BEARINGS ARE BASED ON THE NORTHWEST LINE OF LOT 4-B, PARK MEADOWS TOWN CENTER FILING NO. 1-A, 6TH AMENDMENT RECORDED AT RECEPTION NO. 2002087418 AS BEARINGS NORTH 47°09'19" EAST. SAID LINE BEING MONUMENTED AT THE NORTHEAST END BY A NAIL & TAG STAMPED "FARNSWORTH PLS 28668", AND AT THE SOUTHWEST END BY A NAIL & TAG STAMPED "FARNSWORTH PLS 38098".

BENCHMARK:

BENCHMARK IS DOUGLAS COUNTY CONTROL POINT 2113021 STAMPED" 2.113021 DC GIS" WITH A PUBLISHED ELEVATION OF 5914.49 FT (NAVD88)

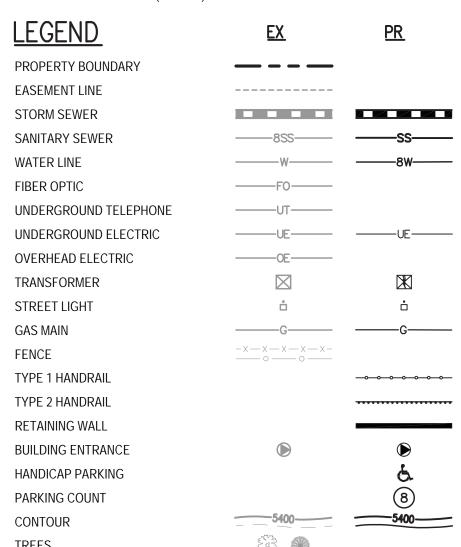

PARK MEADOWS TOWN CENTER FILING NO. 1-A, 8TH AMENDMENT, LOT 4-C-1 PARK MEADOWS PLANNED DEVELOPMENT, 2ND AMENDMENT

PLANNING AREA #1 **4.32 ACRES** SIP #SP24-0010

8517 PARK MEADOWS CENTER DRIVE

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CIVIL SITE PLAN - PHASE 1B

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AXONOMETRICS

AXONOMETRICS

IRRIGATION NOTES & LEGENDS - PHASE 1B

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SITE LIGHTING PHOTOMETRICS PHASE 1B

ARCHITECTURAL SITE PLAN PHASE 1A - SIP

ARCHITECTURAL SITE PLAN PHASE 1B - SIP


GARAGE LIGHTING PLAN & PHOTOMETRICS LEVEL 1

GARAGE LIGHTING PLAN & PHOTOMETRICS LEVEL 5

MALL ENTRY CANOPY, TRUCK DOCK GATE - PHASE 1B

GARAGE LIGHTING PLAN & PHOTOMETRICS LEVEL 2, 3, 4

PLANTING SCHEDULE - PHASE 1A

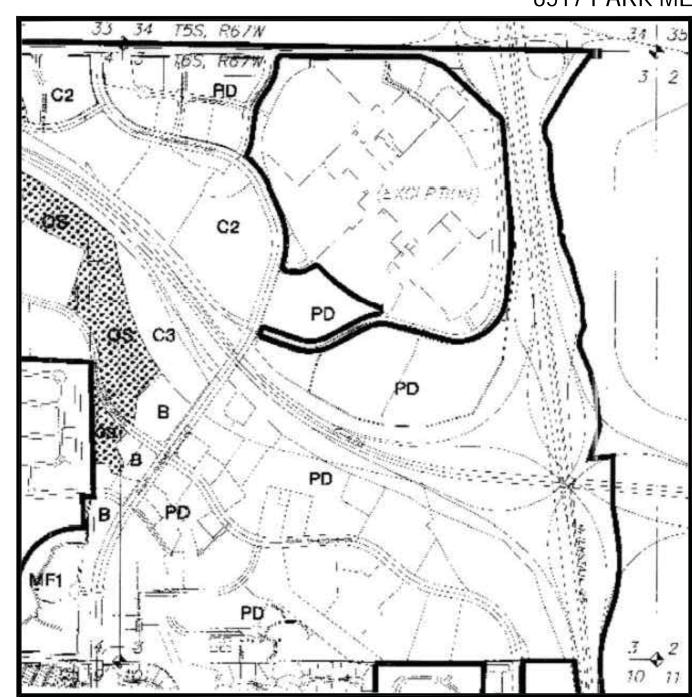

PARK MEADOWS PD VICINITY MAP

E COUNTY LINE PARK MEADOWS

> **VICINITY MAP** SCALE: 1" = 1000'

THE PROPERTY DESCRIBED HEREIN IS SUBJECT TO ALL APPLICABLE REQUIREMENTS OF THE LONE TREE ZONING CODE AND DESIGN STANDARDS, INCLUDING BUT NOT LIMITED TO, PROPERTY MAINTENANCE, LIGHTING, PARKING, SIGNAGE, LANDSCAPING AND OUTDOOR STORAGE, EXCEPT AS MAY OTHERWISE BE ADDRESSED IN AN APPROVED PLANNED DEVELOPMENT PLAN, SUB- AREA PLAN, OR OTHER APPLICABLE PLAN OR

THE APPLICANT ASSUMES RESPONSIBILITY TO ENSURE THE PROJECT IS COMPLETED IN ACCORDANCE WITH THE APPROVED SIP AND ANY ASSOCIATED MATERIALS SAMPLE BOARDS AND FURTHER ASSUMES THE RISK ASSOCIATED WITH ANY CHANGES OR OMISSIONS MADE WITHOUT PRIOR CITY APPROVAL, MODIFICATIONS TO STRUCTURES OR SITES MAY REQUIRE AN AMENDMENT TO THE SIP AS DETERMINED BY THE CITY'S COMMUNITY DEVELOPMENT DIRECTOR, PER SEC. 16-27-180. UNAUTHORIZED CHANGES OR OMISSIONS MADE WITHOUT PRIOR CITY APPROVAL CORRECTIVE ACTIONS, DELAY OF PERMITS OR CITATIONS FOR ZONING VIOLATIONS WITH ASSOCIATED FINES AND LEGAL MEASURES. BUILDING PLANS SHALL CONFORM TO THE APPROVED SIP.

WITHIN SITE TRIANGLES, AS SHOWN, LIMITED LANDSCAPING SHALL BE ALLOWED WITH NO SOLID STRUCTURES PERMITTED AS STATED IN THE CITY OF LONE TREE'S LANDSCAPE DESIGN GUIDELINES AND STANDARDS FOR LANDSCAPING, LANDSCAPING WITHIN THE SIGHT TRIANGLE SHALL BE MAINTAINED BY THE PROPERTY OWNER OR APPROPRIATE ASSOCIATION OR DISTRICT, AS MAY BE IDENTIFIED IN MAINTENANCE AGREEMENTS

RECORDED WITH THE DOUGLAS COUNTY CLERK AND RECORDER'S OFFICE. THE OWNER IS RESPONSIBLE FOR THE INSTALLATION OF ALL ROADWAY SIGNAGE, INCLUDING 'NO PARKING/FIRE LANE'SIGNAGE, AS REQUIRED BY THE CITY PUBLIC WORKS DEPARTMENT AND/OR THE FIRE DISTRICT. SUCH SIGNAGE SHALL BE MAINTAINED BY THE PROPERTY OWNER OR APPROPRIATE ASSOCIATION OR DISTRICT, AS MAY BE IDENTIFIED IN MAINTENANCE AGREEMENTS RECORDED WITH THE DOUGLAS COUNTY CLERK

SITE LANDSCAPING, SITE AMENITIES AND FURNISHINGS, AND ALL SITE IMPROVEMENTS INCLUDING, BUT NOT LIMITED TO, SIDEWALKS AND PARKING AREAS SHALL BE MAINTAINED IN A STATE OF GOOD REPAIR CONSISTENT WITH THE APPROVED SIP AND THE LONE TREE MUNICIPAL CODE AND DESIGN GUIDELINES AND STANDARDS. SUCH MAINTENANCE SHALL INCLUDE THE REGULAR MAINTENANCE OF PET WASTE STATIONS (WHEN PRESENT), TO INCLUDE WASTE COLLECTION AND WASTE BAG REPLACEMENT. LANDSCAPE PLANTINGS MUST BE ALIVE AND ALL IRRIGATION MUST BE FUNCTIONAL. ALL MAINTENANCE OBLIGATIONS SHALL BE COMPLETED BY THE PROPERTY OWNER OR APPROPRIATE ASSOCIATION OR DISTRICT, AS MAY BE IDENTIFIED IN MAINTENANCE AGREEMENTS RECORDED WITH THE DOUGLAS COUNTY CLERK AND RECORDER'S OFFICE.

. THE CITY OF LONE TREE REQUIRES THAT MAINTENANCE ACCESS BE PROVIDED TO ALL STORM DRAINAGE FACILITIES TO ASSURE CONTINUOUS OPERATIONAL CAPABILITY OF THE SYSTEM. THE PROPERTY OWNER SHALL BE RESPONSIBLE FOR THE MAINTENANCE OF ALL DRAINAGE FACILITIES. INCLUDING INLETS, PIPES, CULVERTS, CHANNELS, DITCHES, HYDRAULIC STRUCTURES AND DETENTION BASINS LOCATED ON THEIR LAND UNLESS MODIFIED BY THE SITE IMPROVEMENT PLAN IMPROVEMENTS AGREEMENT. SHOULD THE OWNER FAIL TO ADEQUATELY MAINTAIN SAID FACILITIES. THE CITY OF LONE TREE SHALL HAVE THE RIGHT TO ENTER SAID LAND FOR THE PURPOSES OF OPERATIONS AND MAINTENANCE. ALL SUCH MAINTENANCE COSTS WILL BE ASSESSED TO THE PROPERTY OWNER OR THE RESPONSIBLE MAINTENANCE AUTHORITY.

ACCORDING TO THE FEDERAL EMERGENCY MANAGEMENT AGENCY, NATIONAL FLOOD INSURANCE PROGRAM, FLOOD INSURANCE RATE MAP FOR THE CITY OF LONE TREE, DOUGLAS COUNTY, COLORADO COMMUNITY PANEL NUMBER 08035C0034G AND 08035C0053G, DATED MARHC 16TH, 2016 AND FEBRUARY 17TH, 2017, THE SUBJECT PROPERTY LIES WITHIN ZONE X, "AREAS DETERMINED TO BE INSIDE/OUTSIDE OF THE 0.2% ANNUAL

DEVELOPER IS RESPONSIBLE FOR INSTALLING PARKING SIGNS THAT:

RESTRICT THE SURFACE PARKING LOT TO ACCESSIBLE, CUSTOMER AND PROSPECTIVE TENANT PARKING, AND LOADING/DELIVERIES; AND PROHIBIT RESIDENTIAL VISITOR PARKING. ALL TENANT, VISITOR AND EMPLOYEE PARKING MUST BE RESTRICTED TO THE PARKING STRUCTURE ALL PRESENT AND FUTURE OWNERS AND OCCUPANTS OF LAND HEREBY SUBJECT TO A SITE IMPROVEMENT PLAN ARE HEREBY NOTIFIED THAT THE PROPERTY IS LOCATED WITHIN PROXIMITY TO CENTENNIAL AIRPORT AND IS SUBJECT TO THE TERMS OF THAT CERTAIN AVIGATION AND HAZARD EASEMENT RECORDED AT RECEPTION NUMBER BOOK 1256 AT PAGE 671 ON APRIL 7TH, 1995 IN THE RECORDS OF THE DOUGLAS

COUNTY CLERK AND RECORDER, AS MAY BE AMENDED. O. PROXIMITY TO CENTENNIAL AIRPORT MAY HAVE ANY NUMBER OF IMPACTS ON THE PROPERTY OCCUPANTS, THE PROPERTY, AND THE DEVELOPMENT, IMPROVEMENT, USE, ENJOYMENT OR OCCUPANCY OF THE PROPERTY, INCLUDING WITHOUT LIMITATION ODORS, AIRCRAFT NOISE, VIBRATION, FUMES, FUEL PARTICLES, EXHAUST, AND THE OPERATION AND PASSAGE OF AIRCRAFT ABOVE OR NEAR THE PROPERTY. INDIVIDUAL SENSITIVITIES TO THE POTENTIAL CENTENNIAL AIRPORT IMPACTS CAN VARY FROM PERSON TO PERSON, AND POTENTIAL AIRPORT IMPACTS CAN VARY FROM LOCATION TO LOCATION WITHIN THE PROPERTY AND FROM TIME TO TIME, RECORDS AND INFORMATION CONCERNING CENTENNIAL AIRPORT AND POTENTIAL AIRPORT IMPACTS ARE PUBLICLY AVAILABLE THROUGH VARIOUS FEDERAL, STATE, AND LOCAL GOVERNMENTAL AGENCIES, INCLUDING CENTENNIAL AIRPORT. ALL PRESENT AND FUTURE OWNERS AND OCCUPANTS ARE SOLELY RESPONSIBLE FOR EVALUATING

AND DETERMINING WHETHER THE AIRPORT IMPACTS, IF ANY, ARE ACCEPTABLE TO THEM. . THIS PROPERTY IS WITHIN A WILDFIRE RISK AREA. WILDFIRE RISK CAN VARY FROM LOCATION TO LOCATION WITHIN THE PROPERTY AND FROM TIME TO TIME, INFORMATION CONCERNING WILDFIRE RISK IS PUBLICLY AVAILABLE THROUGH VARIOUS FEDERAL, STATE, AND LOCAL GOVERNMENTAL AGENCIES, INCLUDING THE COLORADO STATE FOREST SERVICE. ALL PRESENT AND FUTURE OWNERS AND OCCUPANTS ARE SOLELY RESPONSIBLE FOR EVALUATING AND DETERMINING WHETHER THE WILDFIRE RISKS, IF ANY, ARE ACCEPTABLE TO THEM.

2. IT SHALL BE THE RESPONSIBILITY OF THE OWNER (OR RESPONSIBLE ASSOCIATION OR DISTRICT, AS MAY BE IDENTIFIED BY MAINTENANCE AGREEMENTS) TO MAINTAIN ALL PLAYGROUND EQUIPMENT AND PARK INFRASTRUCTURE ON THE PROPERTY IN A STATE OF GOOD REPAIR IN CONFORMANCE WITH ALL APPLICABLE BUILDING AND SAFETY REGULATIONS. 13. ARTWORK MUST BE MAINTAINED PER THE APPROVED SIP. ANY FADING, CHIPPING, OR DAMAGE SHALL BE REPAIRED BY THE PROPERTY OWNER OR APPROPRIATE ASSOCIATION OR DISTRICT, AS MAY BE IDENTIFIED IN MAINTENANCE AGREEMENTS RECORDED WITH THE DOUGLAS COUNTY

CLERK AND RECORDER'S OFFICE. ANY FUTURE REMOVAL OR ALTERATION OF ARTWORK, AS APPROVED BY THIS SIP MAY WARRANT AN SIP AMENDMENT AND SUBSEQUENT APPROVAL BY THE CITY OF LONE TREE. 14. APPROVAL OF THIS SITE IMPROVEMENT PLAN, CONSTITUTES A VESTED PROPERTY RIGHT PURSUANT TO ARTICLE 68 OF TITLE 24, C.R.S., AS AMENDED; THE ANNEXATION AND DEVELOPMENT AGREEMENT DATED APRIL 11, 2006, AS AMENDED; AND, THE LONE TREE MUNICIPAL CODE.

15. PHASE 1B CIVIL CONSTRUCTION DOCUMENTS SHALL BE PROVIDED TO THE CITY OF LONE TREE FOR REVIEW AND APPROVAL PRIOR TO THE PHASE 1B BUILDING PERMIT BEING ISSUED.

PARK MEADOWS MALL, LLC /

PARK MEADOWS ANCHOR ACQUISITION, LLC

8401 PARK MEADOWS CENTER DRIVE

LONE TREE, CO 80124

POC: PAUL MADDEN

PAUL.MADDEN@BPRETAIL.COM

ARCHITECT

LandDesign

2040 ADDISON ST BERKELEY CA, 94704 WWW.ELSARCH.COM P: 510-549-2929 POC: DAVID MASENTEN DMASENTEN@FLSARCH.COM

LANDSCAPE ARCHITECT



P: 720-274-0814 - EXT. 3508 POC: NURAIN RAFEE MRAFFF@LANDDFSIGN.COM

CIVIL ENGINEER

1120 Lincoln Street, Suite 100 Denver, Colorado 80203 P: 303.623.6300 F: 303.623.6311 HarrisKocherSmith.com POC: LIBBEY ENDERSBE LENDERSBE@HKSENG.COM

LIGHTING

MATERIALS BOARD

MATERIALS BOARD

102 W SAN FRANCISCO ST STE 15 SANTA FE, NM 87501 P: 906-283-2425 POC: ERIN GUSSERT ERIN.GUSSERT@RL.STUDIO

APPROVAL CERTIFICATION:

THIS SITE IMPROVEMENT PLAN WAS APPROVED FOR FILING BY THE COUNCIL OF THE CITY OF LONE TREE COLORADO, ON THE _____ DAY OF _____, 20___, SUBJECT TO ANY CONDITIONS SPECIFIED HEREON.

ALL EXPENSES INCURRED WITH RESPECT TO IMPROVEMENTS FOR ALL UTILITY SERVICES, PAVING, GRADING LANDSCAPING, CURBS, GUTTERS, SIDEWALKS, ROAD LIGHTING, ROAD SIGNS, FLOOD PROTECTION DEVICES. DRAINAGE STRUCTURES AND ALL OTHER IMPROVEMENTS THAT MAY BE REQUIRED SHALL BE THE RESPONSIBILITY OF THE DEVELOPER AND NOT THE CITY.

THIS ACCEPTANCE DOES NOT GUARANTEE THAT THE SOIL CONDITIONS, SUBSURFACE GEOLOGY, GROUNDWATER CONDITIONS OR FLOODING CONDITIONS OF ANY SITE SHOWN HEREON ARE SUCH THAT A BUILDING PERMIT WILL

MAYOR, CITY OF LONE TREE



Denver, Colorado 80203 P: 303.623.6300 F: 303.623.6311 HarrisKocherSmith.com

OWNER:

PARK MEADOWS MALL, LLC / PARK MEADOWS ANCHOR ACQUISITION, LLC 8401 PARK MEADOWS CENTER DRIVE LONE TREE, CO 80124

AMENDMEN

8TH

N O

FILING

 \bigcirc

TOWN

PARK

ABBREVIATIONS BUILDING CENTENNIAL WATER & SANITATION DISTRICT DENVER WATER DEPARTMENT EASEMENT **EXISTING** PROPOSED RIGHT-OF-WAY TYPICAL UTILITY

LAND AREA SUMMARY TABLE			
DESIGNATION	AREA (SF)	AREA (AC)	% OF TOTAL AREA
LOT 4-C-1	188,297	4.32	100
PLAZA AREA*	29,600	0.68	9
RIGHT-OF-WAY	0	0	0
PARK MEADOWS TOWN CENTER FILING NO. 1-A, 8TH AMENDMENT	188,297	4.32	100

BLDG

CWSD

ESMT

PR

UTIL

*THE PLAZA AREA IS A PORTION	OF LOT 4-C-1 AND IS NOT A	N ADDEND TO THE TOTAL AREA FIGURES.

<u>PARKING CALCULATION</u>	ITABLE		
PARKING REQUIRED			
	NUMBER OF UNITS/SQ FT FLOOR AREA	PARKING PER UNIT	TOTAL
RETAIL OR WHOLESALE, GENERAL	20,070	1 SPACE PER 250 SQ FT OF FLOOR AREA	81
TOTAL PARKING REQUIRED			81
PARKING PROVIDED			
PARKING GARAGE			
STANDARD			974
HANDICAP			20
SURFACE PARKING			
STANDARD			3
LOADING/DROP OFF			4
TOTAL PARKING PROVIDED			1,001

ITEM	SQUARE FOOTAGE	% OF GROSS SITE
GROSS SITE AREA (LOT 4-C-1)	188,297	100
TOTAL BUILDING FOOTPRINT	89,256	47
GARAGE*	69,186	37
RETAIL*	20,070	10
PARKING/ROADS	35,553	19
LANDSCAPED AREA	28,245	15
HARDSCAPED AREA	35,243	19
UILDING SIZE		
MAXIMUM HEIGHT (AS MEASURED BY THE CITY'S BUILDING CODE)		
GARAGE	65'-3"	
RETAIL	20'-0"	
TOTAL FLOOR AREA (SEE DEFINITION OF FLOOR AREA IN SECTION 16, ARTICLE XXXVI)		
GARAGE	339,355	
RETAIL	20,070	
PARKING		
REQUIRED	81	
PROVIDED	1,001	
BICYCLE PARKING		
REQUIRED	0	
PROVIDED (GARAGE/BUILDING)	0	
PROVIDED (SURFACE)	14	


*THE TOTAL BUILDING FOOTPRINT AREA IS COMPRISED OF THE GARAGE AND RETAIL AREAS WHICH ARE NOT ADDENDS TO THE GROSS SITE AREA.


DATE	REVISION COMMENTS			
03-29-2024	1ST SUBMITTAL			
05-10-2024	2ND SUBMITTAL			
06-04-2024	3RD SUBMITTAL			
PROJECT #: 231016				


COVER SHEET


SHEET NUMBER

Know what's **below**. Call before you dig.

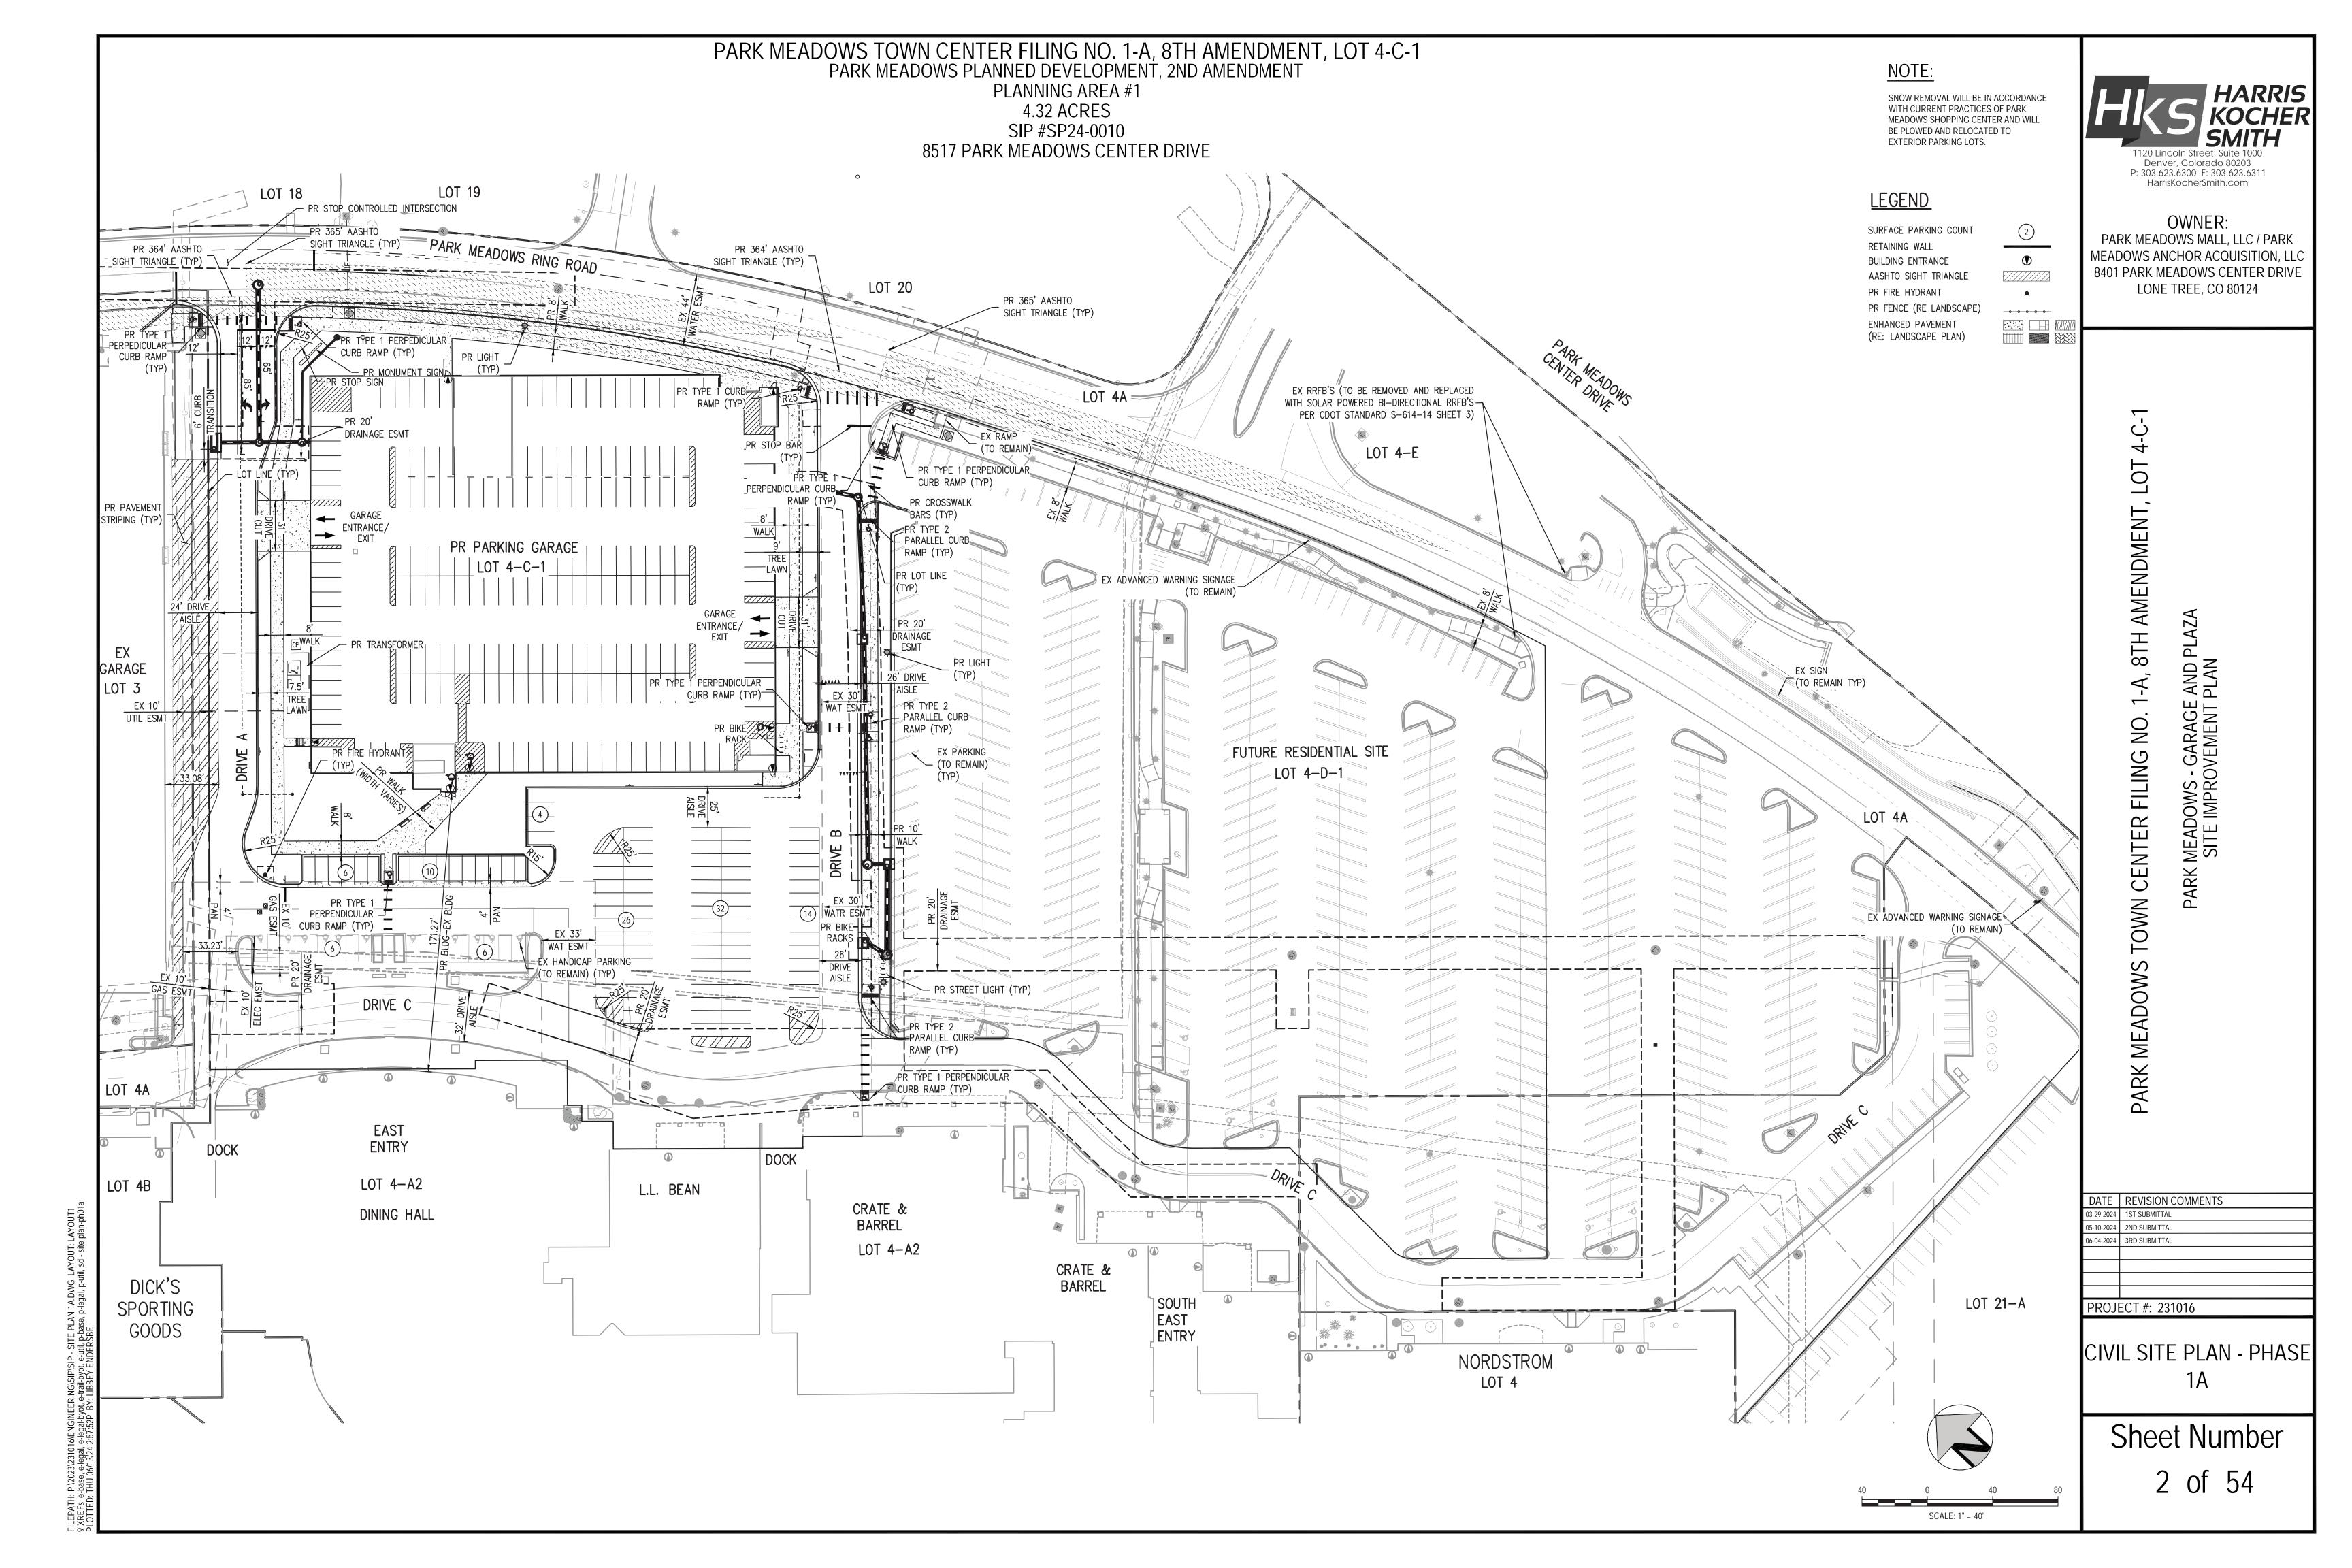

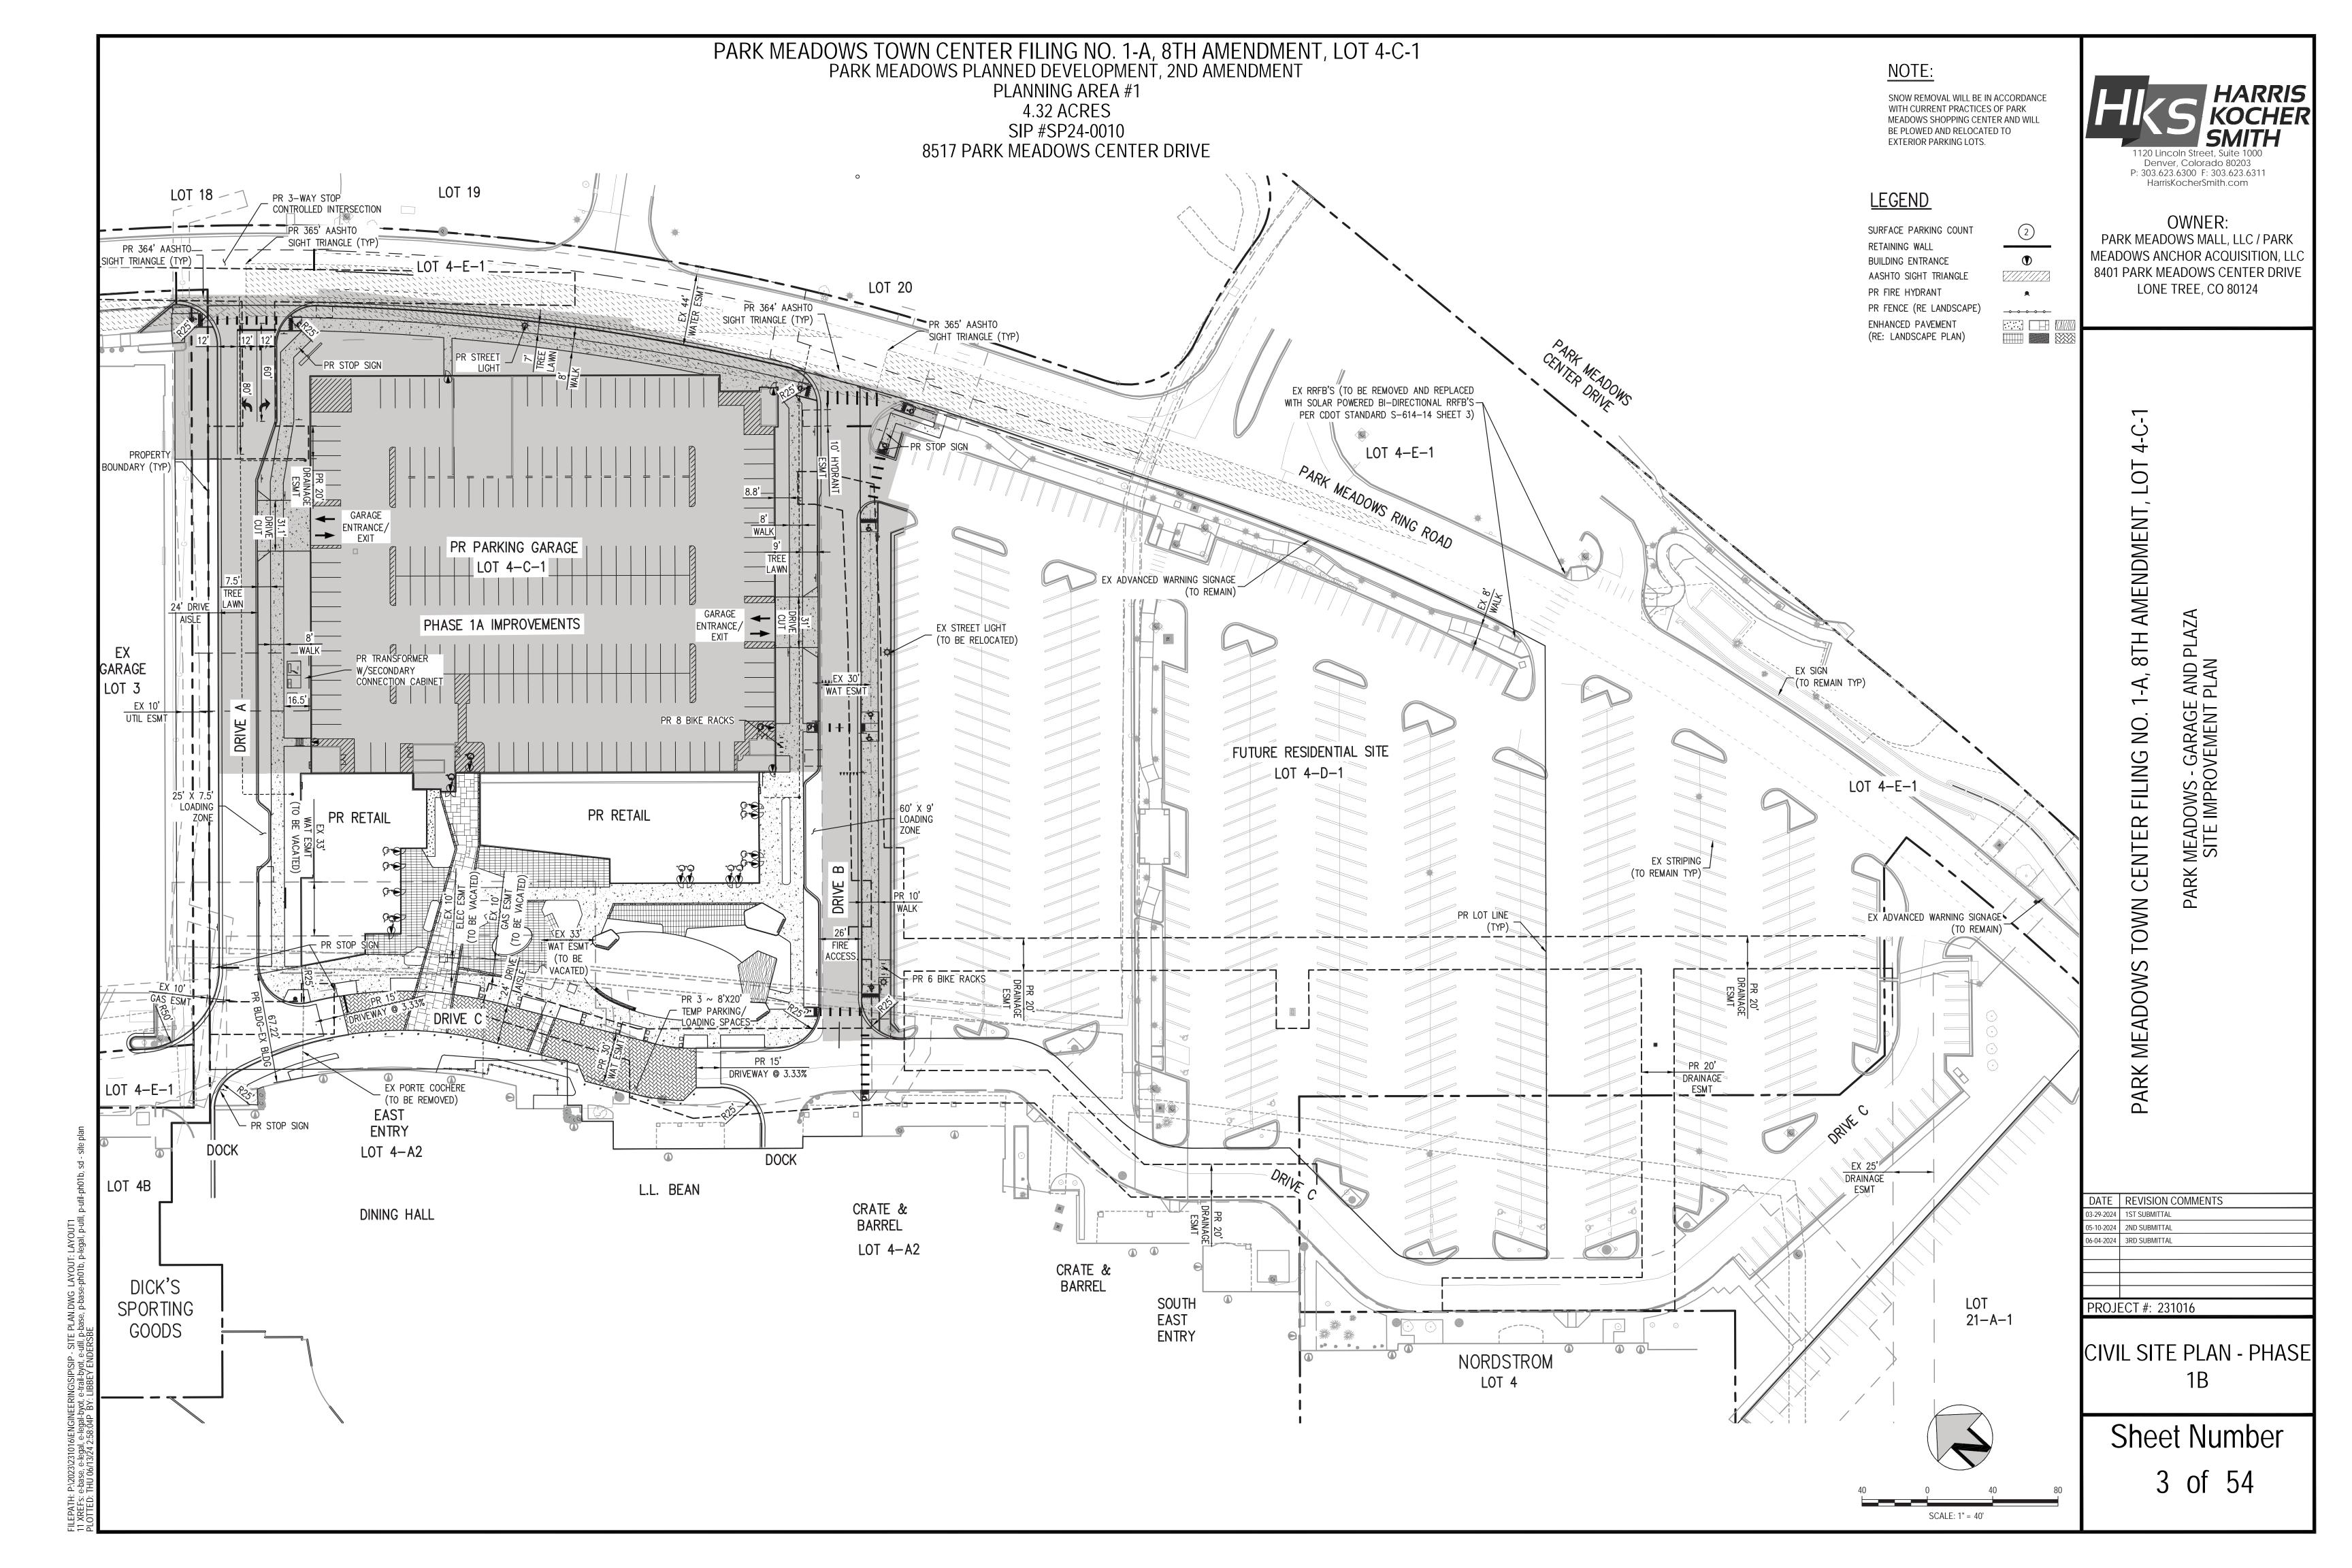

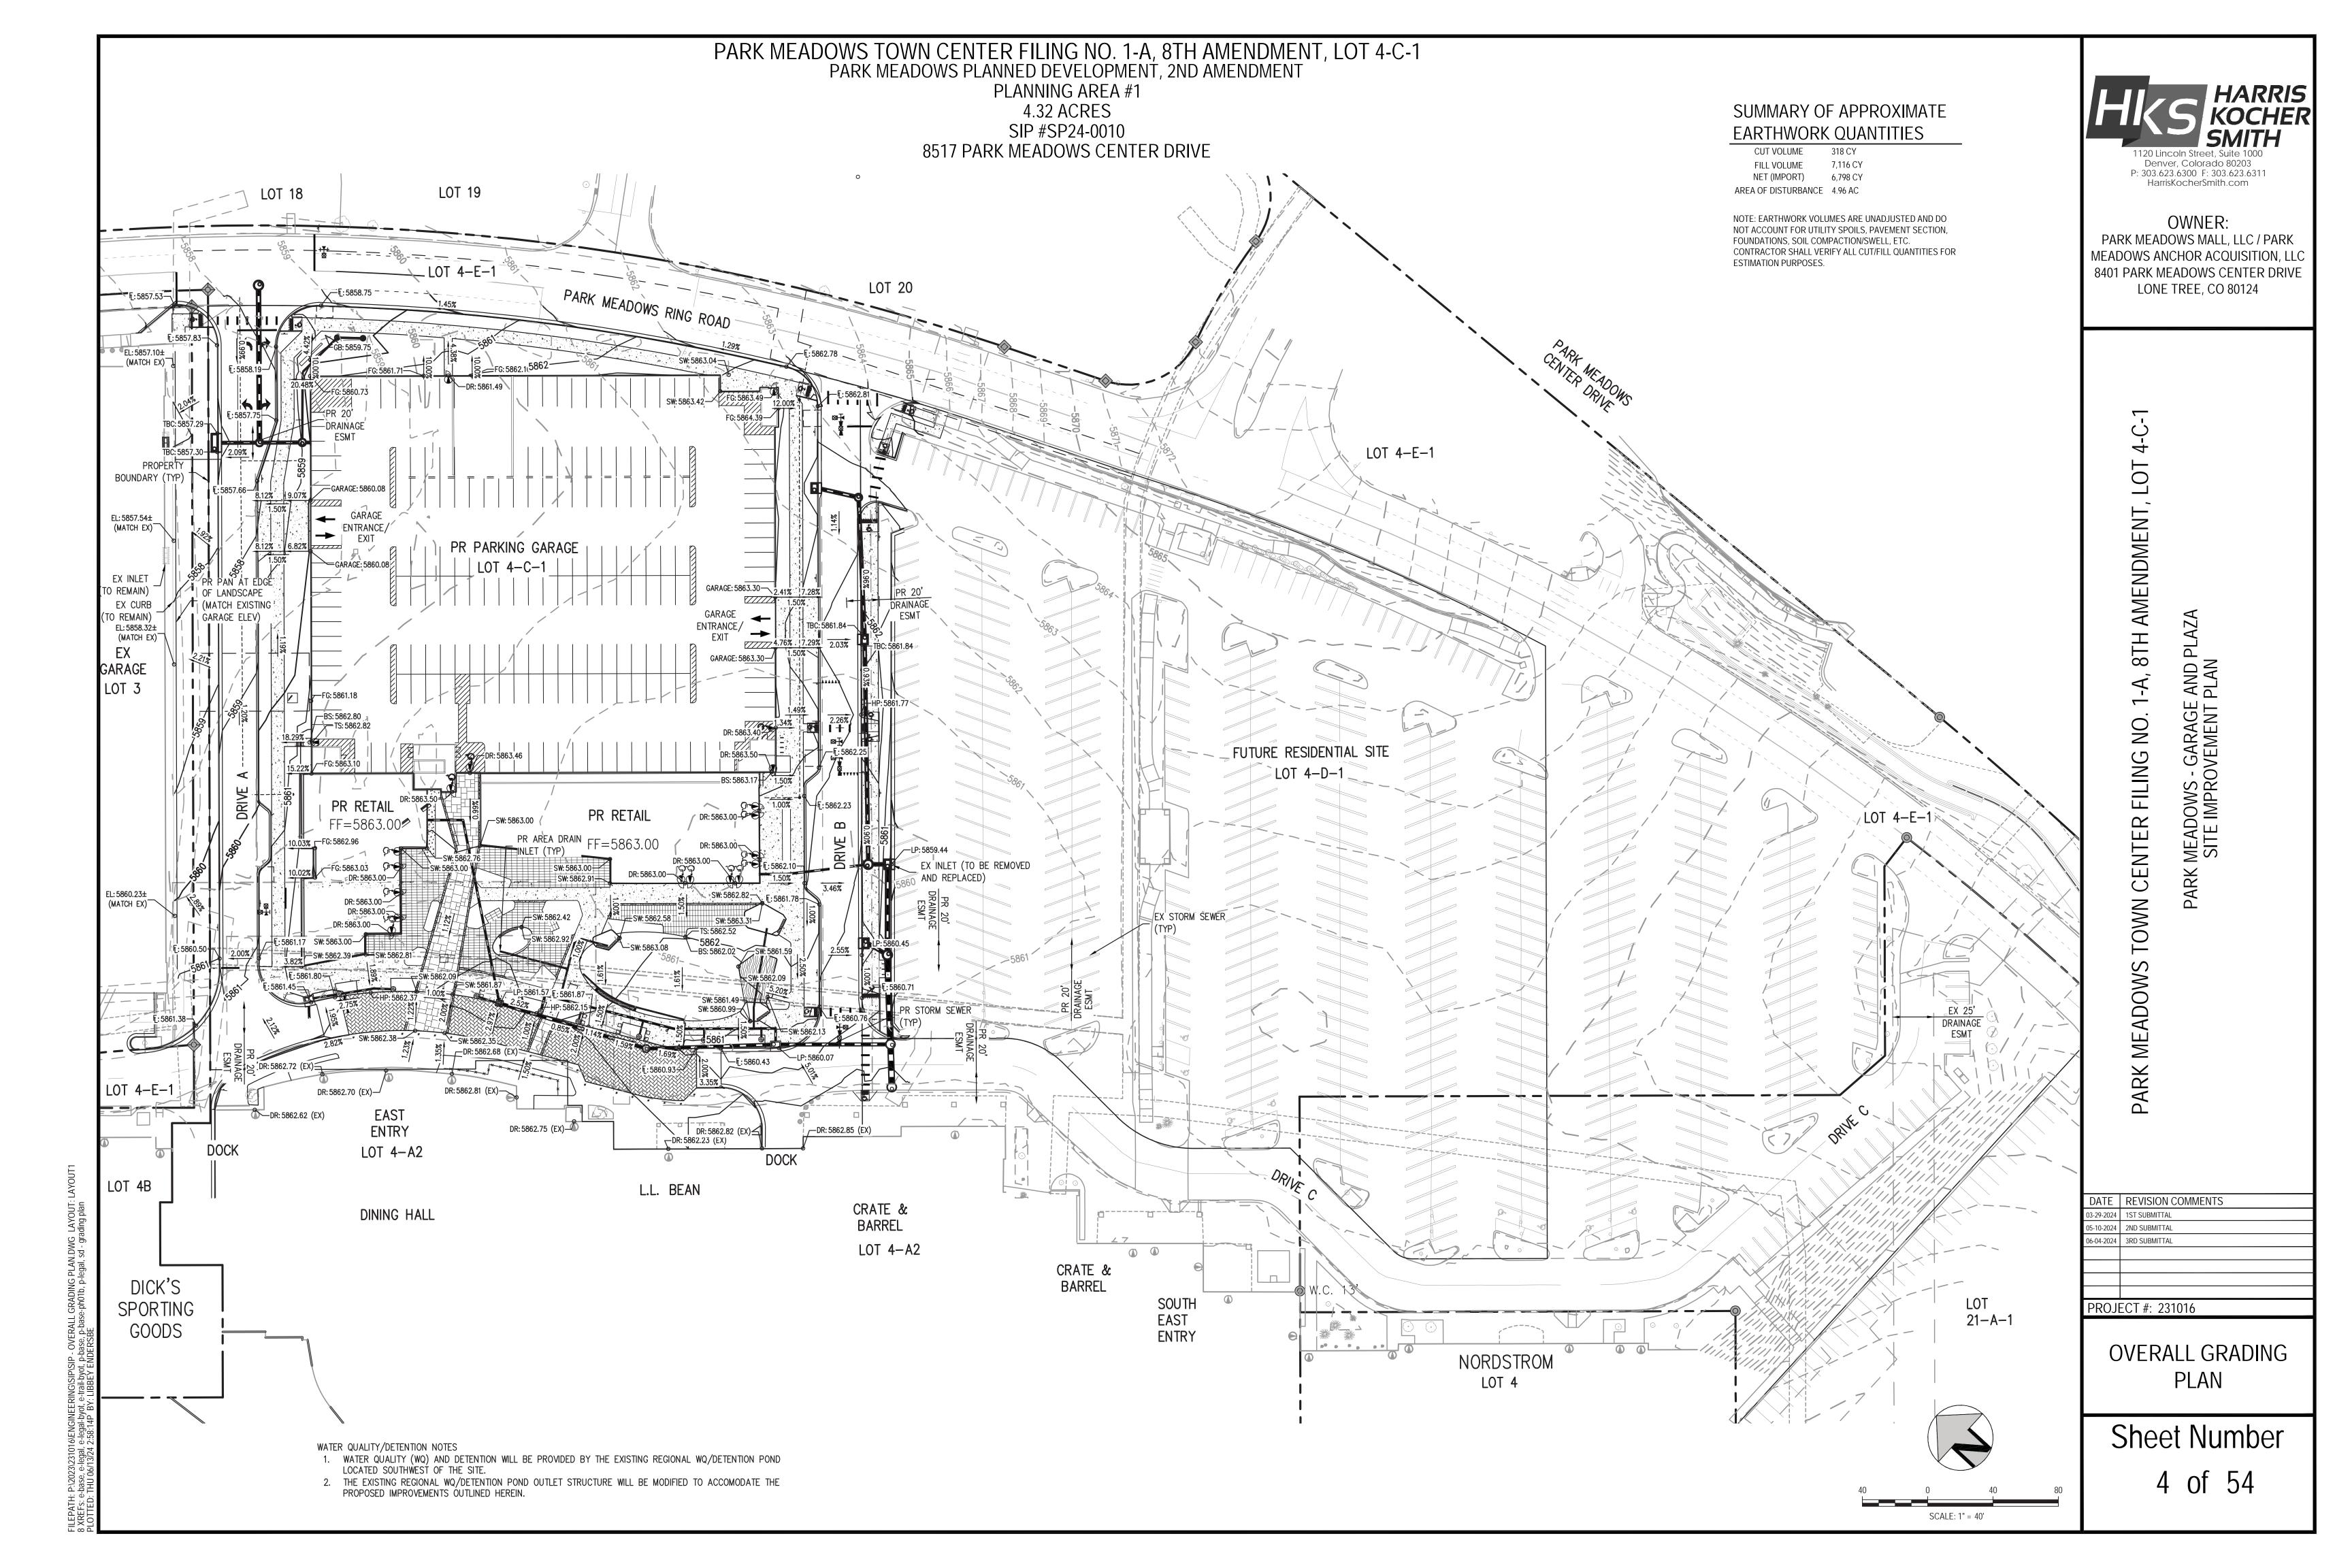

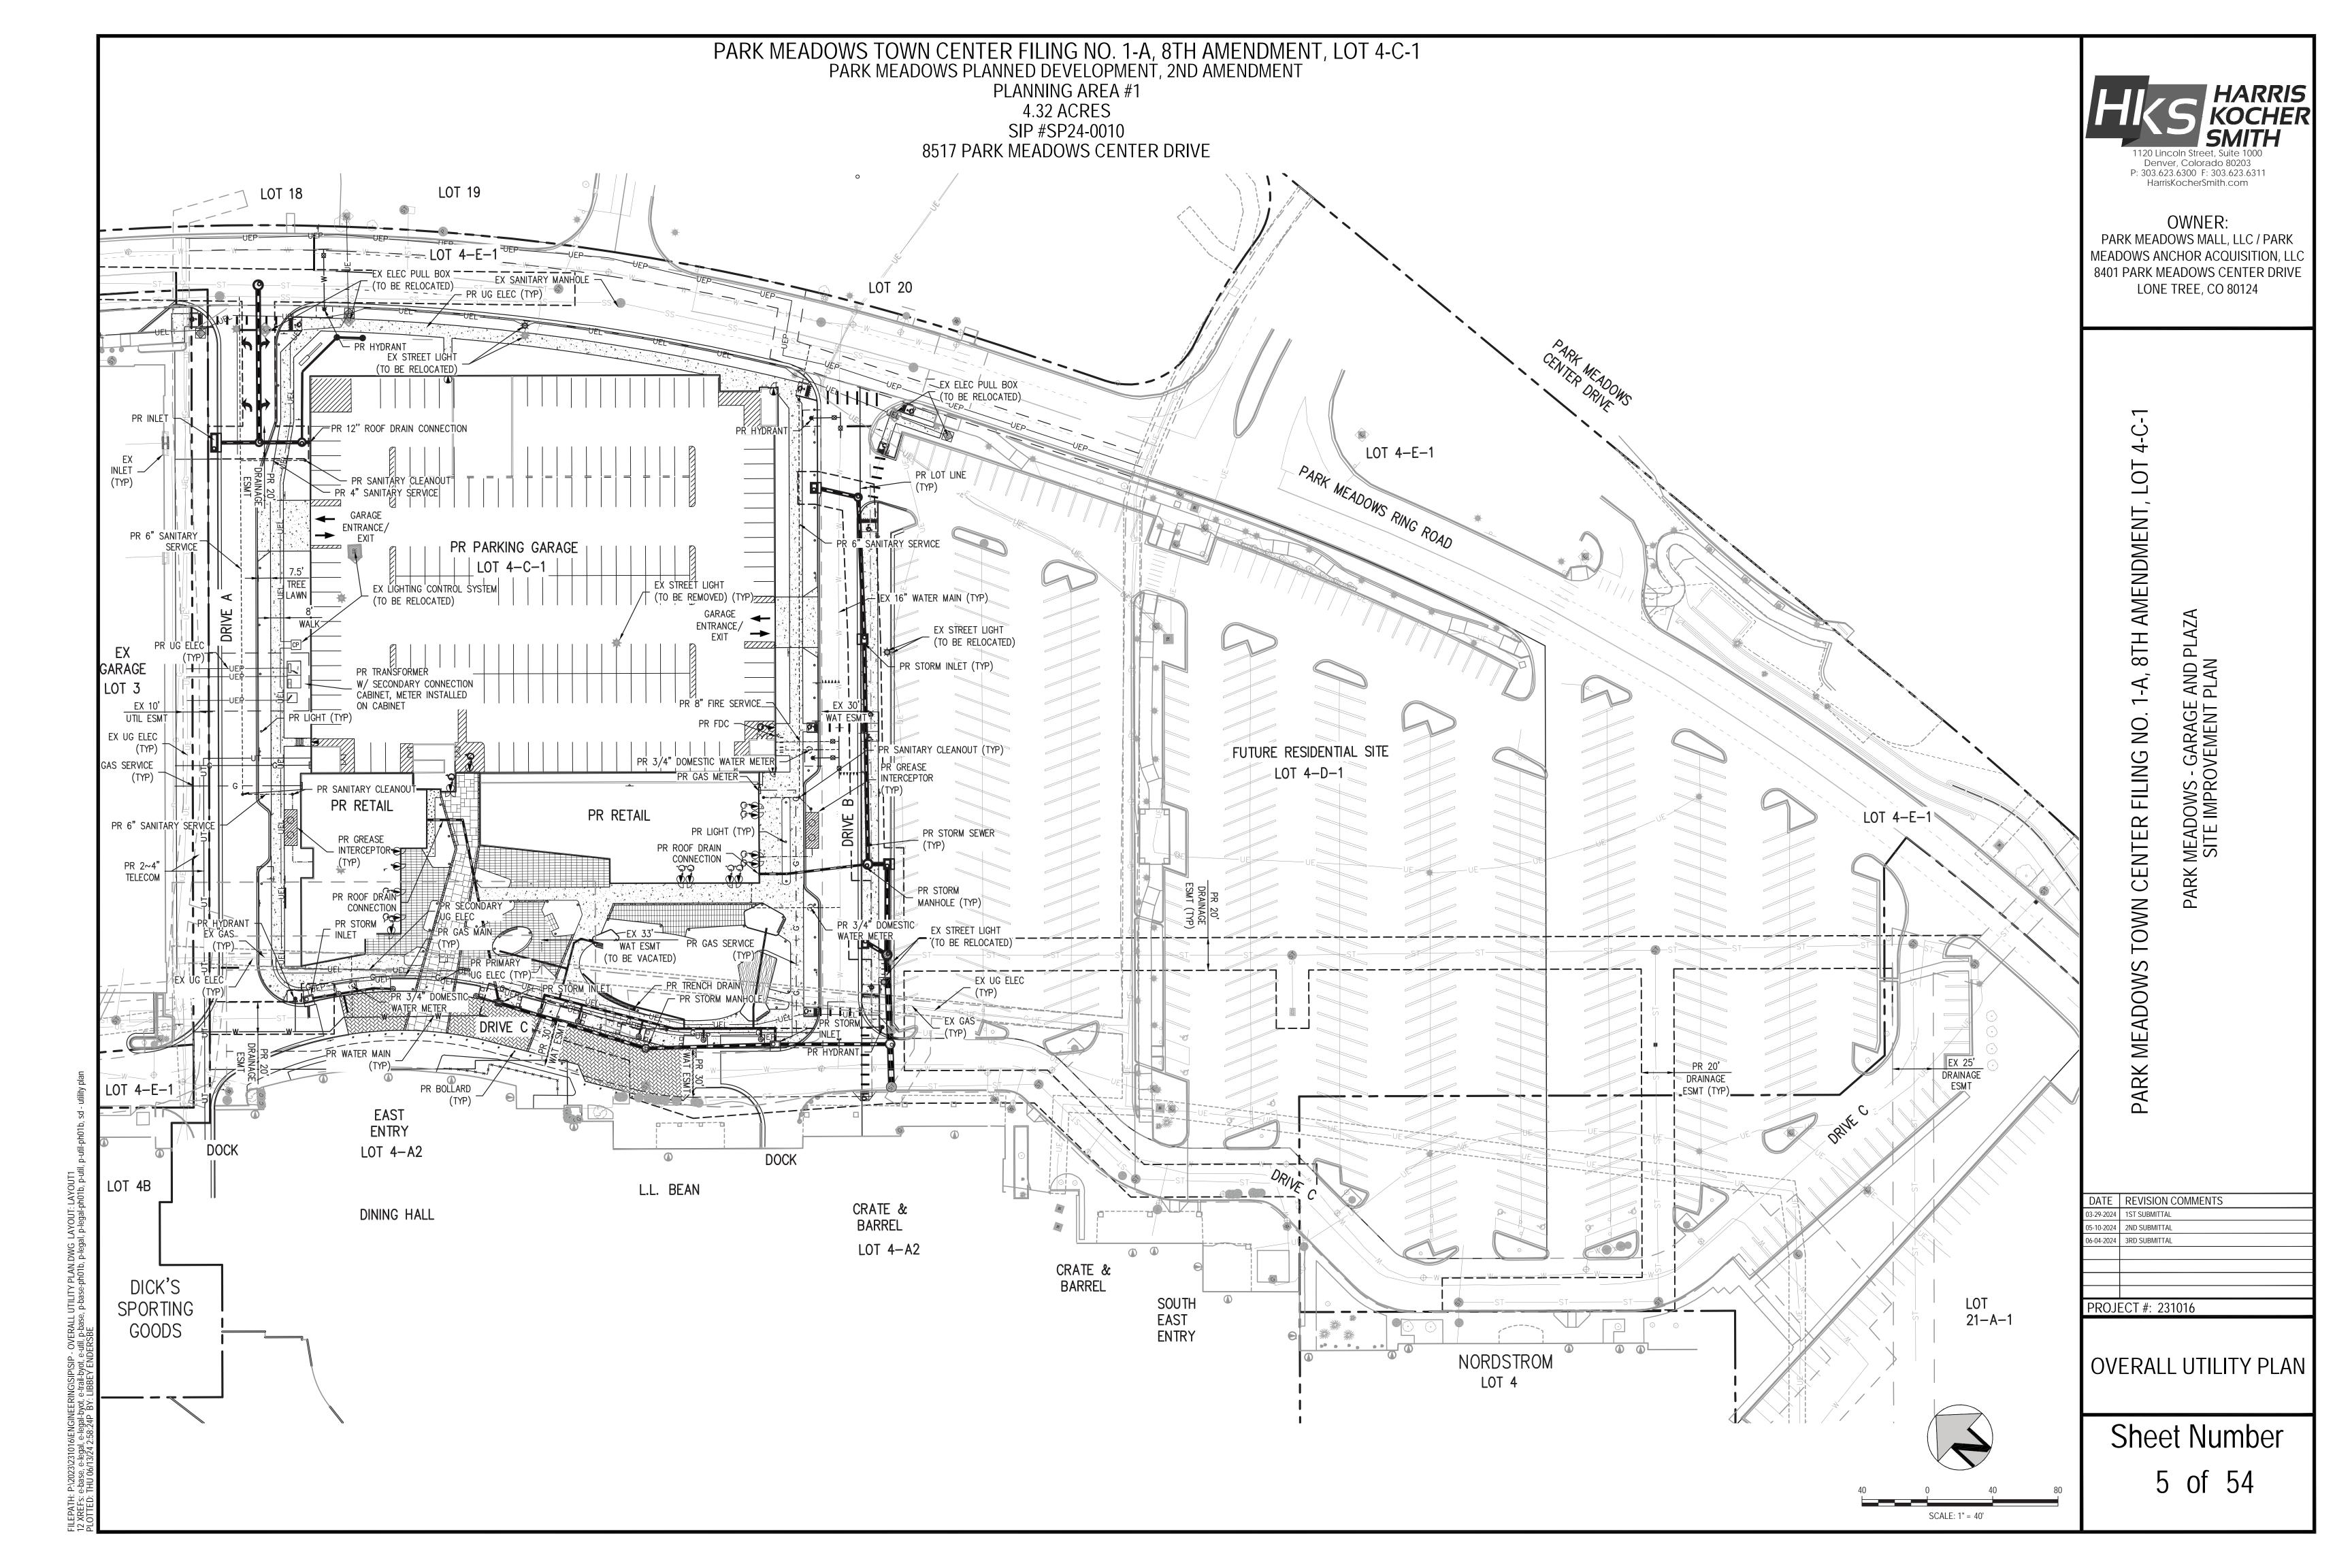

CONCEPTUAL LANDSCAPE PLAN - PHASE 1B

SCALE: 1" = 30' - 0"

LandDesign.

1360 WALNUT STREET, SUITE 102 BOULDER CO, 80302 720.274.0814 WWW.LANDDESIGN.COM

OWNER: PARK MEADOWS MALL, LLC / PARK MEADOWS ANCHOR ACQUISITION, LLC 8401 PARK MEADOWS CENTER DRIVE LONE TREE, CO 80124

PARK MEADOWS - GARAGE AND PLAZA SITE IMPROVEMENT PLAN

LOT 1-A, 8TH AMENDMENT, FILING NO.

CENTER

PARK MEADOWS

DATE REVISION COMMENTS

PROJECT #: 231016

SCALE: 1" = 30'

CONCEPTUAL LANDSCAPE PLAN

Sheet Number

06 of 54

PARK MEADOWS TOWN CENTER FILING NO. 1-A, 8TH AMENDMENT, LOT 4-C-1 PARK MEADOWS PLANNED DEVELOPMENT, 2ND AMENDMENT PLANNING AREA #1 4.32 ACRES

SIP #SP24-0010 8517 PARK MEADOWS CENTER DRIVE

LANDSCA	APE SCHEDULE							
CODE	DESCRIPTION	MANUFACTURER	MODEL	SIZE	COLOR	MATERIAL	MIX	REMARKS
L-101	ORGANIC MULCH	PIONEER LANDSCAPE	-	-			-	PROVIDE 3" THICKNESS AT ALL PLANTING BEDS
L-102	RIVER ROCK	PIONEER LANDSCAPE	3/4" MOUNTAIN GRANITE	3/4"	STD.		-	
L-103	NATURAL STONE BOULDER	-	-	-	-	-	-	-

CODE	DESCRIPTION	MANUFACTURER	MODEL	SIZE	MATERIAL	COLOR	FINISH	PATTERN / JOINT	REMARKS
P-101	STANDARD GRAY CONCRETE	-	-	-	CONCRETE	STANDARD GRAY		SAWCUT	SMOOTH BRUSH FINISH PERPENDICULAR TO PATH OF TRAVEL
P-102	ENHANCED PAVING - TYPE 1	TECHO-BLOC	BLU 80 SLATE	3 1/8" X 13" X 6 1/2, 3 1/8" X 13" X 13", 3 1/8" X 13" X 19 1/2'	CONCRETE	CHESTNUT BROWN		MODULAR PATTERN	ALT: HANOVER PAVERS
P-103	ENHANCED PAVING - TYPE 2	TECHO-BLOC	MIKA	2 3/4" X 4 7/16" X 11	' CONCRETE	ROCK GARDEN BROWN		TBD	ALT: HANOVER PAVERS
P-104	ENHANCED VEHICULAR PAVING - TYPE 1	TECHO-BLOC	BLU 80 SLATE	3 1/8" X 13" X 6 1/2"	CONRETE	CHESTNUT BROWN		RUNNING BOND	ATL: HANOVER PAVERS
P-105	ENHANCED VEHICULAR PAVING - TYPE 2	TECHO-BLOC	INDUSTRIA GRANITEX	3 1/8" X 13" X 6 1/2"	CONCRETE	SHALE GRAY			ALT: HANOVER PAVERS
P-106	PAVER BANDING	TECHO-BLOC	BLU 80	3 1/8" X 13" X 6 1/2"	CONCRETE	CHOCOLATE BROWN	SLATE	TBD	ALT: INTEGRAL COLORED CONCRETE
P-107	SYNTHETIC TURF	SYNLAWN	SYNAUGUSTINE 547						
P-108	WOOD DECKING	TREX	COMPOSITE DECKING						ALT: COMPOSITE DECKING
P-109	CONCRETE RAMP				CONCRETE	STANDARD GRAY			
P-110	EXISTING PAVEMENT								

CODE	DESCRIPTION	MANUFACTURER	MODEL	SIZE	MATERIAL	COLOR	FINISH	MOUNT	REMARKS
S-101	SITE BENCH - TYPE 1	SITE PIECES	MONOLINE BACKED BENCH (ML-BENCH-72)	72" X 27" X 38.5"	METAL AND WOOD	DARK BRONZE	POWDER COATED	SURFACE MOUNTED	-
S-102	SITE BENCH - TYPE 2	LANDSCAPE FORMS	SOCRATES	24"	CAST STONE	WHITE	POLISHED	FREESTANDING	
S-103	SITE BENCH - TYPE 3	SITE PIECES	CONCRETE AND MONOLINE TOPPER						ALT: DECKING CONSTRUTION
S-104	BOLLARD	BEGA	WOOD SYSTEM BOLLARD	32"	METAL AND WOOD	-	POWDER COATED METAL	EMBEDDED	
S-105	TRASH & RECYCLING RECEPTACLE	MMCITE	MULTIMINUM (MMUM566)	-	ALUMINUM	ANTHRACITE GRAY		SURFACE	-
S-107	SITE BENCH - TYPE 4	SITE PIECES	ALPINE CASCADE CHAISE	58.3" x 23.5" x 30"H	METAL & WOOD	TO BE COORDINATED	POWDER COATED	SURFACE	
S-108	CUSTOM PLANTER - TYPE 1	ORE DESIGN	CUSTOM	SEE DETAIL	METAL	RUST	POWDER COATED	SEE DETAIL	
S-109	CUSTOM PLANTER - TYPE 2	ORE DESIGN	CUSTOM	SEE DETAIL	METAL	RUST	POWDER COATED	SEE DETAIL	
S-110	CUSTOM PLANTER - TYPE 3	ORE DESIGN	CUSTOM	SEE DETAIL	METAL	RUST	POWDER COATED		
S-111	CUSTOM PLANTER - TYPE 4	ORE DESIGN	CUSTOM	SEE DETAIL	METAL	RUST	POWDER COATED		
S-112	BIKE RACK	LANDSCAPE FORMS	RIDE BIKE RACK	-	METAL	BRONZE METALLIC	POWDER COATED	EMBEDED	
S-113	PLANTER POTS	TOURNESOL	DELTA GFRC	VARYING SIZES	CONCRETE	SHARK	ACID ETCH	SURFACE	CONTRACTOR TO PROVIDE COLOR SAMPLE PRIOR TO FINA SELECTION

1360 WALNUT STREET, SUITE 102 BOULDER CO, 80302 720.274.0814 WWW.LANDDESIGN.COM

OWNER: PARK MEADOWS MALL, LLC / PARK MEADOWS ANCHOR ACQUISITION, LLC 8401 PARK MEADOWS CENTER DRIVE LONE TREE, CO 80124

PARK MEADOWS - GARAGE AND PLAZA SITE IMPROVEMENT PLAN

FILING NO. 1-A, 8TH AMENDMENT, LOT 4-C-1

PARK MEADOWS TOWN CENTER

DATE REVISION COMMENTS 03-29-2024 1ST SUBMITTAL 05-10-2024 2ND SUBMITTAL 06-03-2024 3RD SUBMITTAL PROJECT #: 231016

> MATERIALS SCHEDULE

Sheet Number

PARK MEADOWS TOWN CENTER FILING NO. 1-A, 8TH AMENDMENT, LOT 4-C-1 PARK MEADOWS PLANNED DEVELOPMENT, 2ND AMENDMENT

PLANNING AREA #1 4.32 ACRES SIP #SP24-0010

8517 PARK MEADOWS CENTER DRIVE

GENERAL NOTES

1. THIS AMENDMENT INCLUDES THE ADDITION OF AN ENTRY PLAZA AND A PARKING STRUCTURE TO THE PARK MEADOWS MALL.

- 1. UNLESS OTHERWISE SPECIFIED, TREES SHALL BE PLANTED NO LESS THAN 4' FROM CURBS, UTILITY LINES, AND SCREENING WALLS. THE CITY HAS FINAL APPROVAL FOR ALL TREE PLACEMENTS.
- 2. ALL PLANTS SHALL BE GROWN AND HARVESTED IN ACCORDANCE WITH THE AMERICAN STANDARD FOR NURSERY STOCK (ANSI Z60.1-2004)
- 3. TREE PLANTING SHALL COMPLY WITH DETAILS HEREIN AND THE INTERNATIONAL SOCIETY OF ARBORICULTURE (ISA) STANDARDS.
- 4. TREE PITS SHALL BE TESTED FOR WATER PERCOLATION. IF WATER DOES NOT DRAIN OUT OF TREE PITS WITHIN 24-HOURS, THE TREE SHALL BE MOVED OR DRAINAGE SHALL BE PROVIDED.
- 5. NATIVE SITE TOPSOIL TO BE PROTECTED FROM EROSION OR STOCKPILED.
- 6. NATIVE SITE TOPSOIL SHALL BE LABORATORY TESTED BY ACCREDITED
- LABORATORY AND AMENDED PER SAID LABORATORY'S RECOMMENDATIONS.

 7. ALL PLANTS INSTALLED SHALL FOLLOW THE PLANT SCHEDULE, INSTALLATION INSTRUCTIONS AND LANDSCAPE DRAWINGS ON THE APPROVED LANDSCAPE PLAN INCLUDED IN THIS SITE IMPROVEMENT PLAN. ANY CHANGES TO THE APPROVED LANDSCAPE PLAN, TO INCLUDE PLANT SUBSTITUTIONS, MUST BE APPROVED BY THE CITY IN ADVANCE OF INSTALLATION.
- 8. ALL MULCH AND/ OR ROCK COBBLE SHALL BE INSTALLED AND MAINTAINED TO THE DEPTH(S) PROVIDED ON THE APPROVED LANDSCAPE PLAN INCLUDED IN THIS SITE IMPROVEMENT PLAN. ORGANIC MULCH SHALL NOT BE PLACED WITHIN SIX (6) FEET OF STORM INLETS.
- 9. THE USE OF IMPERMEABLE SHEET PLASTIC AS A WEED BARRIER IS PROHIBITED
- 10. ALL SOILS FOR GENERAL LANDSCAPING AREAS OR ON WHICH ANY COOL-SEASON LAWN, TURF OR SOD IS TO BE INSTALLED MUST BE PROPERLY AMENDED WITH ORGANIC MATTER SUCH AS COMPOST AND AGED MANURE. A MINIMUM OF FOUR (4) CUBIC YARDS OF COMPOST PER EACH THOUSAND (1,000) SQUARE FEET OF SOIL SHOULD BE INCORPORATED TO A DEPTH OF AT LEAST FOUR (4) TO SIX (6) INCHES BY ROTOTILLING OR OTHER SUITABLE MEASURES. STRUCTURED SOILS THAT INCLUDE ROCK AND SAND TO REDUCE COMPACTION AND INCREASE POROSITY FOR ROOT GROWTH MAY BE REQUIRED WHERE TREE GRATES ARE PROPOSED.
- 11. ORGANIC MULCH SUCH AS WOOD/BARK SHALL BE INSTALLED AND MAINTAINED TO A DEPTH OF FOUR (4) INCHES.

IRRIGATION STANDARDS

- 1. IRRIGATION OVERSPRAY ON STREETS AND WALKS IS PROHIBITED.
- 2. MAINLINES, VALUES, OR CONTROL WIRES SHALL NOT BE LOCATED IN THE R.O.W. 3. ET IRRIGATION CONTROLLERS SHALL BE PROGRAMMED AND ADJACENT TO NOT EXCEED THE LANDSCAPE WATER ALLOWANCE (LWA) PRIOR TO APPROVAL OF LANDSCAPE INSTALLATION.
- 4. VALVES SHALL BE LOCATED A MINIMUM OF THREE (3) FEET AWAY FROM STORM SEWERS, AND SANITARY SEWER LINES AND FIVE (5) FEET FROM CITY FIRE HYDRANTS AND WATER VALVES.
- 5. THE BORE DEPTH UNDER STREETS, DRIVE AISLES, AND FIRE LANES SHALL PROVIDE TWO (2) FEET OF CLEARANCE (MINIMUM).
- 6. IRRIGATION HEADS THAT RUN PARALLEL NEAR PUBLIC WATER AND SANITARY SEWER LINES; SHALL BE FED FROM STUBBED LATERALS OR BULL-BEADS. A MINIMUMS FIVE (5) FEET SEPARATION IS REQUIRED BETWEEN IRRIGATION MAIN LINES AND LATERALS THAT RUN PARALLEL TO PUBLIC WATER SANITARY SEWER LINES.
- 7. NO VALVES, BACKFLOW PREVENTION ASSEMBLIES, QUICK COUPLERS ECT. SHALL BE LOCATED CLOSER THAN TEN (10) FEET FROM THE CURB AT STREET DRIVEWAY INTERSECTIONS.
- 8. IRRIGATION SHALL OCCUR BETWEEN THE HOURS OF 8:00 P.M. AND 6 A.M.
 9. ANY IRRIGATION EQUIPMENT MOUNTED TO THE BUILDING SHALL BE PAINTED TO MATCH THE BUILDING

MAINTENANCE STANDARDS

1. THE OWNER SHALL BE RESPONSIBLE FOR THE ESTABLISHMENT, MAINTENANCE, AND VIGOR OF PLANT MATERIAL IS ACCORDANCE WITH THE DESIGNER AND AS APPROPRIATE FOR THE SEASON OF THE YEAR.


2. LANDSCAPE AND OPEN AREAS HALL BE FREE OF TRASH, LITTER, AND WEEDS.

3. ALL TREES AND SHRUBS SHALL BE MAINTAINED IN ACCORDANCE WITH ENGINEERING DESIGN STANDARDS - PUBLIC R.O.W. VISIBILITY REQUIREMENTS.


4. TREE MAINTENANCE SHALL BE ACCORDANCE WITH THE AMERICAN NATIONAL STANDARDS FOR TREE CARE OPERATIONS, ANSI A300 AND THE STANDARDS OF THE INTERNATIONAL SOCIETY OF ARBORICULTURE (ISA).

5. TREE STAKING MATERIALS, IF USED, SHALL BE REMOVED AFTER ONE (1) GROWING SEASON AND NOT MORE THAN ONE (1) YEAR AFTER INSTALLATION.

STEEL TREE STAKES, WIRES AND HOSES ARE PROHIBITED.

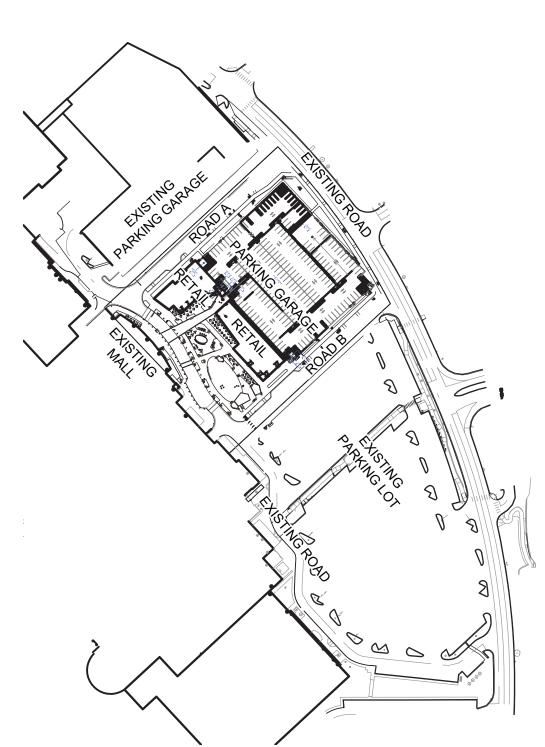



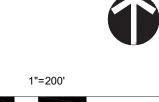

LandDesign.

1360 WALNUT STREET, SUITE 102 BOULDER CO, 80302 720.274.0814

OWNER:
PARK MEADOWS MALL, LLC / PARK
MEADOWS ANCHOR ACQUISITION, LLC
8401 PARK MEADOWS CENTER DRIVE
LONE TREE, CO 80124

PARK MEADOWS - GARAGE AND PLAZA

LOT

AMENDMENT,

NO.

FILING

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PARK


DATE REVISION COMMENTS
03-29-2024 1ST SUBMITTAL


05-10-2024 2ND SUBMITTAL
06-03-2024 3RD SUBMITTAL

PROJECT #: 231016

LANDSCAPE NOTES

Sheet Number 08 of 54

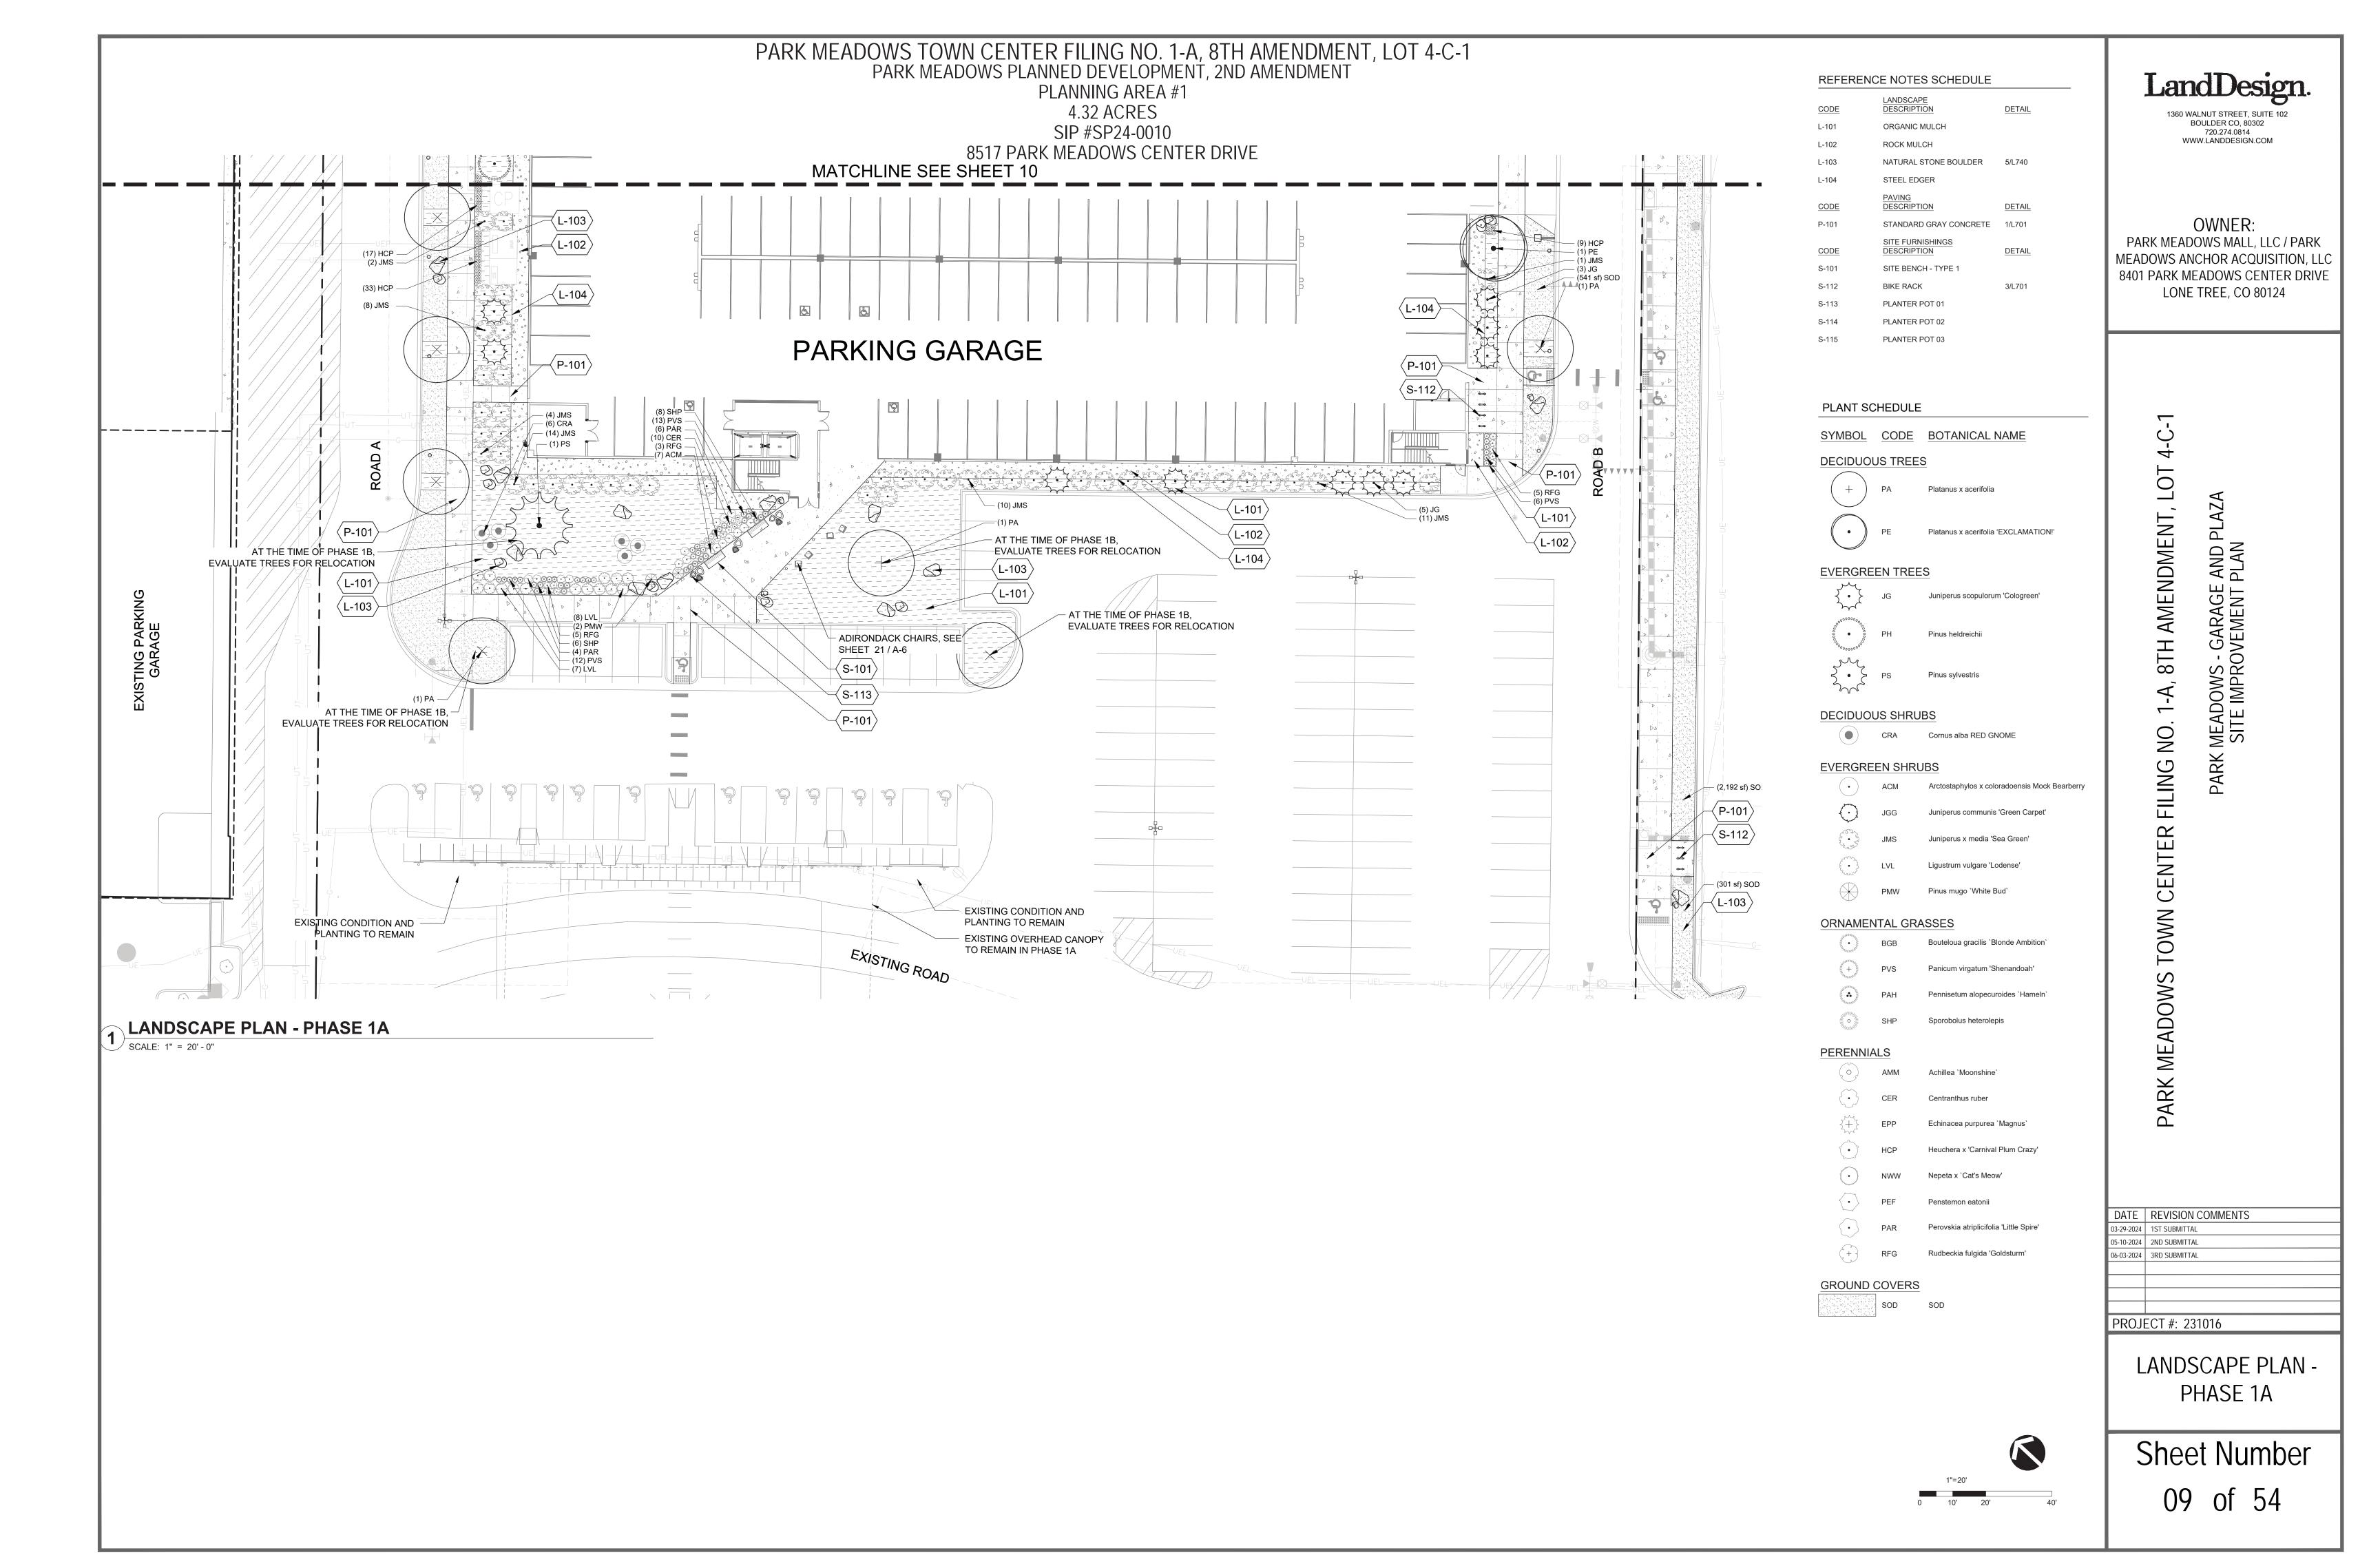

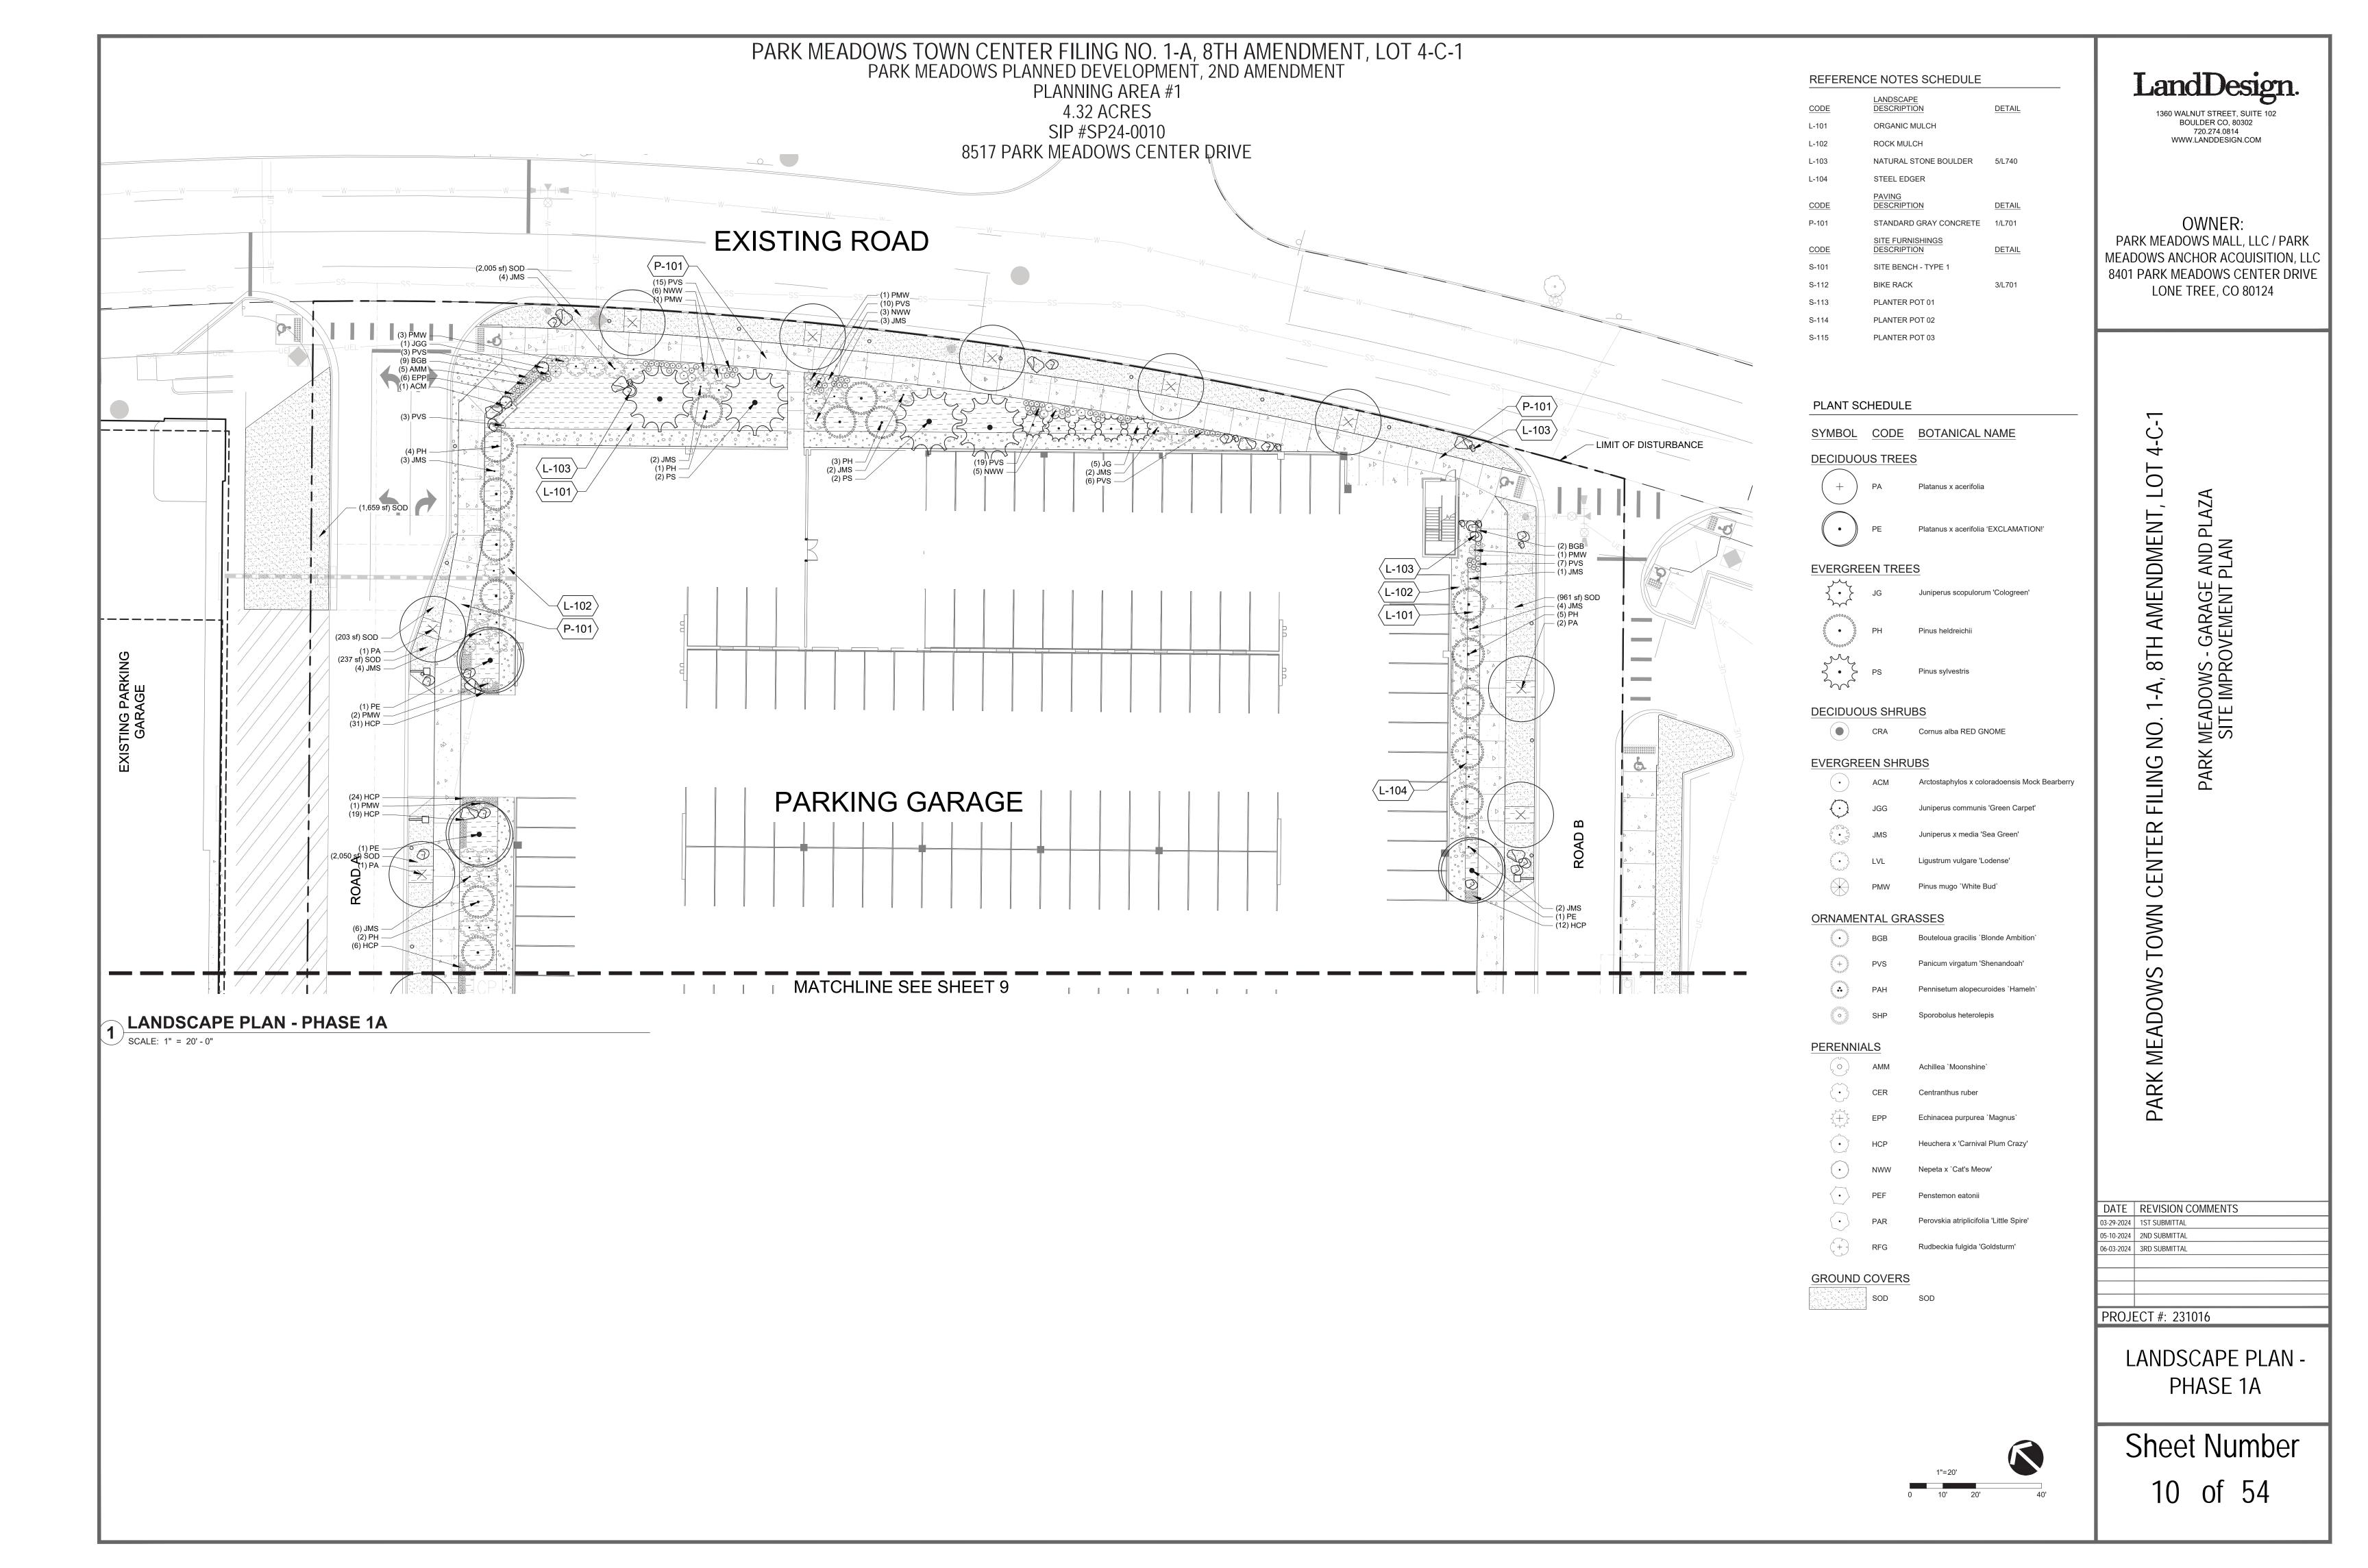

PARK MEADOWS TOWN CENTER FILING NO. 1-A, 8TH AMENDMENT, LOT 4-C-1 PARK MEADOWS PLANNED DEVELOPMENT, 2ND AMENDMENT PLANNING AREA #1

4.32 ACRES SIP #SP24-0010

8517 PARK MEADOWS CENTER DRIVE

TOLERANT

SYMBOL	CODE	QTY	BOTANICAL NAME	COMMON NAME	CONT.	SIZE	SPEC SIZE	WATER USE	REMARKS	- SALT TOLERANCI
DECIDUO			DOTANICAL NAME	COMMON NAME	CONT.	SIZL	OI LO SIZE	WATEROOL	ILIMAINO	SALT TOLLIVANO
\bigcirc	PE	4	plantanus x acerifolia 'EXCLAMATION!'	Planetree EXCLAMATION!	B&B	2" CAL		MODERATE		
+	PA	16	Platanus x acerifolia	London Plane Tree	2" CAL					
EVERGRE	EN TREE	S								
\.\\\\\\\\\\\\\\\\\\\\\\\\\\\\\\\\\\\\	JG	15	Juniperus scopulorum 'Cologreen'	Colorgreen Juniper	B&B	6' HT		VERY LOW		TOLERANT
000000000000000000000000000000000000000	РН	15	Pinus heldreichii	Bosnian Pine	B&B	6` HT MIN.		LOW		SENSITIVE
	PS	5	Pinus sylvestris	Scotch Pine	B&B	9' - 10' HT MIN		MODERATE TO LOW		
SYMBOL	CODE	QTY	BOTANICAL NAME	COMMON NAME	CONT	SPACING	SPEC SIZE	WATER USE	REMARKS	
DECIDUO	JS SHRU	BS								
	CRA	6	Cornus alba RED GNOME	ARCTIC FIRE Dogwood	#5	42" O.C.		MODERATE		
EVERGRE	EN SHRL	JBS_								
•	ACM	7	Arctostaphylos x coloradoensis Mock Bearberry	Mock Bearberry Manzanita	#3	30" O.C.	10" - 15" HT	LOW		
\bigcirc	JGG	2	Juniperus communis 'Green Carpet'	Green Carpet Common Juniper	#5	36" O.C.		LOW		
1 - 1 - 1 - 1 - 1 - 1 - 1 - 1 - 1 - 1 -	JMS	78	Juniperus x media 'Sea Green'	Sea Green Juniper	5 GAL			LOW		
**************************************	LVL	15	Ligustrum vulgare 'Lodense'	Lodense Privet	#5	36" O.C.	24" HT			
	PMW	11	Pinus mugo `White Bud`	White Bud Mugo Pine	#5	48" O.C.	24" HT	LOW		
ORNAMEN	NTAL GRA	ASSES								
MANAGARA MARKET	BGB	11	Bouteloua gracilis `Blonde Ambition`	Blonde Ambition Blue Grama	1 GAL	20" O.C.		LOW		TOLERANT
ANNON ANNOTED THE PROPERTY OF	PVS	94	Panicum virgatum 'Shenandoah'	Shenandoah Switch Grass	#1	24" O.C.		LOW	FULL TO CONTAINER	TOLERANT
ANNOUNCE TO THE TOTAL OF THE TO	PAH	3	Pennisetum alopecuroides 'Hameln'	Hameln Dwarf Fountain Grass	#1	24" O.C.		LOW	FULL TO CONTAINER	
	SHP	14	Sporobolus heterolepis	Prairie Dropseed	#3	30" O.C.		LOW	FULL TO CONTAINER	TOLERANT
PERENNIA	ALS									
0	AMM	5	Achillea `Moonshine`	Moonshine Yarrow	1 GAL			LOW		TOLERANT
	CER	14	Centranthus ruber	Red Valerian	#1	18" O.C.		MODERATE	FULL TO CONTAINER	
3+4	EPP	9	Echinacea purpurea `Magnus`	Purple Coneflower	#1	18" O.C.		LOW	FULL TO CONTAINER	TOLERANT
	HCP	151	Heuchera x 'Carnival Plum Crazy'	Carnival Plum Crazy Coral Bells	#3					TOLERANT
\bigcirc	NWW	14	Nepeta x `Cat's Meow'	Cat's Meow Catmint	#1	24" O.C.		LOW	FULL TO CONTAINER	
•	PEF	6	Penstemon eatonii	Firecracker Penstemon	#1			LOW		TOLERANT
	PAR	10	Perovskia atriplicifolia 'Little Spire'	Little Spire Russian Sage	#3	24" O.C.				
lacksquare										
(+)	RFG	13	Rudbeckia fulgida 'Goldsturm'	Black-eyed Susan	#1					TOLERANT

SOD 10,251 sf SOD

1360 WALNUT STREET, SUITE 102 BOULDER CO, 80302 720.274.0814 WWW.LANDDESIGN.COM

OWNER: PARK MEADOWS MALL, LLC / PARK MEADOWS ANCHOR ACQUISITION, LLC 8401 PARK MEADOWS CENTER DRIVE LONE TREE, CO 80124

PARK MEADOWS - GARAGE AND PLAZA SITE IMPROVEMENT PLAN

8TH AMENDMENT, LOT

FILING NO.

PARK MEADOWS TOWN CENTER

DATE	REVISION COMMENTS
03-29-2024	1ST SUBMITTAL
05-10-2024	2ND SUBMITTAL
06-03-2024	3RD SUBMITTAL
PROJE	ECT #: 231016


PLANTING SCHEDULE -PHASE 1A

> Sheet Number 11 of 54

SALT TOLERANT PLANT INFORMATION LISTED PER CITY OF LONE TREE FORESTRY AND LANDSCAPING DEPARTMENT

PLANNING AREA #1 4.32 ACRES SIP #SP24-0010

8517 PARK MEADOWS CENTER DRIVE

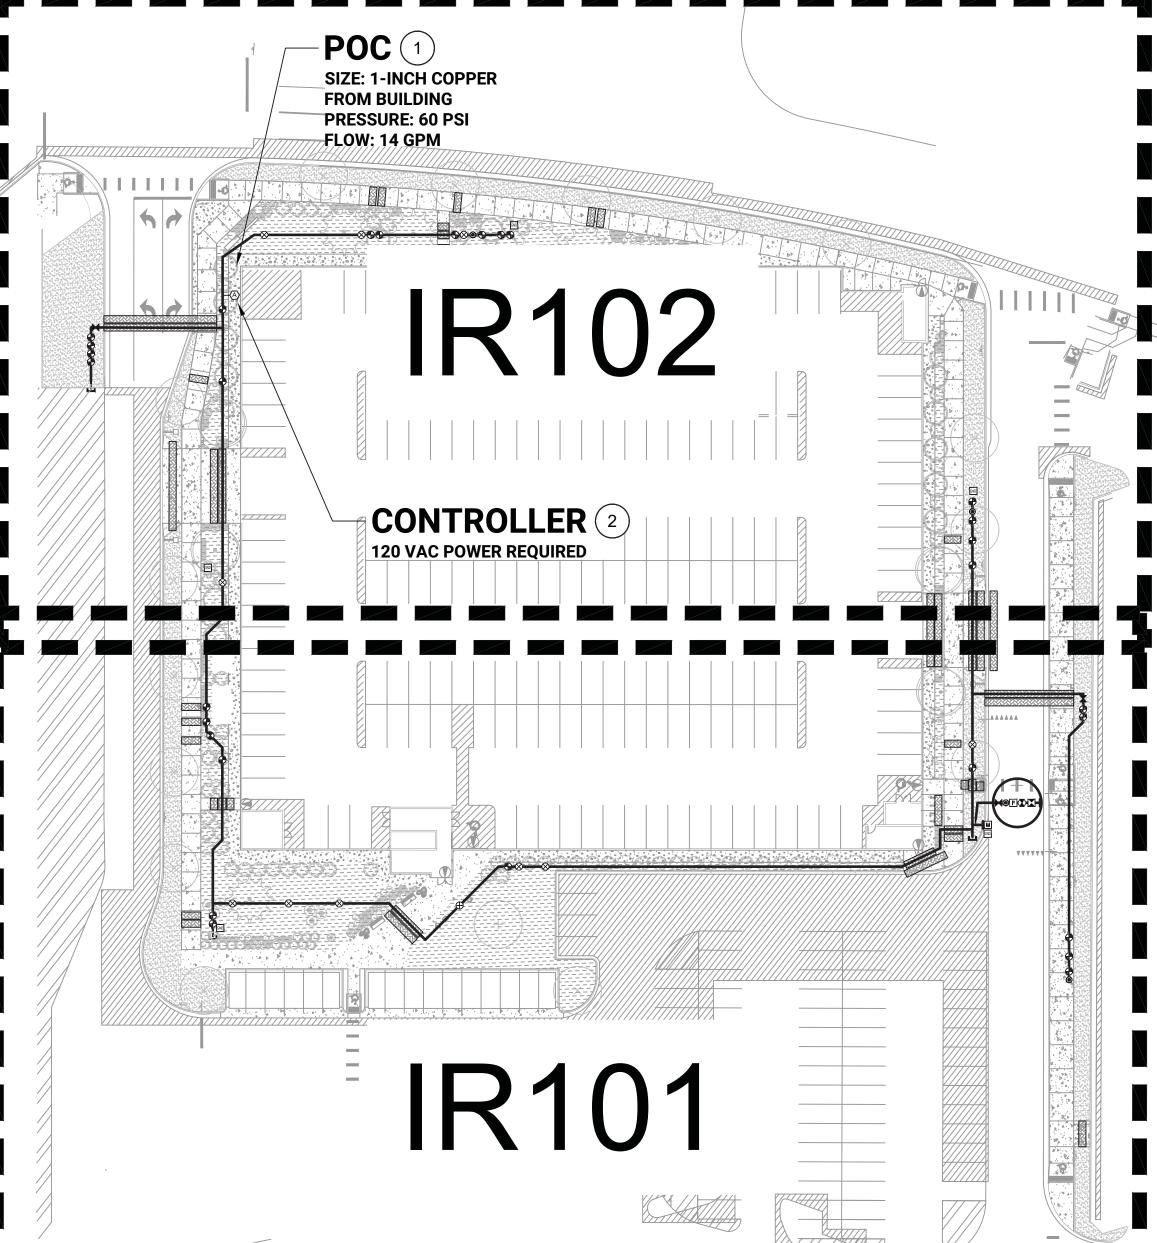

IRRIGATION NOTES

- THE IRRIGATION SYSTEM POINT-OF-CONNECTION (POC) SHALL BE DOWNSTREAM OF THE IRRIGATION WATER TAP AND METER INSTALLED BY THE UTILITY CONTRACTOR AT THE APPROXIMATE LOCATION SHOWN. IRRIGATION CONTRACTOR TO INSTALL BACKFLOW PREVENTION UNIT. VERIFY EXACT LOCATION OF POC WITH OWNER'S REPRESENTATIVE.
- 2 IRRIGATION CONTRACTOR TO WALL MOUNT THE IRRIGATION CONTROLLER AT THE APPROXIMATE LOCATION SHOWN. ELECTRICAL POWER TO THE CONTROLLER TO BE PROVIDED BY THE ELECTRICAL CONTRACTOR, TERMINATED IN A JUNCTION BOX FOR HARD-WIRE CONNECTION TO THE IRRIGATION CONTROLLER. CARE SHOULD BE TAKEN TO INSTALL THE IRRIGATION CONTROLLER IN A LOCATION THAT IS ACCESSIBLE FOR MAINTENANCE, AND SCREENED FROM VIEW EITHER BEHIND ENTRY WALLS, NEXT TO BUILDINGS, OR BEHIND PLANT MATERIAL. FINAL LOCATION TO BE APPROVED BY OWNER'S REPRESENTATIVE.
- 3 IRRIGATION CONTRACTOR TO CUT AND CAP MAINLINE FOR EXPANSION TO PHASE 1 AT FULL BUILDOUT AND COIL 3 FEET OF CONTROL WIRE IN 10-INCH ROUND VALVE BOX AT APPROXIMATE LOCATION SHOWN.
- 4 IRRIGATION SHOWN OUT OF LANDSCAPED AREA FOR CLARITY ONLY. INSTALL IRRIGATION COMPONENTS WITHIN LANDSCAPED AREA.
- MAINLINE AND VALVES A23-A29 TO BE DEMOED IN PHASE 1B. CONTRACTOR SHALL CUT AND CAP MAINLINE AT APPROXIMATE LOCATION SHOWN DURING PHASE 1B CONSTRUCTION.

IRRIGATION LEGEND

SLEEVES: CLASS 200 PVC

POINT-OF-CONNECTION ASSEMBLY

MAINLINE PIPE: CLASS 200 PVC

X-INCH SIZE UNLESS OTHERWISE INDICATED

LATERAL PIPE TO SPRINKLERS: CLASS 200 PVC

1-INCH SIZE UNLESS OTHERWISE INDICATED

---- LATERAL PIPE TO TREE EMITTERS: CLASS 315 PVC 1-INCH SIZE UNLESS OTHERWISE INDICATED

---- LATERAL PIPE TO INLINE DRIP HEADER: CLASS 200 PVC
1-INCH SIZE UNLESS OTHERWISE INDICATED

→ UNCONNECTED PIPE CROSSING

INLINE DRIP TUBING: NETAFIM TLCV6-12 WITH RAINBIRD XQF DRIPLINE HEADER

0.6 GPH EMITTERS, 12" EMITTER SPACING, 12" ROW SPACING

REMOTE CONTROL VALVE ASSEMBLY FOR SPRINKLER LATERALS: RAIN BIRD PEB (SIZED PER PLAN)

REMOTE CONTROL DRIP VALVE ASSEMBLY: RAIN BIRD XCZ-PRB-100-COM

M WATER METER AND CURB STOP ASSEMBLY: BY OTHERS

QUICK COUPLING VALVE ASSEMBLY: RAIN BIRD 5RC

ISOLATION GATE VALVE ASSEMBLY: MATCO 514

F FLOW SENSOR ASSEMBLY: RAIN BIRD FS100

BACKFLOW PREVENTION ASSEMBLY: FEBCO 825YA (1")

MASTER VALVE ASSEMBLY: RAIN BIRD PEB (1")



A IRRIGATION CONTROLLER UNIT WITH WEATHER SENSOR RAIN BIRD ESPME3

♦ WEATHER SENSOR: **RAIN BIRD WRF-48**

- c - IRRIGATION CONTROL WIRES IN CONDUIT OR WITH WARNING TAPE

GROUNDING AND SURGE ARRESTOR ASSEMBLY: RAIN BIRD LSP-1TURF

IRRIGATION MAINLINE CAP ASSEMBLY

FLOW (GPM): **Q-0.67 H-1.30 F-2.70**

FLOW (GPM): **Q-0.97 H-1.86 F-3.75**

TREE BUBBLER ASSEMBLY: TWO (2) RAIN BIRD 1402 BUBBLERS PRESSURE: 30 PSI FLOW (GPM): 0.5 PER BUBBLER; 1.0 PER ASSEMBLY

◆ ■ POP-UP SPRAY SPRINKLER: HUNTER PROS-06-PRS30-CV W/8 SERIES NOZZLEPRESSURE: 30 PSI RADIUS: 8 FEETFLOW (GPM): Q-0.24 H-0.47 F-0.97

Ø ● POP-UP SPRAY SPRINKLER: HUNTER PROS-06-PRS30-CV W/10 SERIES NOZZLE PRESSURE: 30 PSI RADIUS: 10 FEET FLOW (GPM): Q-0.42 H-0.88 F-1.59

△ ▲ POP-UP SPRAY SPRINKLER: HUNTER PROS-06-PRS30-CV W/12 SERIES NOZZLE PRESSURE: 30 PSI RADIUS: 12 FEET

● POP-UP SPRAY SPRINKLER: HUNTER PROS-06-PRS30-CV W/15 SERIES NOZZLE PRESSURE: 30 PSI RADIUS: 15 FEET

POP-UP SPRAY SPRINKLER: **HUNTER PROS-06-PRS30-CV W/ ADJUSTABLE NOZZLE** PRESSURE: **30 PSI** RADIUS: **5 FEET TO 15 FEET** FLOW (GPM): **08A-0.44 10A-0.50 12A-0.32 15A-0.47**


POP-UP SPRAY SPRINKLER: **HUNTER PROS-06-PRS30-CV W/15SS SERIES NOZZLE** PRESSURE: **30 PSI** RADIUS: **5 FEET X 15 FEET** FLOW (GPM): **ES515-0.65 SS530-1.30**

INSTALLATION GENERAL NOTES

- 1. THE SYSTEM DESIGN ASSUMES A MINIMUM DYNAMIC PRESSURE FOR THE IRRIGATION SYSTEM OF 60 PSI, AT A DESIGN FLOW OF 14 GPM AT THE 1-INCH IRRIGATION POINT-OF-CONNECTION (POC). TAP, METER, BACKFLOW PREVENTER, MASTER VALVE AND FLOW METER SHALL BE SIZED AS INDICATED IN THE DRAWING LEGEND. VERIFY PRESSURE AND FLOW ON SITE PRIOR TO CONSTRUCTION.
- 2. READ THOROUGHLY AND BECOME FAMILIAR WITH THE SPECIFICATIONS AND INSTALLATION DETAILS FOR THIS AND RELATED WORK PRIOR TO CONSTRUCTION.
- 3. COORDINATE UTILITY LOCATES ("CALL BEFORE YOU DIG") OF UNDERGROUND UTILITIES PRIOR TO CONSTRUCTION.
- 4. DO NOT PROCEED WITH THE INSTALLATION OF THE IRRIGATION SYSTEM WHEN IT IS OBVIOUS IN THE FIELD THAT OBSTRUCTIONS OR GRADE DIFFERENCES EXIST THAT MIGHT NOT HAVE BEEN CONSIDERED IN THE ENGINEERING. IF DISCREPANCIES IN CONSTRUCTION DETAILS, LEGEND, NOTES, OR SPECIFICATIONS ARE DISCOVERED, BRING ALL SUCH OBSTRUCTIONS OR DISCREPANCIES TO THE ATTENTION OF THE OWNER'S REPRESENTATIVE.
- 5. THE DRAWINGS ARE DIAGRAMMATIC. THEREFORE, THE FOLLOWING SHOULD BE NOTED:
- A. ALTHOUGH IRRIGATION COMPONENTS MAY BE SHOWN OUTSIDE PLANTING AREAS FOR CLARITY, INSTALL IRRIGATION PIPE AND WIRING IN LANDSCAPED AREAS WHENEVER POSSIBLE.
- B. TREE AND SHRUB LOCATIONS AS SHOWN ON LANDSCAPE PLANS TAKE PRECEDENCE OVER IRRIGATION EQUIPMENT LOCATIONS. AVOID CONFLICTS BETWEEN THE IRRIGATION SYSTEM, PLANTING MATERIALS, AND ARCHITECTURAL FEATURES.
- C. USE ONLY STANDARD TEES AND ELBOW FITTINGS. USE OF TEES IN THE BULLNOSE CONFIGURATION, OR USE OF CROSS TYPE FITTINGS IS NOT ALLOWED.

- 6. PROVIDE THE FOLLOWING COMPONENTS TO THE OWNER PRIOR TO THE COMPLETION OF THE PROJECT:
- A. TWO (2) OPERATING KEYS FOR EACH TYPE OF MANUALLY OPERATED VALVES.
- B. TWO (2) OF EACH SERVICING WRENCH OR TOOL NEEDED FOR COMPLETE ACCESS, ADJUSTMENT, AND REPAIR OF ALL ROTARY SPRINKLERS.
- 7. SELECT NOZZLES FOR SPRAY AND ROTARY SPRINKLERS WITH ARCS WHICH PROVIDE COMPLETE AND ADEQUATE COVERAGE WITH MINIMUM OVERSPRAY FOR THE SITE CONDITIONS. CAREFULLY ADJUST THE RADIUS OF THROW AND ARC OF COVERAGE OF EACH ROTARY SPRINKLER TO PROVIDE THE BEST PERFORMANCE.
- 8. THE IRRIGATION CONTRACTOR IS RESPONSIBLE FOR THE INSTALLATION OF IRRIGATION SLEEVING. SLEEVES ARE REQUIRED FOR BOTH PIPING AND ELECTRICAL WIRING AT EACH HARDSCAPE CROSSING. COORDINATE INSTALLATION OF SLEEVING WITH OTHER TRADES. ANY PIPE OR WIRE WHICH PASSES BENEATH EXISTING HARDSCAPE WHERE SLEEVING WAS NOT INSTALLED WILL REQUIRE HORIZONTAL BORING BY THE IRRIGATION CONTRACTOR. PIPE SLEEVES SHALL BE SIZED TWICE THE NOMINAL SIZE OF THE PIPE PASSING THROUGH.
- 9. INSTALL ALL ELECTRICAL POWER TO THE IRRIGATION CONTROL SYSTEM IN ACCORDANCE WITH THE NATIONAL ELECTRIC CODE AND ALL APPLICABLE LOCAL ELECTRIC UTILITY CODES.
- 10. THE FOLLOWING SHOULD BE NOTED REGARDING PIPE SIZING: IF A SECTION OF UNSIZED PIPE IS LOCATED BETWEEN TWO IDENTICALLY SIZED SECTIONS, THE UNSIZED PIPE IS THE SAME NOMINAL SIZE AS THE TWO SIZED SECTIONS. THE UNSIZED PIPE SHOULD NOT BE CONFUSED WITH THE DEFAULT PIPE SIZE NOTED IN THE LEGEND.
- 11. INSTALL ONE (1) #14 AWG TWO-WIRE PAIR ON TWO-WIRE SYSTEMS, FOR USE AS SPARES. INSTALL SPARE WIRES FROM CONTROLLER LOCATION TO EACH DEAD-END OF MAINLINE. COIL 3 FEET OF WIRE IN VALVE BOX.
- 12. IRRIGATION CONTRACTOR TO INSTALL PAIGE DECODER CABLE FUSE DEVICES (DCFD), AT ALL DECODER CABLE DIRECTIONAL SPLITS AND/OR CHANGES. INSTALL ALL SPLICES WITHIN A 10" VALVE BOX.



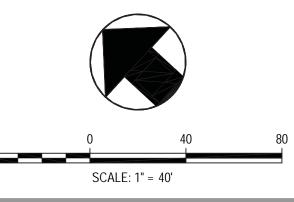



1120 Lincoln Street, Suite 1000 Denver, Colorado 80203 P: 303.623.6300 F: 303.623.6311 HarrisKocherSmith.com

OWNER:
PARK MEADOWS MALL, LLC / PARK
MEADOWS ANCHOR ACQUISITION, LLC
8401 PARK MEADOWS CENTER DRIVE

LONE TREE, CO 80124

TOWN CENTER FILING NO. 1-A, 8TH AMENDMENT PARK MEADOWS - GARAGE AND PLAZA

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DATE REVISION COMMENTS
03-29-2024 1ST SUBMITTAL

 05-10-2024
 2ND SUBMITTAL

 06-03-2024
 3RD SUBMITTAL

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PROJECT #: 231016


IR100 - IRRIGATION NOTES & LEGENDS PHASE 1A

SHEET NUMBER

12 of 54

4.32 ACRES SIP #SP24-0010

8517 PARK MEADOWS CENTER DRIVE

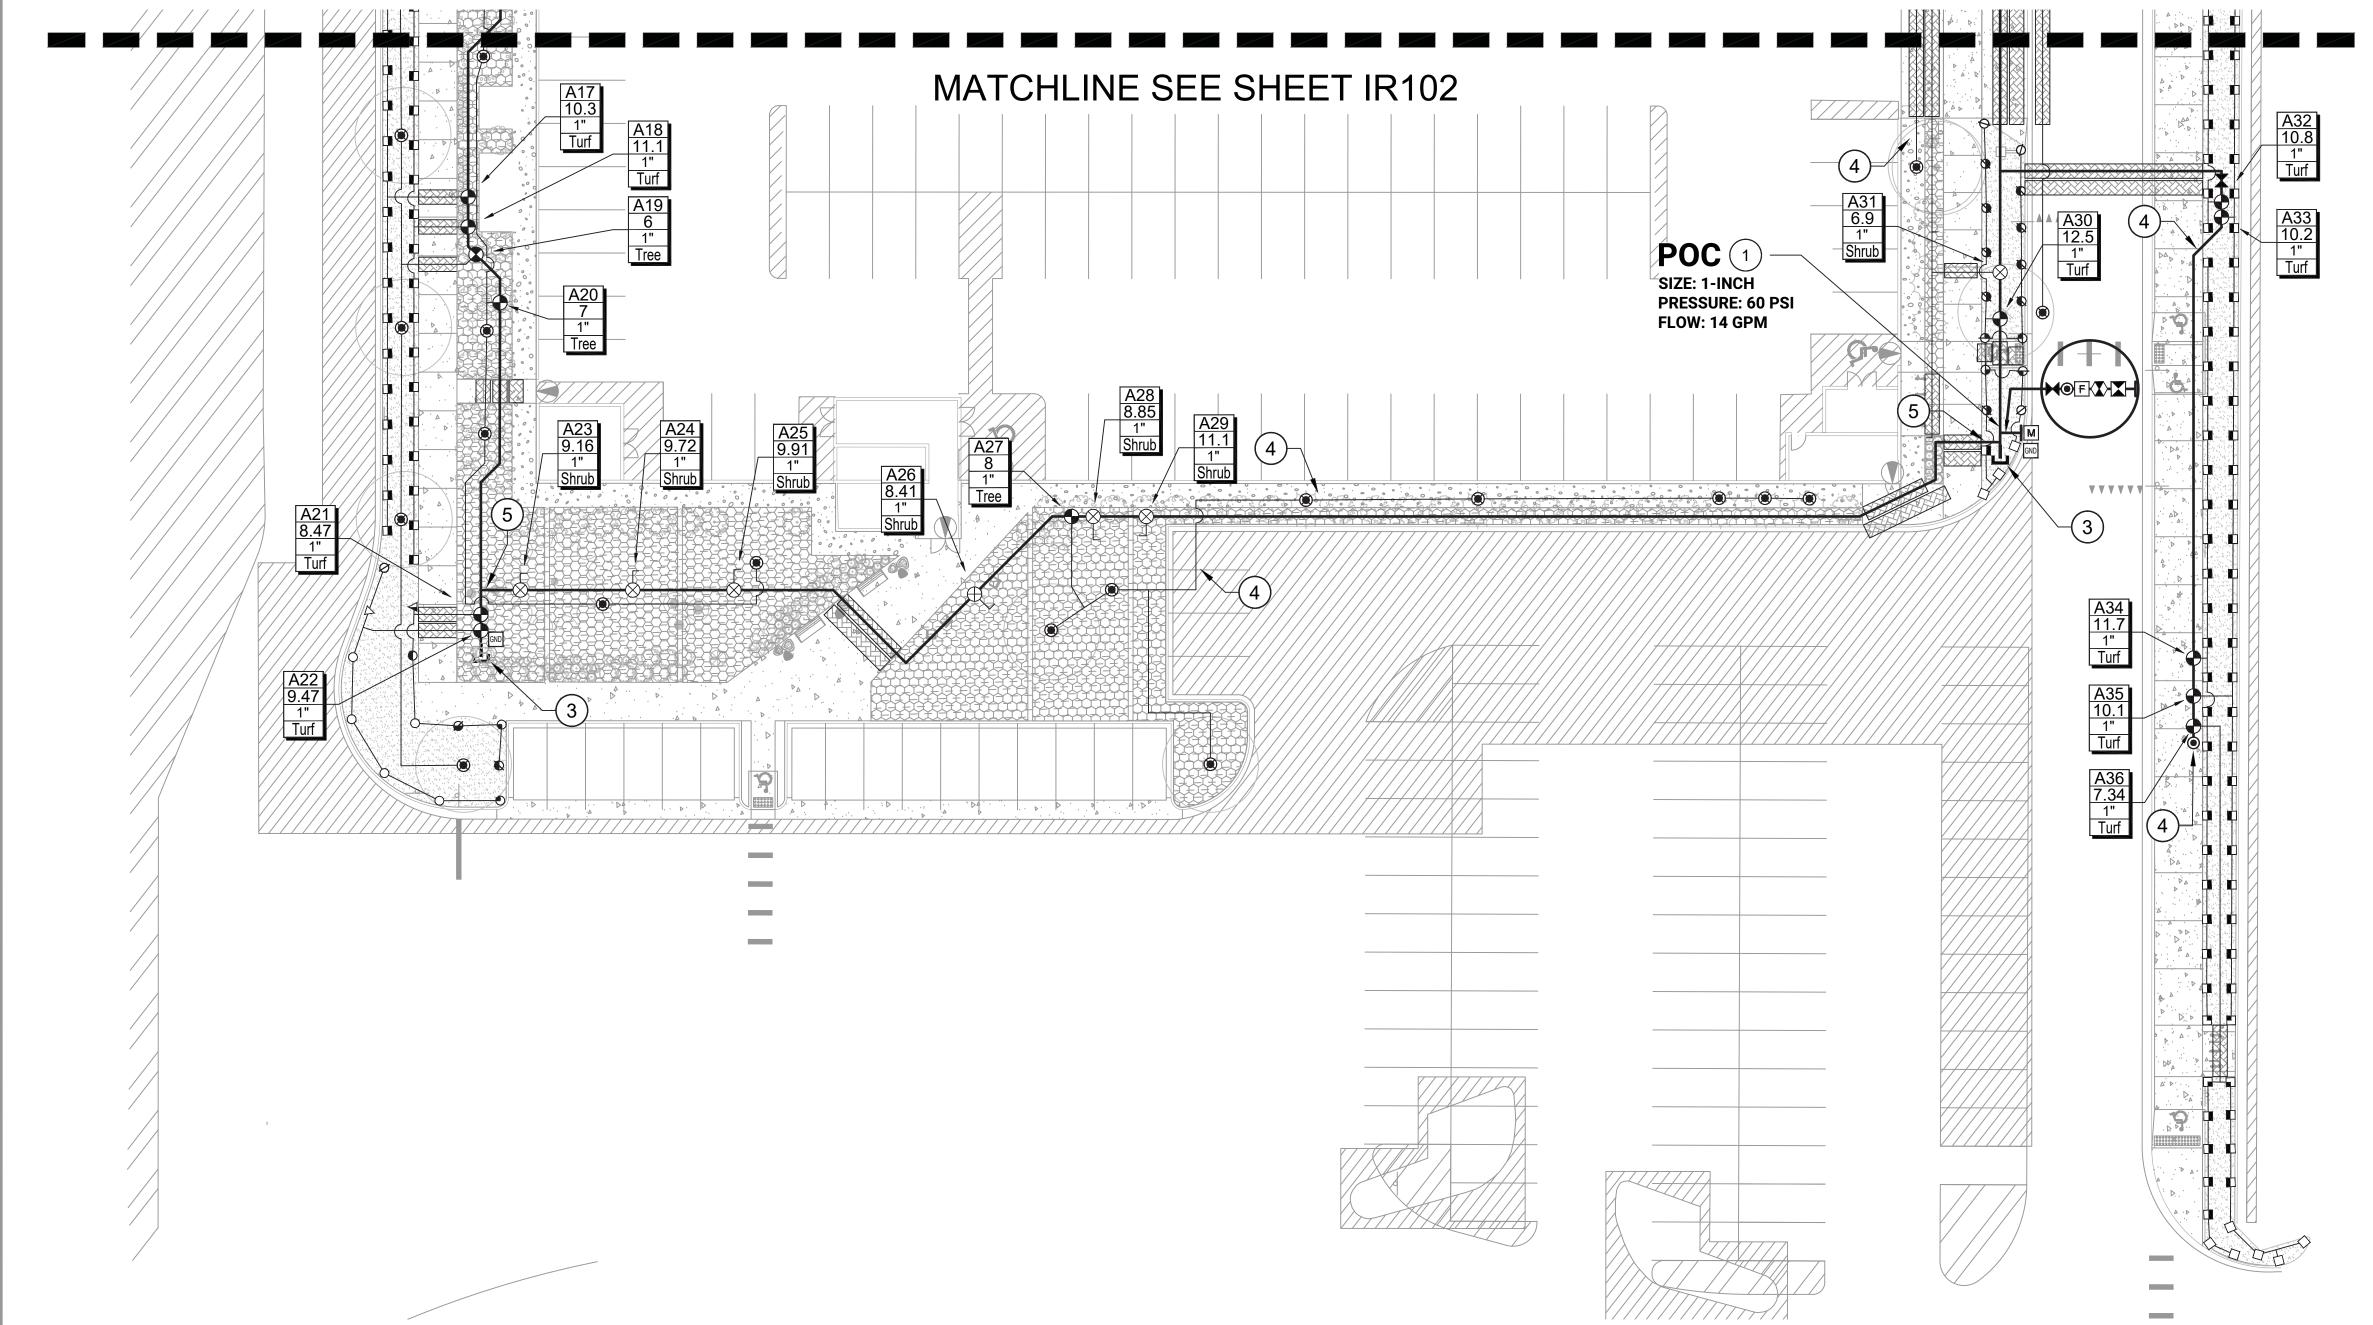



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OWNER: PARK MEADOWS MALL, LLC / PARK MEADOWS ANCHOR ACQUISITION, LLC 8401 PARK MEADOWS CENTER DRIVE

LONE TREE, CO 80124

IRRIGATION NOTES

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LOT

8TH AMENDMENT,

FILING NO.

TOWN CENTER

PARK MEADOWS

DATE | REVISION COMMENTS


03-29-2024 | 1ST SUBMITTAL 05-10-2024 | 2ND SUBMITTAL 06-03-2024 3RD SUBMITTAL

PROJECT #: 231016

IR101 - IRRIGATION PLAN PHASE 1A

SHEET NUMBER



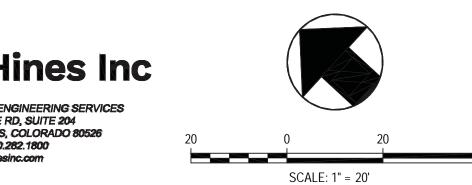

4.32 ACRES SIP #SP24-0010

8517 PARK MEADOWS CENTER DRIVE



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OWNER:

PARK MEADOWS MALL, LLC / PARK MEADOWS ANCHOR ACQUISITION, LLC 8401 PARK MEADOWS CENTER DRIVE LONE TREE, CO 80124

8TH AMENDMENT, FILING NO. PARK MEADOWS TOWN CENTER

LOT


DATE REVISION COMMENTS 03-29-2024 1ST SUBMITTAL

PROJECT #: 231016

05-10-2024 | 2ND SUBMITTAL 06-03-2024 3RD SUBMITTAL

> IR102 - IRRIGATION PLAN PHASE 1A


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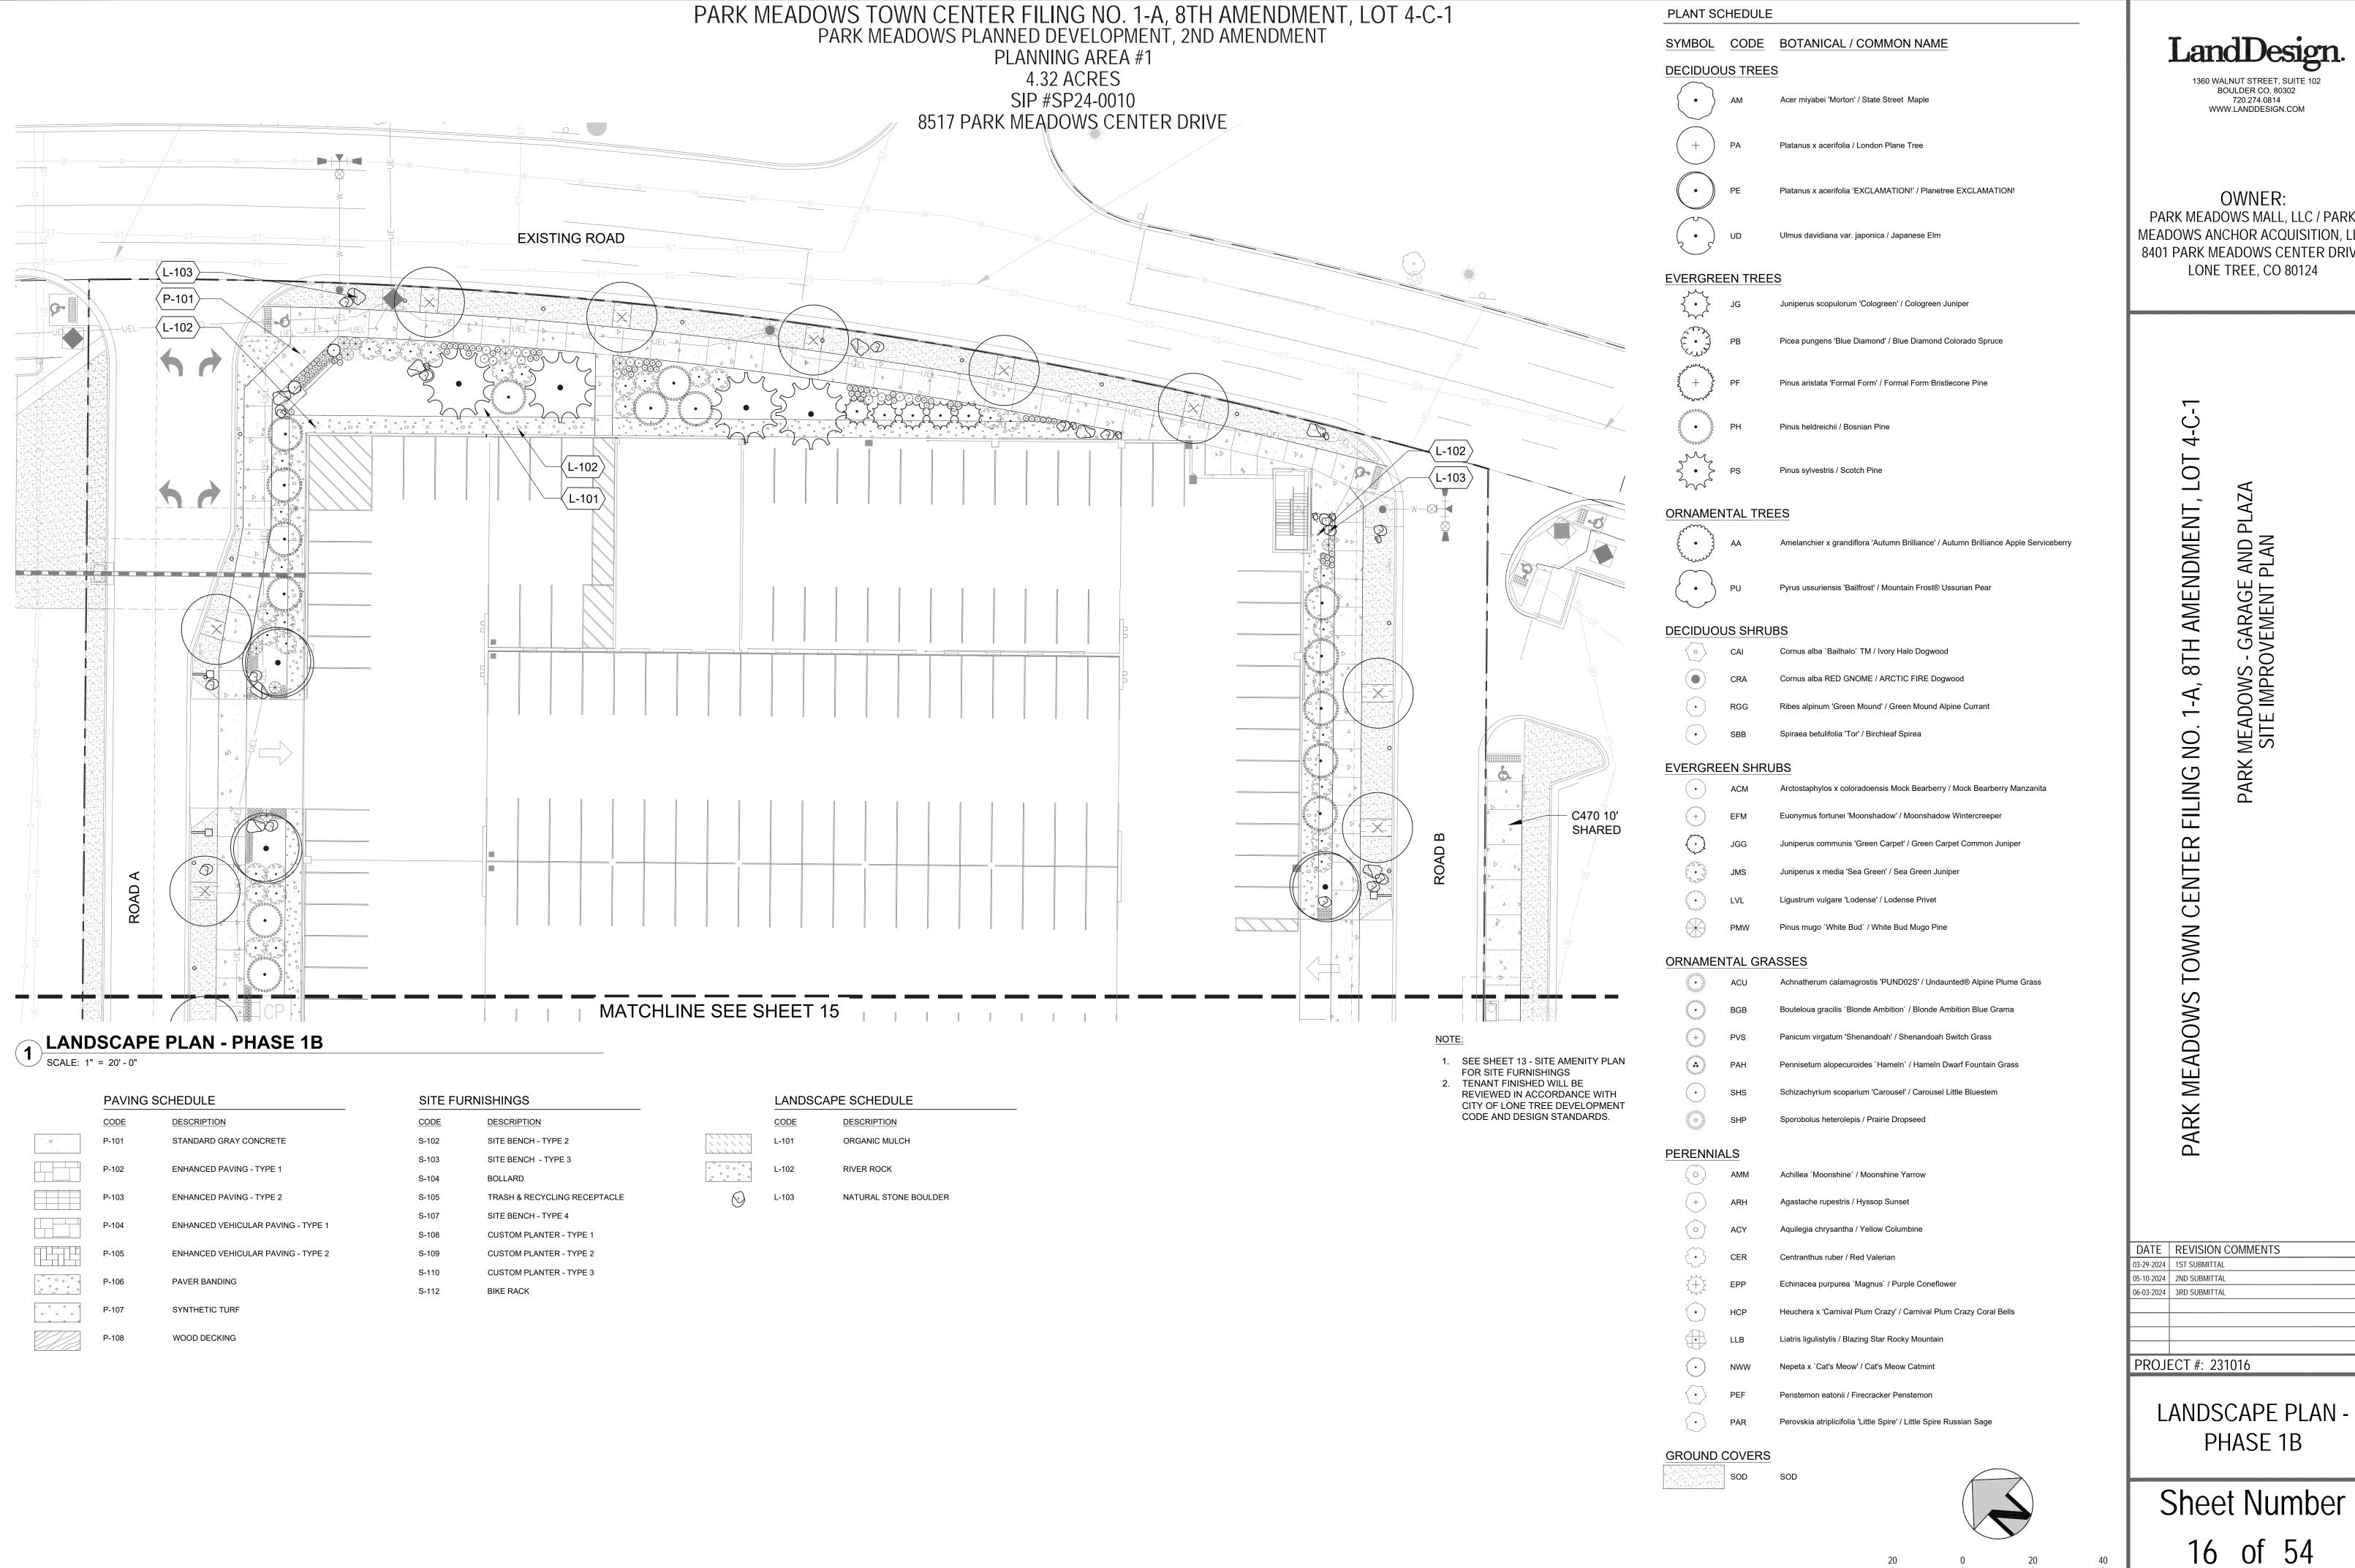

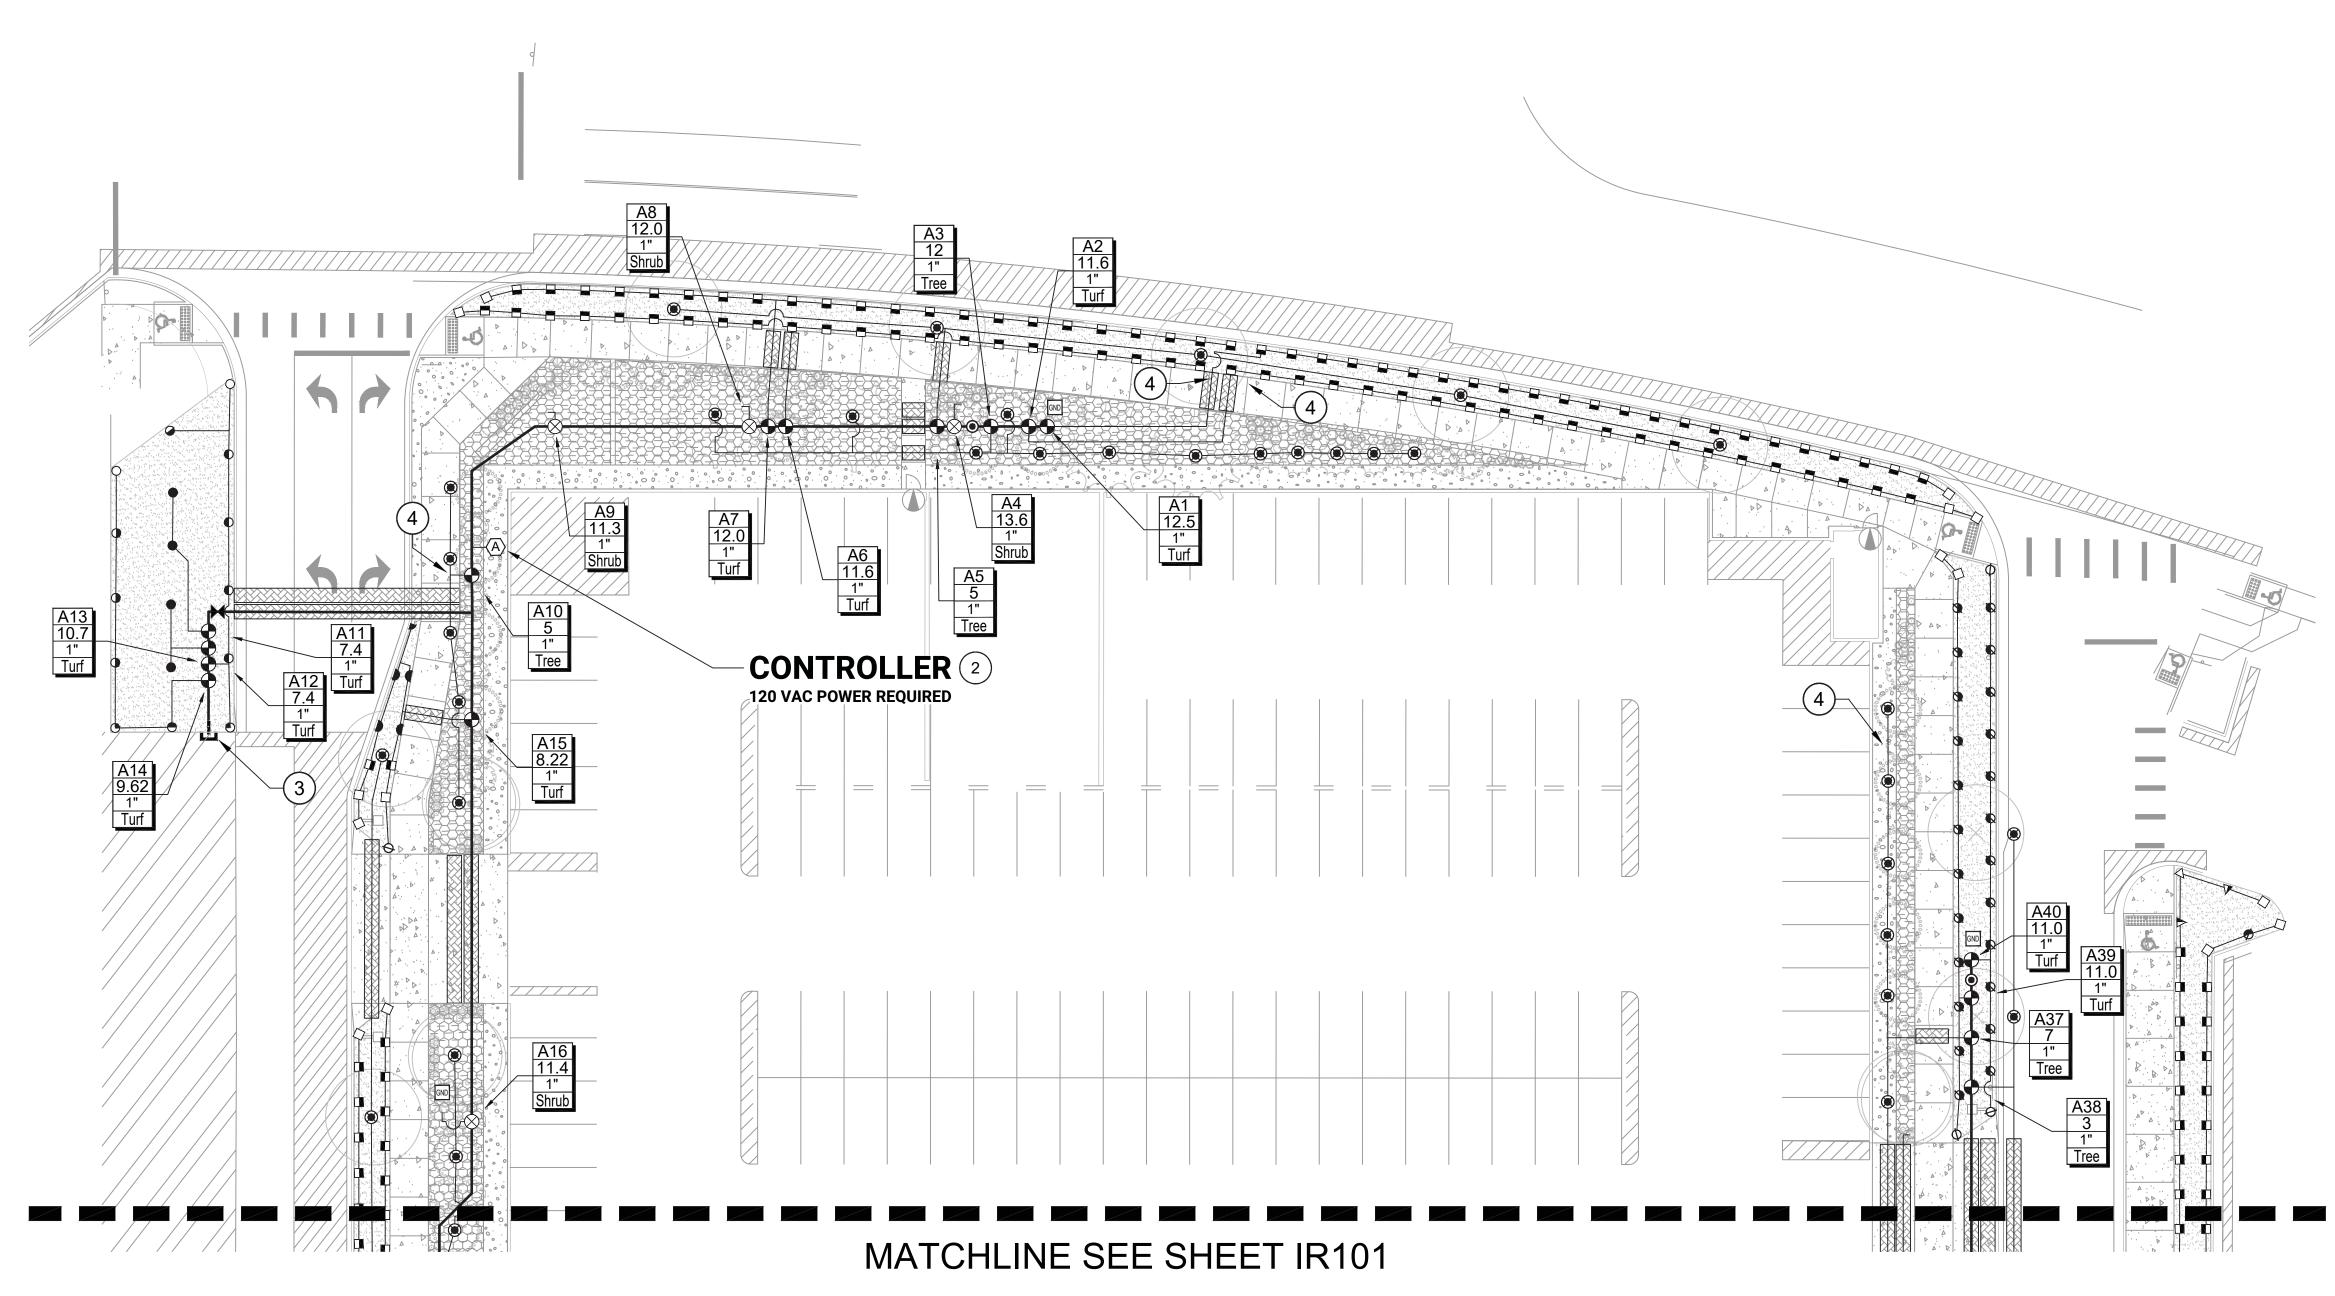
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Hines Inc SITE WATER ENGINEERING SERVICES 323 W. DRAKE RD, SUITE 204 FORT COLLINS, COLORADO 80526 Telephone: 970.282.1800 SCALE: 1" = 20'





PARK MEADOWS MALL, LLC / PARK MEADOWS ANCHOR ACQUISITION, LLC 8401 PARK MEADOWS CENTER DRIVE

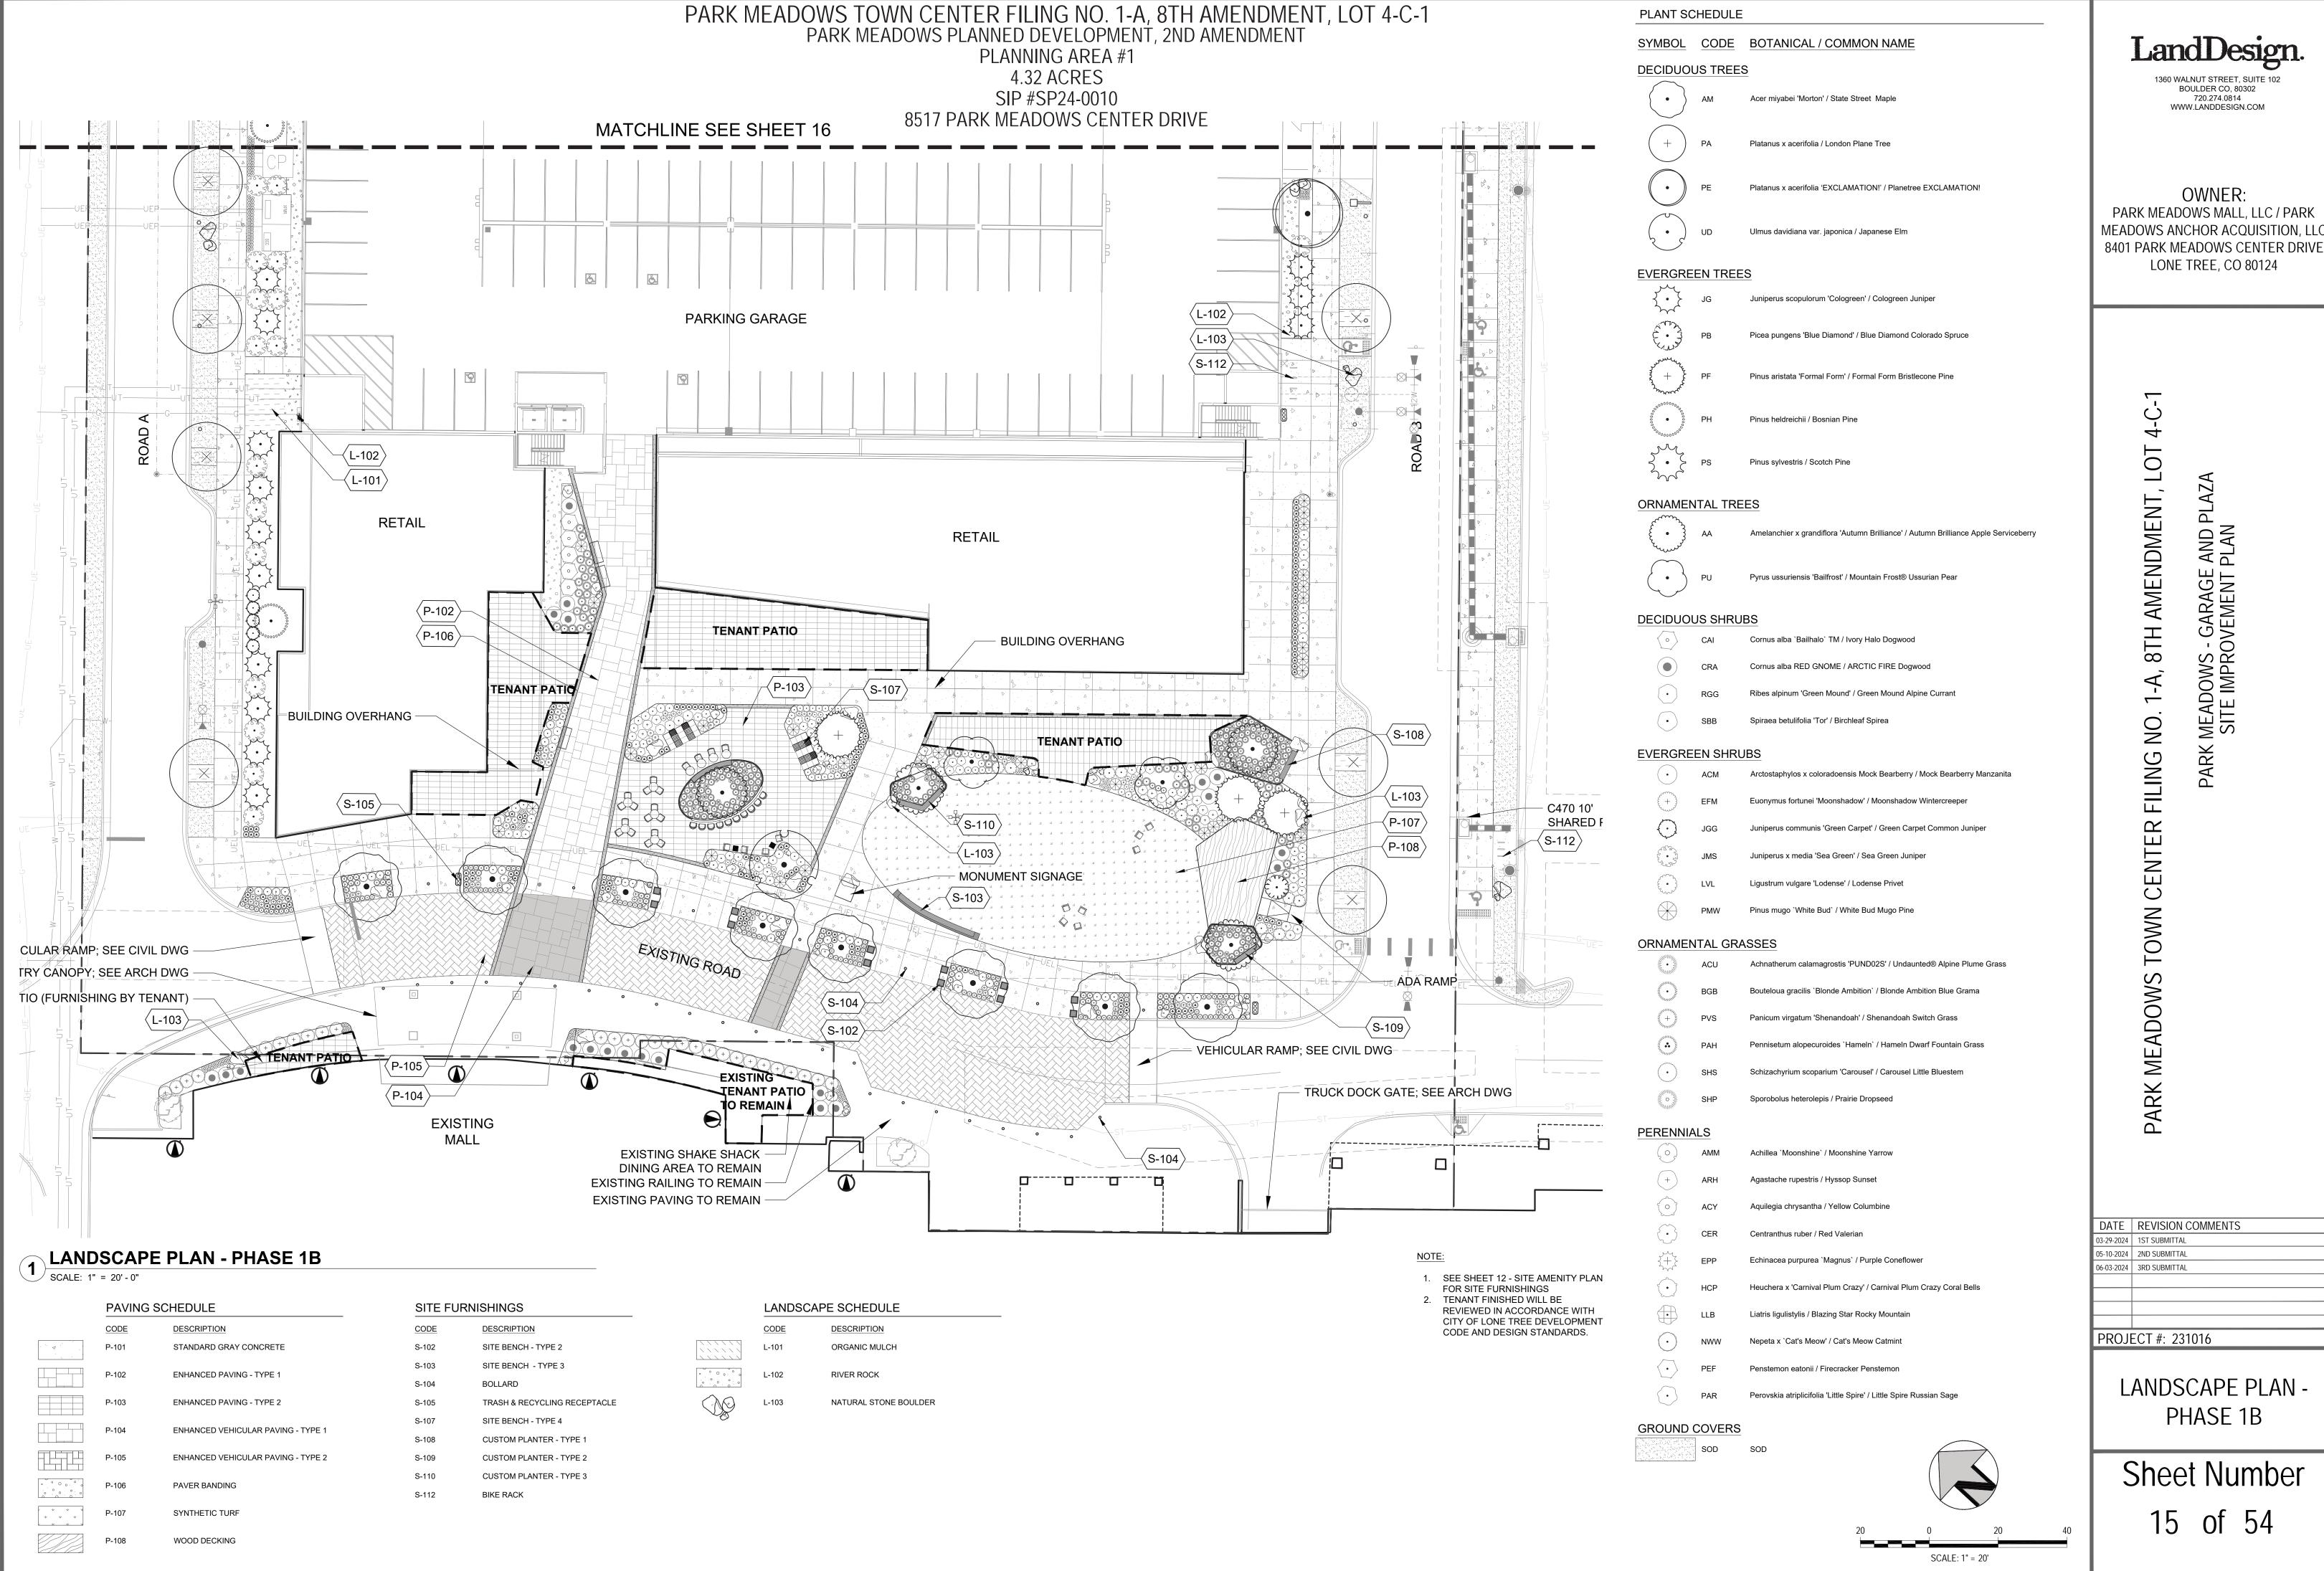SCALE: 1" = 20'

PARK MEADOWS TOWN CENTER FILING NO. 1-A, 8TH AMENDMENT, LOT 4-C-1 PARK MEADOWS PLANNED DEVELOPMENT, 2ND AMENDMENT

PLANNING AREA #1 4.32 ACRES SIP #SP24-0010

SALT TOLERANCE*

TOLERANT

SENSITIVE

SENSITIVE

8517 PARK MEADOWS CENTER DRIVE

BGB

SHS

CER

PAR

SOD

GROUND COVERS

PERENNIALS

 $\langle \cdot \rangle$

Achnatherum calamagrostis 'PUND02S'

Bouteloua gracilis 'Blonde Ambition'

Panicum virgatum 'Shenandoah'

Pennisetum alopecuroides 'Hameln'

Schizachyrium scoparium 'Carousel'

Achillea 'Moonshine'

Agastache rupestris

Aquilegia chrysantha

Echinacea purpurea 'Magnus'

Heuchera x 'Carnival Plum Crazy'

Perovskia atriplicifolia 'Little Spire'

BOTANICAL NAME

12,363 sf SOD

Centranthus ruber

Liatris ligulistylis

Nepeta x `Cat's Meow'

Undaunted® Alpine Plume Grass

Blonde Ambition Blue Grama

Shenandoah Switch Grass

Hameln Dwarf Fountain Grass

Carousel Little Bluestem

Prairie Dropseed

Moonshine Yarrow

Hyssop Sunset

Yellow Columbine

Purple Coneflower

Cat's Meow Catmint

Firecracker Penstemon

Little Spire Russian Sage

COMMON NAME

Carnival Plum Crazy Coral Bells

Blazing Star Rocky Mountain

Red Valerian

20" O.C.

18" O.C.

24" O.C.

24" O.C.

PLANT SC	HEDULE								8517 PAI
SYMBOL	CODE	QTY	BOTANICAL NAME	COMMON NAME	CONT.	SIZE	SPEC SIZE	WATER USE	REMARKS
DECIDUOL	JS TREES	<u>S</u>							
	AM	8	Acer miyabei 'Morton'	State Street Maple	B&B	2" CAL.	14` - 16` HT	MODERATE	
+	PA	16	Platanus x acerifolia	London Plane Tree	B&B	2" CAL	12` - 14` HT	MODERATE	STRONG CENTRAL LEADER
	PE	4	Platanus x acerifolia 'EXCLAMATION!'	Planetree EXCLAMATION!	B&B	2" CAL	12` - 14` HT	MODERATE	STRONG CENTRAL LEADER
	UD	1	Ulmus davidiana var. japonica	Japanese Elm	B&B	2.5" CAL	12` - 14` HT	MODERATE	SPECIMEN QUALITY
EVERGRE	EN TREE	S							
**	JG	18	Juniperus scopulorum 'Cologreen'	Cologreen Juniper	B&B	8` HT MIN.		VERY LOW	FULL TO GROUND
Ema	РВ	1	Picea pungens 'Blue Diamond'	Blue Diamond Colorado Spruce	B&B	8' HT MIN.		MODERATE	FULL TO GROUND
30 + F	PF	3	Pinus aristata 'Formal Form'	Formal Form Bristlecone Pine	B&B	6` HT MIN.		LOW	FULL TO GROUND
	PH	16	Pinus heldreichii	Bosnian Pine	B&B	8` HT MIN.		LOW	FULL TO GROUND
	PS	4	Pinus sylvestris	Scotch Pine	B&B	9' - 10' MIN		MODERATE TO LOW	SPECIMEN QUALITY
ORNAMEN	ITAL TRE	ES							
£ • 33	AA	4	Amelanchier x grandiflora 'Autumn Brilliance'	Autumn Brilliance Apple Serviceberry	B&B	3" CAL		LOW	MULTI-STEM, 3-5 STEMS
	PU	2	Pyrus ussuriensis 'Bailfrost'	Mountain Frost® Ussurian Pear	B&B	2.5" CAL		LOW	
SYMBOL	CODE	QTY	BOTANICAL NAME	COMMON NAME	CONT	SPACING	SPEC SIZE	WUCOLS	REMARKS
DECIDUOL	JS SHRUI	BS							
(°)	CAI	5	Cornus alba `Bailhalo` TM	Ivory Halo Dogwood	#5	42" O.C.		MODERATE	
	CRA	21	Cornus alba RED GNOME	ARCTIC FIRE Dogwood	#5	42" O.C.		MODERATE	
	RGG	12	Ribes alpinum 'Green Mound'	Green Mound Alpine Currant	#5	24" O.C.	18" - 24" HT	LOW	
•	SBB	18	Spiraea betulifolia 'Tor'	Birchleaf Spirea	#5				
EVERGRE									
•	ACM	35	Arctostaphylos x coloradoensis Mock Bearberry		#5	30" O.C.	10" - 15" HT	LOW	
£(+)3	EFM	29	Euonymus fortunei 'Moonshadow'	Moonshadow Wintercreeper	#5	42" O.C.			
	JGG	7	Juniperus communis 'Green Carpet'	Green Carpet Common Juniper	#5	36" O.C.		LOW	
2. 2. 2. 2. 2. 2. 2. 2. 2. 2. 2. 2. 2. 2	JMS	49	Juniperus x media 'Sea Green'	Sea Green Juniper	#5	42" O.C.	24" HT	LOW	
Exercise Services	LVL	12	Ligustrum vulgare 'Lodense'	Lodense Privet	#5	36" O.C.	24" HT		
	PMW	38	Pinus mugo `White Bud`	White Bud Mugo Pine	#5	48" O.C.	24" HT	LOW	

LandDesign.

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OWNER:
PARK MEADOWS MALL, LLC / PARK
MEADOWS ANCHOR ACQUISITION, LLC
8401 PARK MEADOWS CENTER DRIVE
LONE TREE, CO 80124

DATE	REVISION COMMENTS			
03-29-2024	1ST SUBMITTAL			
05-10-2024	2ND SUBMITTAL			
06-03-2024	3RD SUBMITTAL			
PROJECT #: 231016				

PLANTING SCHEDULE -PHASE 1B

> Sheet Number 17 of 54

NOTE:

 SALT TOLERANT PLANT INFORMATION LISTED PER CITY OF LONE TREE FORESTRY AND LANDSCAPING DEPARTMENT

FULL TO CONTAINER

REMARKS

LOW

LOW

LOW

LOW

LOW

LOW

MODERATE


MODERATE

LOW

LOW

LOW


TOLERANT

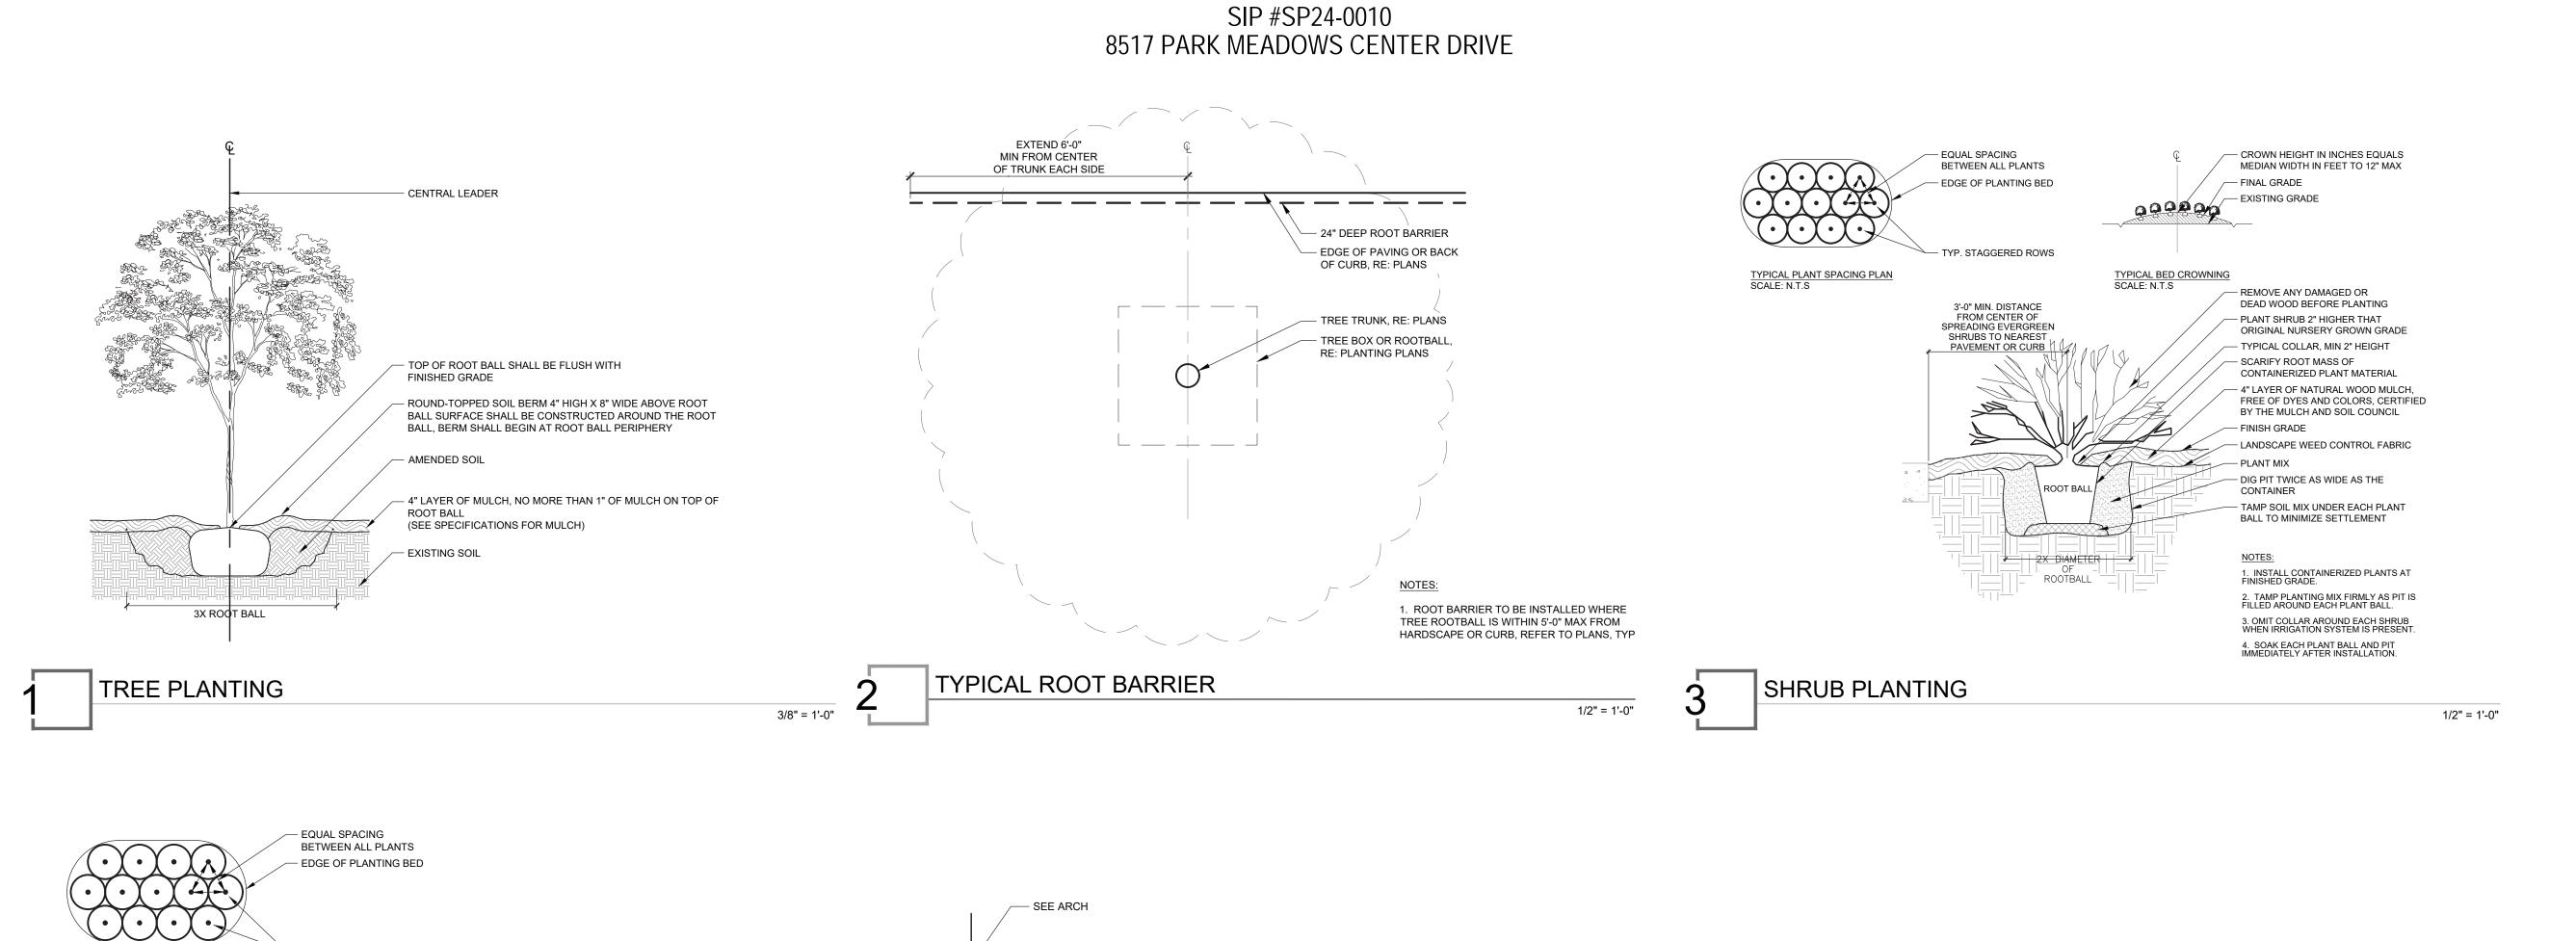

PARK MEADOWS TOWN CENTER FILING NO. 1-A, 8TH AMENDMENT, LOT 4-C-1 PARK MEADOWS PLANNED DEVELOPMENT, 2ND AMENDMENT

PLANNING AREA #1

4.32 ACRES

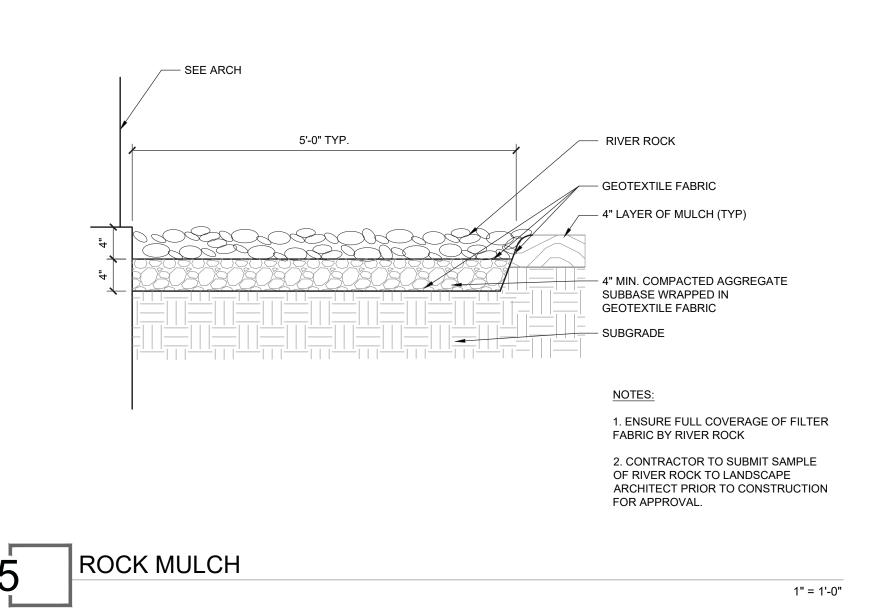

TYP. STAGGERED ROWS

ORIGINAL NURSERY GROWN GRADE

- SCARIFY ROOT MASS OF CONTAINERIZED

— 4" LAYER OF NATURAL WOOD MULCH, FREE OF DYES AND COLORS, CERTIFIED BY THE MULCH AND SOIL COUNCIL

1. INSTALL CONTAINERIZED PLANTS AT FINISHED GRADE.

2. SOAK EACH PLANT BALL AND PIT IMMEDIATELY AFTER INSTALLATION.

— LANDSCAPE WEED CONTROL FABRIC

PLANT MATERIAL

TYPICAL PLANT SPACING PLAN

GROUND COVER PLANTING

LandDesign.

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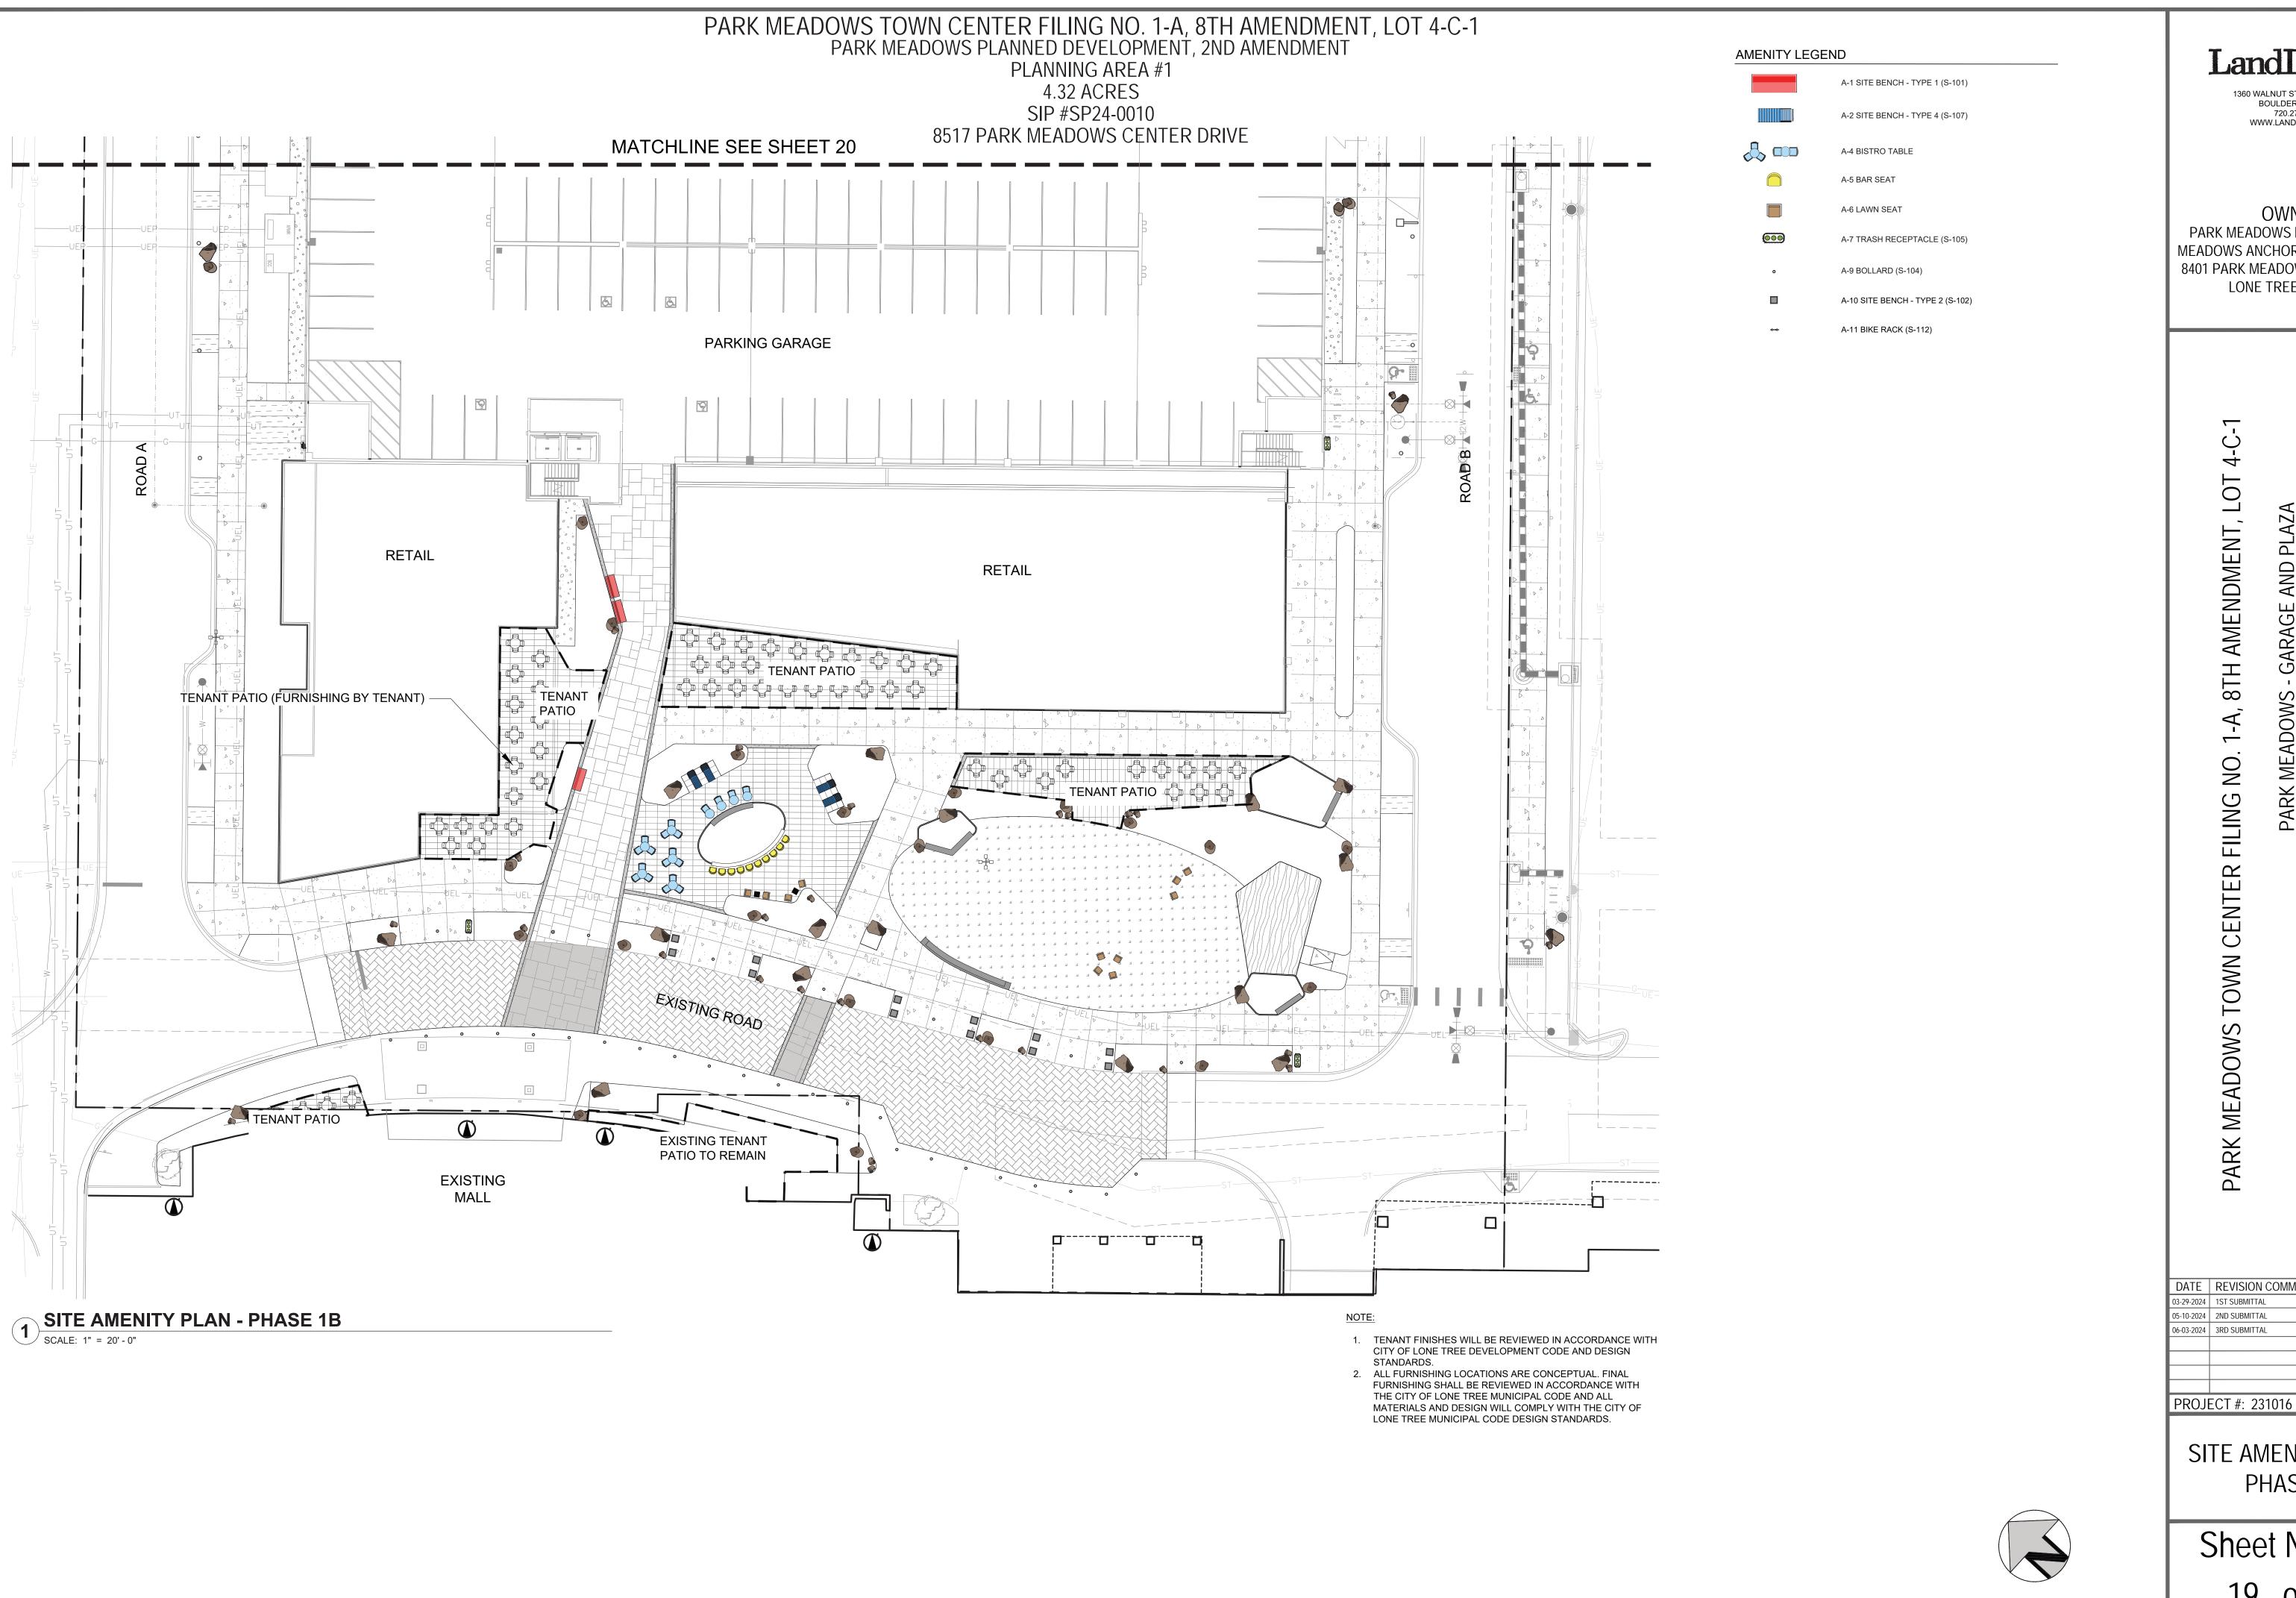
OWNER:
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MEADOWS ANCHOR ACQUISITION, LLC
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LONE TREE, CO 80124

PARK MEADOWS TOWN CENTER FILING NO. 1-A, 8TH AMENDMENT, LOT 4-C
PARK MEADOWS - GARAGE AND PLAZA
SITE IMPROVEMENT PLAN

DATE	REVISION COMMENTS
03-29-2024	1ST SUBMITTAL
05-10-2024	2ND SUBMITTAL
06-03-2024	3RD SUBMITTAL
PROJI	ECT #: 231016

PLANTING DETAILS

Sheet Number 18 of 54



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MEADOWS - GARAGE AND PLAZ SITE IMPROVEMENT PLAN

LOT

8TH AMENDMENT,

NO.

FILING

CENTER

TOWN


PARK MEADOWS

DATE	REVISION COMMENTS
03-29-2024	1ST SUBMITTAL
05-10-2024	2ND SUBMITTAL
06-03-2024	3RD SUBMITTAL

SITE AMENITY PLAN -PHASE 1B

Sheet Number 19 of 54

SCALE: 1" = 20'

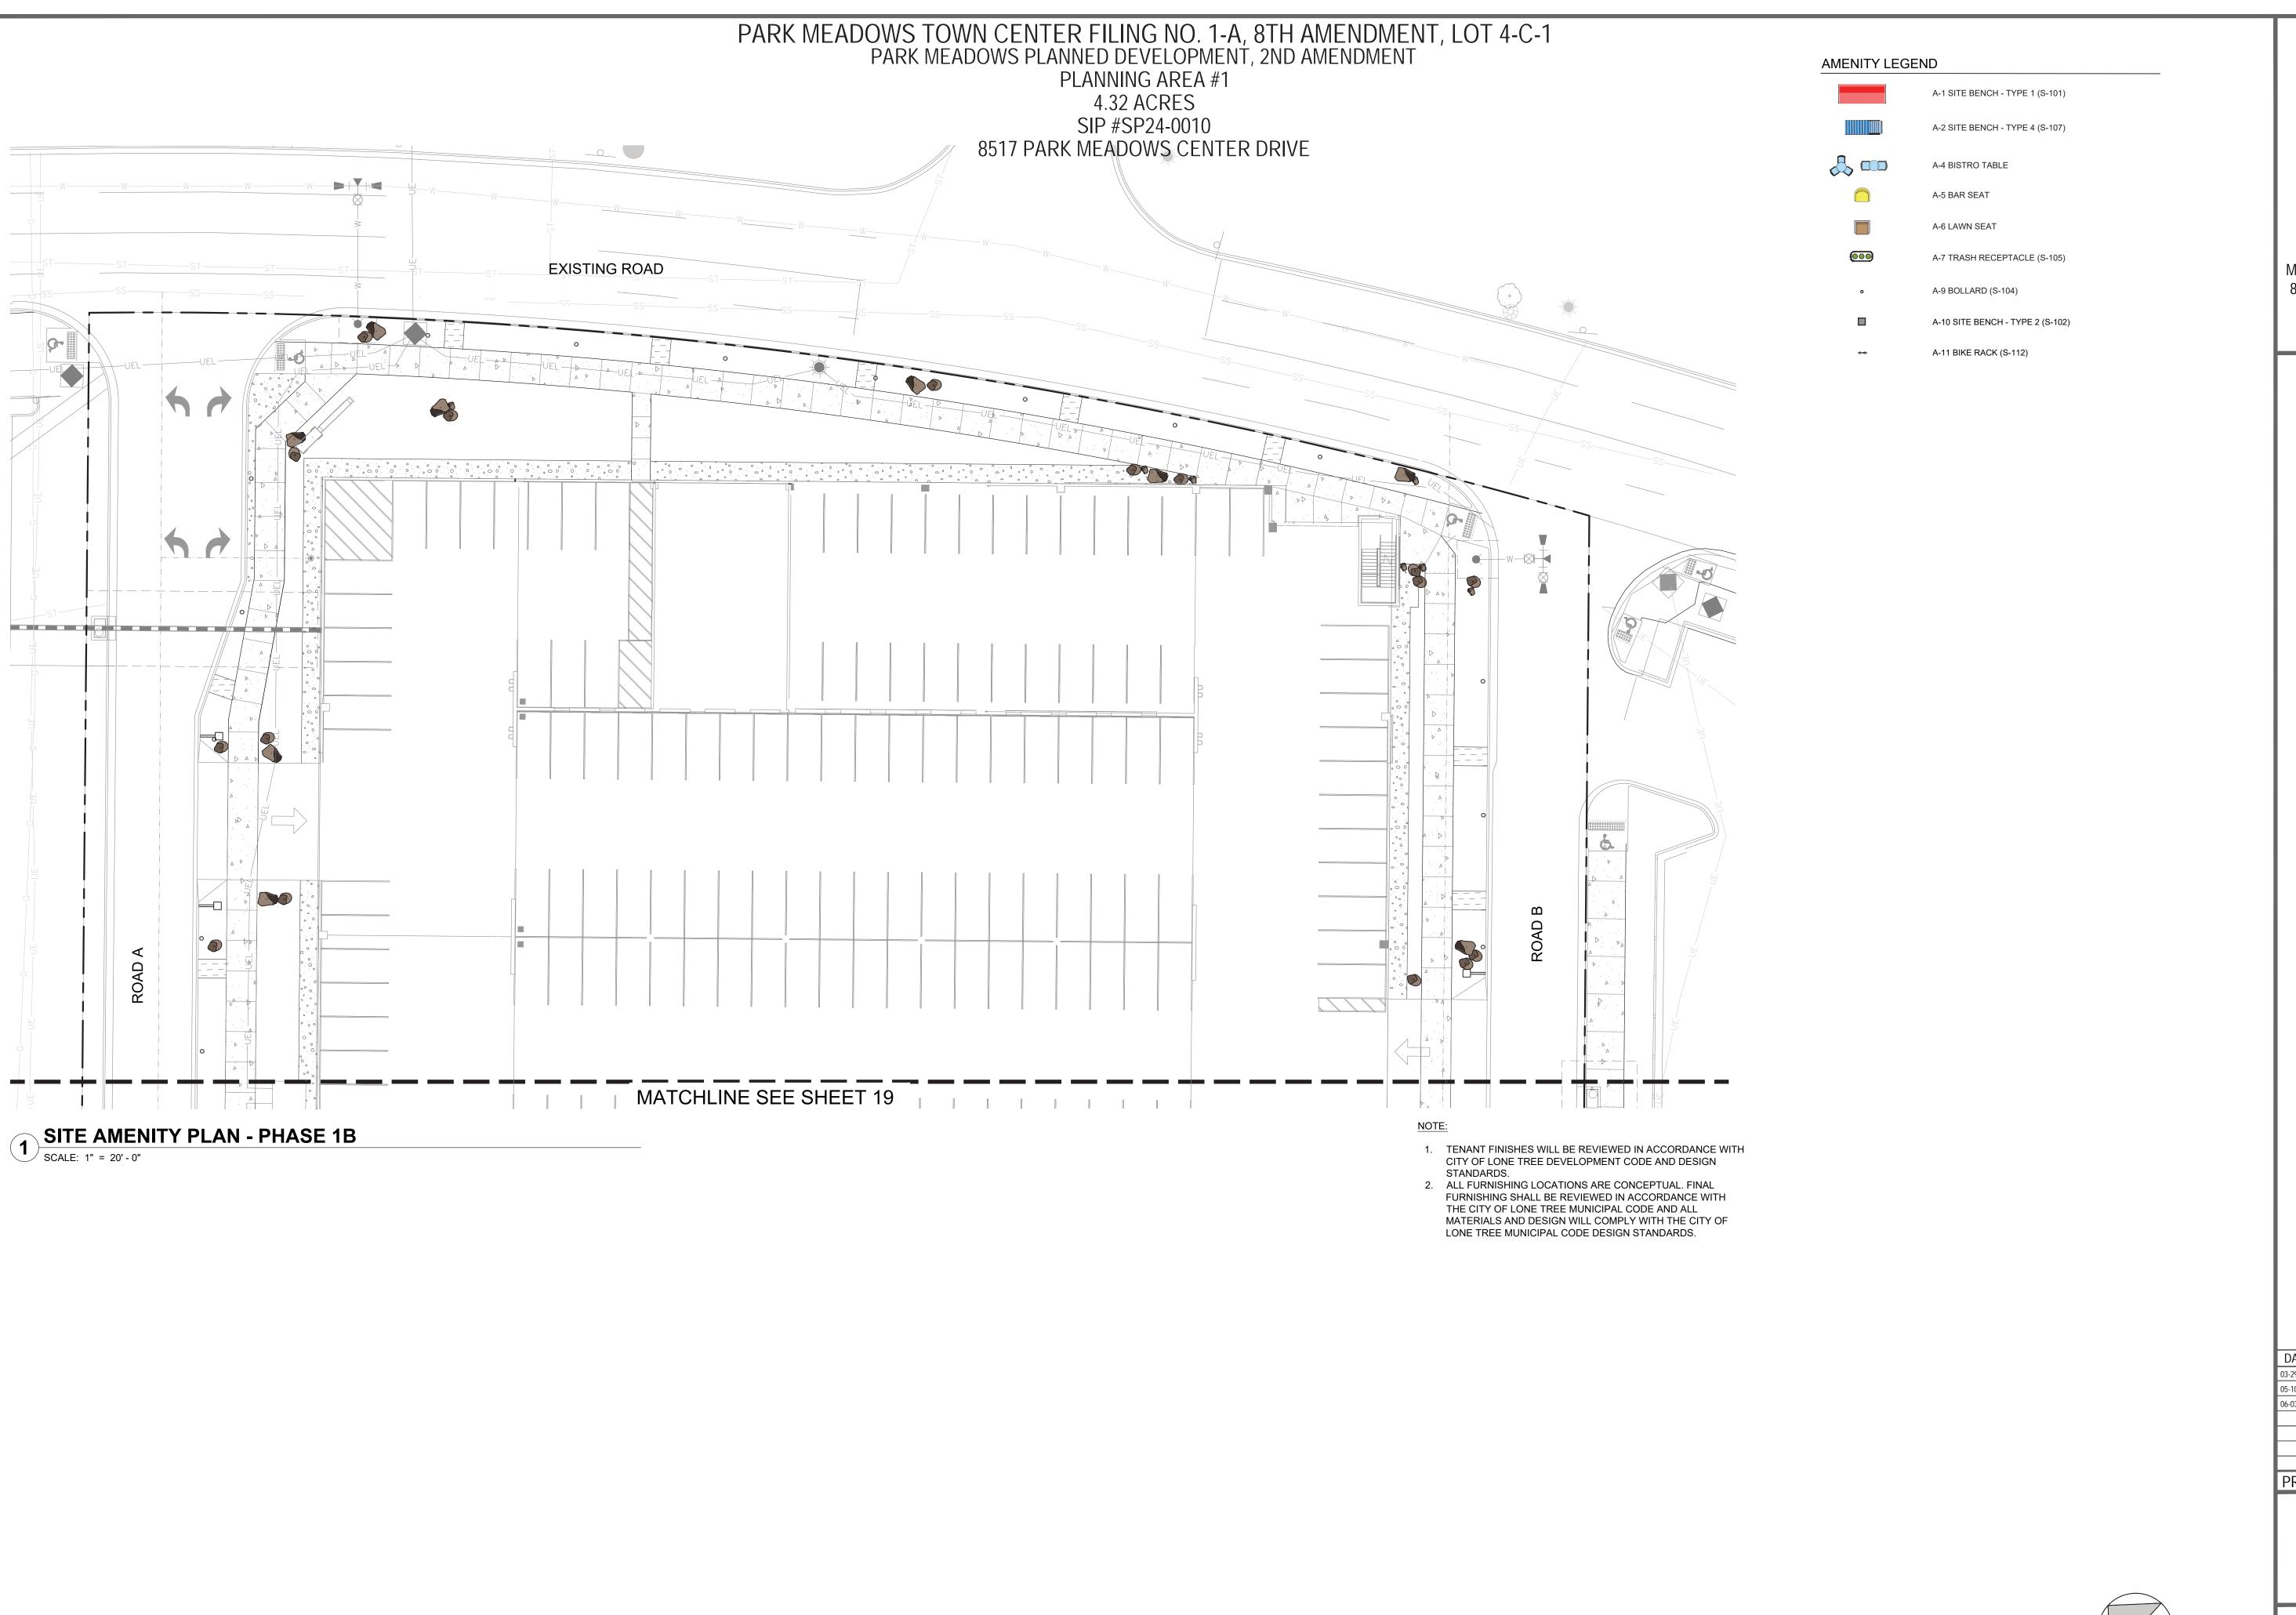

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LONE TREE, CO 80124

PARK MEADOWS - GARAGE AND PLAZA SITE IMPROVEMENT PLAN

LOT

8TH AMENDMENT,

NO.

FILING

PARK MEADOWS TOWN CENTER

DATE REVISION COMMENTS
03-29-2024 1ST SUBMITTAL

05-10-2024 2ND SUBMITTAL
06-03-2024 3RD SUBMITTAL

PROJECT #: 231016

SCALE: 1" = 5'

SITE AMENITY PLAN -

Sheet Number 20 of 54

PHASE 1B

PARK MEADOWS TOWN CENTER FILING NO. 1-A, 8TH AMENDMENT, LOT 4-C-1 PARK MEADOWS PLANNED DEVELOPMENT, 2ND AMENDMENT PLANNING AREA #1

4.32 ACRES SIP #SP24-0010

8517 PARK MEADOWS CENTER DRIVE











A-9 BOLLARD







A-5 BAR CHAIR

A-4 BISTRO TABLE





DATE | REVISION COMMENTS 03-29-2024 1ST SUBMITTAL 05-10-2024 2ND SUBMITTAL

PROJECT #: 231016

SITE AMENITIES -PHASE 1B

Sheet Number 21 of 54

STANDARDS.

1. FURNISHING SHOWN FOR CONCEPTUAL REVIEW ONLY, FINAL

FURNISHING SELECTION WILL BE REVIEWED IN ACCORDANCE WITH CITY OF LONE TREE DEVELOPMENT CODE AND DESIGN

A-6 LAWN SEAT

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PARK MEADOWS - GARAGE AND PLAZA SITE IMPROVEMENT PLAN

LOT

8TH AMENDMENT,

FILING NO.

PARK MEADOWS TOWN CENTER

PARK MEADOWS TOWN CENTER FILING NO. 1-A, 8TH AMENDMENT, LOT 4-C-1 PARK MEADOWS PLANNED DEVELOPMENT, 2ND AMENDMENT PLANNING AREA #1

4.32 ACRES SIP #SP24-0010 8517 PARK MEADOWS CENTER DRIVE



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MEADOWS ANCHOR ACQUISITION, LLC 8401 PARK MEADOWS CENTER DRIVE LONE TREE, CO 80124

PARK MEADOWS - GARAGE AND PLAZA SITE IMPROVEMENT PLAN

FILING NO. 1-A, 8TH AMENDMENT, LOT

DATE REVISION COMMENTS

PARK MEADOWS TOWN CENTER

03-29-2024 1ST SUBMITTAL 05-10-2024 | 2ND SUBMITTAL 06-03-2024 3RD SUBMITTAL

PROJECT #: 231016

SITE AMENITIES -PHASE 1B

Sheet Number 22 of 54



A-10 SITE BENCH 02



A-11 BIKE RACK

NOTES:

1. FURNISHING SHOWN FOR CONCEPTUAL REVIEW ONLY, FINAL FURNISHING SELECTION WILL BE REVIEWED IN ACCORDANCE WITH CITY OF LONE TREE DEVELOPMENT CODE AND DESIGN STANDARDS.

PLANNING AREA #1 4.32 ACRES SIP #SP24-0010

8517 PARK MEADOWS CENTER DRIVE

IRRIGATION LEGEND

SLEEVES: CLASS 200 PVC

POINT-OF-CONNECTION ASSEMBLY

MAINLINE PIPE: CLASS 200 PVC X-INCH SIZE UNLESS OTHERWISE INDICATED

LATERAL PIPE TO SPRINKLERS: CLASS 200 PVC

1-INCH SIZE UNLESS OTHERWISE INDICATED

— LATERAL PIPE TO TREE EMITTERS: CLASS 315 PVC 3/4-INCH SIZE UNLESS OTHERWISE INDICATED

— LATERAL PIPE TO INLINE DRIP HEADER: CLASS 200 PVC 3/4-INCH SIZE UNLESS OTHERWISE INDICATED

— UNCONNECTED PIPE CROSSING

INLINE DRIP TUBING: RAIN BIRD XFS-04-12 WITH RAINBIRD XQF DRIPLINE HEADER #.# GPH EMITTERS, ##" EMITTER SPACING, ##" ROW SPACING

REMOTE CONTROL VALVE ASSEMBLY FOR SPRINKLER LATERALS: RAIN BIRD PEB (SIZED PER PLAN)

REMOTE CONTROL DRIP VALVE ASSEMBLY: RAIN BIRD XCZ-PRB-100-COM

M WATER METER AND CURB STOP ASSEMBLY: BY OTHERS

QUICK COUPLING VALVE ASSEMBLY: RAIN BIRD 5RC

ISOLATION GATE VALVE ASSEMBLY: MATCO 514

F FLOW SENSOR ASSEMBLY: RAIN BIRD FS###

BACKFLOW PREVENTION ASSEMBLY: FEBCO 825YA (#")

MASTER VALVE ASSEMBLY: RAIN BIRD PEB (#")

INDICATES CONTROLLER AND STATION NUMBER INDICATES VALVE SIZE (INCHES) INDICATES LANDSCAPE APPLICATION

IRRIGATION CONTROLLER UNIT WITH **[EDIT FOR WEATHER SENSOR]** [EDIT FOR COMMUNICATION]

CONTACT HINES INC FOR CONTROLLER SPECIFICATION WEATHER SENSOR: CONTACT HINES INC FOR WEATHER SENSOR SPECIFICATION

- c - IRRIGATION CONTROL WIRES IN CONDUIT OR WITH WARNING TAPE

GROUNDING AND SURGE ARRESTOR ASSEMBLY: RAIN BIRD LSP-1TURF

IRRIGATION MAINLINE CAP ASSEMBLY

TREE BUBBLER ASSEMBLY: XXX (Y) RAIN BIRD 140ZZZ BUBBLERS FLOW (GPM): X.YY PER BUBBLER; X.ZZ PER ASSEMBLY

♦ ■ POP-UP SPRAY SPRINKLER: HUNTER PROS-06-PRS30-CV W/8 SERIES NOZZLE PRESSURE: 30 PSI RADIUS: 8 FEET FLOW (GPM): **Q-0.24 H-0.47 F-0.97**

Ø Ø POP-UP SPRAY SPRINKLER: HUNTER PROS-06-PRS30-CV W/10 SERIES NOZZLE PRESSURE: 30 PSI RADIUS: 10 FEET FLOW (GPM): **Q-0.42 H-0.88 F-1.59**

△ ▲ POP-UP SPRAY SPRINKLER: **HUNTER PROS-06-PRS30-CV W/12 SERIES NOZZLE** PRESSURE: **30 PSI** RADIUS: **12 FEET** FLOW (GPM): **Q-0.67 H-1.30 F-2.70**

• POP-UP SPRAY SPRINKLER: **HUNTER PROS-06-PRS30-CV W/15 SERIES NOZZLE** PRESSURE: **30 PSI** RADIUS: **15 FEET** FLOW (GPM): **Q-0.97 H-1.86 F-3.75**

□ 🛇 △ ○ POP-UP SPRAY SPRINKLER: HUNTER PROS-06-PRS30-CV W/ ADJUSTABLE NOZZLE PRESSURE: 30 PSI RADIUS: 5 FEET TO 15 FEET FLOW (GPM): **08A-0.44 10A-0.50 12A-0.32 15A-0.47**

↑ • POP-UP SPRAY SPRINKLER: **HUNTER PROS-06-PRS30-CV W/15SS SERIES NOZZLE** PRESSURE: 30 PSI RADIUS: 5 FEET X 15 FEET FLOW (GPM): **ES515-0.65 SS530-1.30**

(a) (b) POP-UP ROTATING SPRAY SPRINKLER: RAIN BIRD RD1806-S-P45 W/MP1000 NOZZLES PRESSURE: 45 PSI RADIUS: 8 FEET TO 15 FEET FLOW (GPM): **M-0.44 L-0.67 O-0.88**

☑ ☑ POP-UP ROTATING SPRAY SPRINKLER: RAIN BIRD RD1806-S-P45 W/MP2000 NOZZLES PRESSURE: 45 PSI RADIUS: 13 FEET TO 21 FEET FLOW (GPM): **Q-0.85 H-1.17 F-1.57**

® ♥ A POP-UP ROTATING SPRAY SPRINKLER: RAIN BIRD RD1806-S-P45 PRESSURE: 45 PSI RADIUS: 22 FEET TO 30 FEET FLOW (GPM): **Q-1.93 H-2.89 F-3.86**

INSTALLATION GENERAL NOTES

- 1. THE SYSTEM DESIGN ASSUMES A MINIMUM DYNAMIC PRESSURE FOR THE 6. PROVIDE THE FOLLOWING COMPONENTS TO THE OWNER PRIOR TO THE IRRIGATION SYSTEM OF 60 PSI, AT A DESIGN FLOW OF 14 GPM AT THE 1-INCH IRRIGATION POINT-OF-CONNECTION (POC). TAP, METER, BACKFLOW PREVENTER, MASTER VALVE AND FLOW METER SHALL BE SIZED AS INDICATED


 A. TWO (2) OPERATING KEYS FOR EACH TYPE OF MANUALLY OPERATED IN THE DRAWING LEGEND. VERIFY PRESSURE AND FLOW ON SITE PRIOR TO CONSTRUCTION.
- READ THOROUGHLY AND BECOME FAMILIAR WITH THE SPECIFICATIONS AND INSTALLATION DETAILS FOR THIS AND RELATED WORK PRIOR TO CONSTRUCTION.
- 3. COORDINATE UTILITY LOCATES ("CALL BEFORE YOU DIG") OF UNDERGROUND UTILITIES PRIOR TO CONSTRUCTION.
- 4. DO NOT PROCEED WITH THE INSTALLATION OF THE IRRIGATION SYSTEM WHEN IT IS OBVIOUS IN THE FIELD THAT OBSTRUCTIONS OR GRADE DIFFERENCES EXIST THAT MIGHT NOT HAVE BEEN CONSIDERED IN THE ENGINEERING. IF DISCREPANCIES IN CONSTRUCTION DETAILS, LEGEND, NOTES, OR SPECIFICATIONS ARE DISCOVERED, BRING ALL SUCH **OBSTRUCTIONS OR DISCREPANCIES TO THE ATTENTION OF THE OWNER'S** REPRESENTATIVE.
- 5. THE DRAWINGS ARE DIAGRAMMATIC. THEREFORE, THE FOLLOWING SHOULD
- A. ALTHOUGH IRRIGATION COMPONENTS MAY BE SHOWN OUTSIDE PLANTING AREAS FOR CLARITY, INSTALL IRRIGATION PIPE AND WIRING IN LANDSCAPED AREAS WHENEVER POSSIBLE.
- B. TREE AND SHRUB LOCATIONS AS SHOWN ON LANDSCAPE PLANS TAKE PRECEDENCE OVER IRRIGATION EQUIPMENT LOCATIONS. AVOID CONFLICTS BETWEEN THE IRRIGATION SYSTEM, PLANTING MATERIALS, AND ARCHITECTURAL FEATURES.
- C. USE ONLY STANDARD TEES AND ELBOW FITTINGS. USE OF TEES IN THE BULLNOSE CONFIGURATION, OR USE OF CROSS TYPE FITTINGS IS NOT ALLOWED.

- COMPLETION OF THE PROJECT:
- VALVES.
- B. TWO (2) OF EACH SERVICING WRENCH OR TOOL NEEDED FOR COMPLETE ACCESS, ADJUSTMENT, AND REPAIR OF ALL ROTARY SPRINKLERS.
- 7. SELECT NOZZLES FOR SPRAY AND ROTARY SPRINKLERS WITH ARCS WHICH PROVIDE COMPLETE AND ADEQUATE COVERAGE WITH MINIMUM OVERSPRAY FOR THE SITE CONDITIONS. CAREFULLY ADJUST THE RADIUS OF THROW AND ARC OF COVERAGE OF EACH ROTARY SPRINKLER TO PROVIDE THE BEST PERFORMANCE.
- 8. THE IRRIGATION CONTRACTOR IS RESPONSIBLE FOR THE INSTALLATION OF IRRIGATION SLEEVING. SLEEVES ARE REQUIRED FOR BOTH PIPING AND ELECTRICAL WIRING AT EACH HARDSCAPE CROSSING. COORDINATE INSTALLATION OF SLEEVING WITH OTHER TRADES. ANY PIPE OR WIRE WHICH PASSES BENEATH EXISTING HARDSCAPE WHERE SLEEVING WAS NOT INSTALLED WILL REQUIRE HORIZONTAL BORING BY THE IRRIGATION CONTRACTOR. PIPE SLEEVES SHALL BE SIZED TWICE THE NOMINAL SIZE OF THE PIPE PASSING THROUGH.
- 9. INSTALL ALL ELECTRICAL POWER TO THE IRRIGATION CONTROL SYSTEM IN ACCORDANCE WITH THE NATIONAL ELECTRIC CODE AND ALL APPLICABLE LOCAL ELECTRIC UTILITY CODES.
- 10. THE FOLLOWING SHOULD BE NOTED REGARDING PIPE SIZING: IF A SECTION OF UNSIZED PIPE IS LOCATED BETWEEN TWO IDENTICALLY SIZED SECTIONS, THE UNSIZED PIPE IS THE SAME NOMINAL SIZE AS THE TWO SIZED SECTIONS. THE UNSIZED PIPE SHOULD NOT BE CONFUSED WITH THE DEFAULT PIPE SIZE NOTED IN THE LEGEND.
- 11. INSTALL ONE (1) #14 AWG TWO-WIRE PAIR ON TWO-WIRE SYSTEMS, FOR USE AS SPARES. INSTALL SPARE WIRES FROM CONTROLLER LOCATION TO EACH DEAD-END OF MAINLINE. COIL 3 FEET OF WIRE IN VALVE BOX.
- 12. IRRIGATION CONTRACTOR TO INSTALL PAIGE DECODER CABLE FUSE DEVICES (DCFD), AT ALL DECODER CABLE DIRECTIONAL SPLITS AND/OR CHANGES. **INSTALL ALL SPLICES WITHIN A 10" VALVE BOX.**



FORT COLLINS, COLORADO 80526

Telephone: 970.282.1800

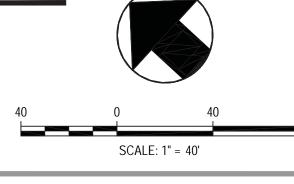

AMENDMENT 8TH NO. FILING ENTER ARK \Box TOWN S MOQ. MEAI

 $\overline{\mathsf{O}}$

Denver, Colorado 80203 P: 303.623.6300 F: 303.623.631

HarrisKocherSmith.com

OWNER:

PARK MEADOWS MALL, LLC / PARK MEADOWS ANCHOR ACQUISITION, LLC

8401 PARK MEADOWS CENTER DRIVE

LONE TREE, CO 80124

DATE | REVISION COMMENTS 03-29-2024 | 1ST SUBMITTAL 05-10-2024 | 2ND SUBMITTAL

06-03-2024 3RD SUBMITTAL

PARK

PROJECT #: 231016

IR100 - NOTES & **LEGENDS**

SHEET NUMBER 23 of 54

INSTALL IRRIGATION COMPONENTS WITHIN LANDSCAPED AREA. REMOTE CONTROL VALVES LABELED "B" TO BE INSTALLED IN PHASE 1B. REMOTE CONTROL VALVES LABELED "A" ARE EXISTING AND INSTALLED IN PHASE 1A

IRRIGATION SHOWN OUT OF LANDSCAPED AREA FOR CLARITY ONLY.

THE IRRIGATION SYSTEM POINT-OF-CONNECTION (POC) SHALL BE

DOWNSTREAM OF THE IRRIGATION WATER TAP AND METER INSTALLED BY

IRRIGATION CONTRACTOR TO WALL MOUNT THE IRRIGATION CONTROLLER

MAINTENANCE, AND SCREENED FROM VIEW EITHER BEHIND ENTRY WALLS, NEXT TO BUILDINGS, OR BEHIND PLANT MATERIAL. FINAL LOCATION TO BE

IRRIGATION CONTRACTOR TO CUT AND CAP MAINLINE FOR EXPANSION TO PHASE 1 AT FULL BUILDOUT AND COIL 3 FEET OF CONTROL WIRE IN 10-INCH

AT THE APPROXIMATE LOCATION SHOWN. ELECTRICAL POWER TO THE

THE UTILITY CONTRACTOR AT THE APPROXIMATE LOCATION SHOWN.

IRRIGATION CONTRACTOR TO INSTALL BACKFLOW PREVENTION UNIT.

VERIFY EXACT LOCATION OF POC WITH OWNER'S REPRESENTATIVE.

CONTROLLER TO BE PROVIDED BY THE ELECTRICAL CONTRACTOR, TERMINATED IN A JUNCTION BOX FOR HARD-WIRE CONNECTION TO THE

IRRIGATION CONTROLLER. CARE SHOULD BE TAKEN TO INSTALL THE

IRRIGATION CONTROLLER IN A LOCATION THAT IS ACCESSIBLE FOR

ROUND VALVE BOX AT APPROXIMATE LOCATION SHOWN.

APPROVED BY OWNER'S REPRESENTATIVE.

R102

NORTH PARKING

POC (1)

SIZE: 3/4-INCH PRESSURE: 60 PSI

FLOW: 14 GPM

IRRIGATION NOTES

CONTROLLER (2)


120 VAC POWER REQUIRED

EXISTING MALL

BUILDING

PLANNING AREA # 4.32 ACRES SIP #SP24-0010

8517 PARK MEADOWS CENTER DRIVE

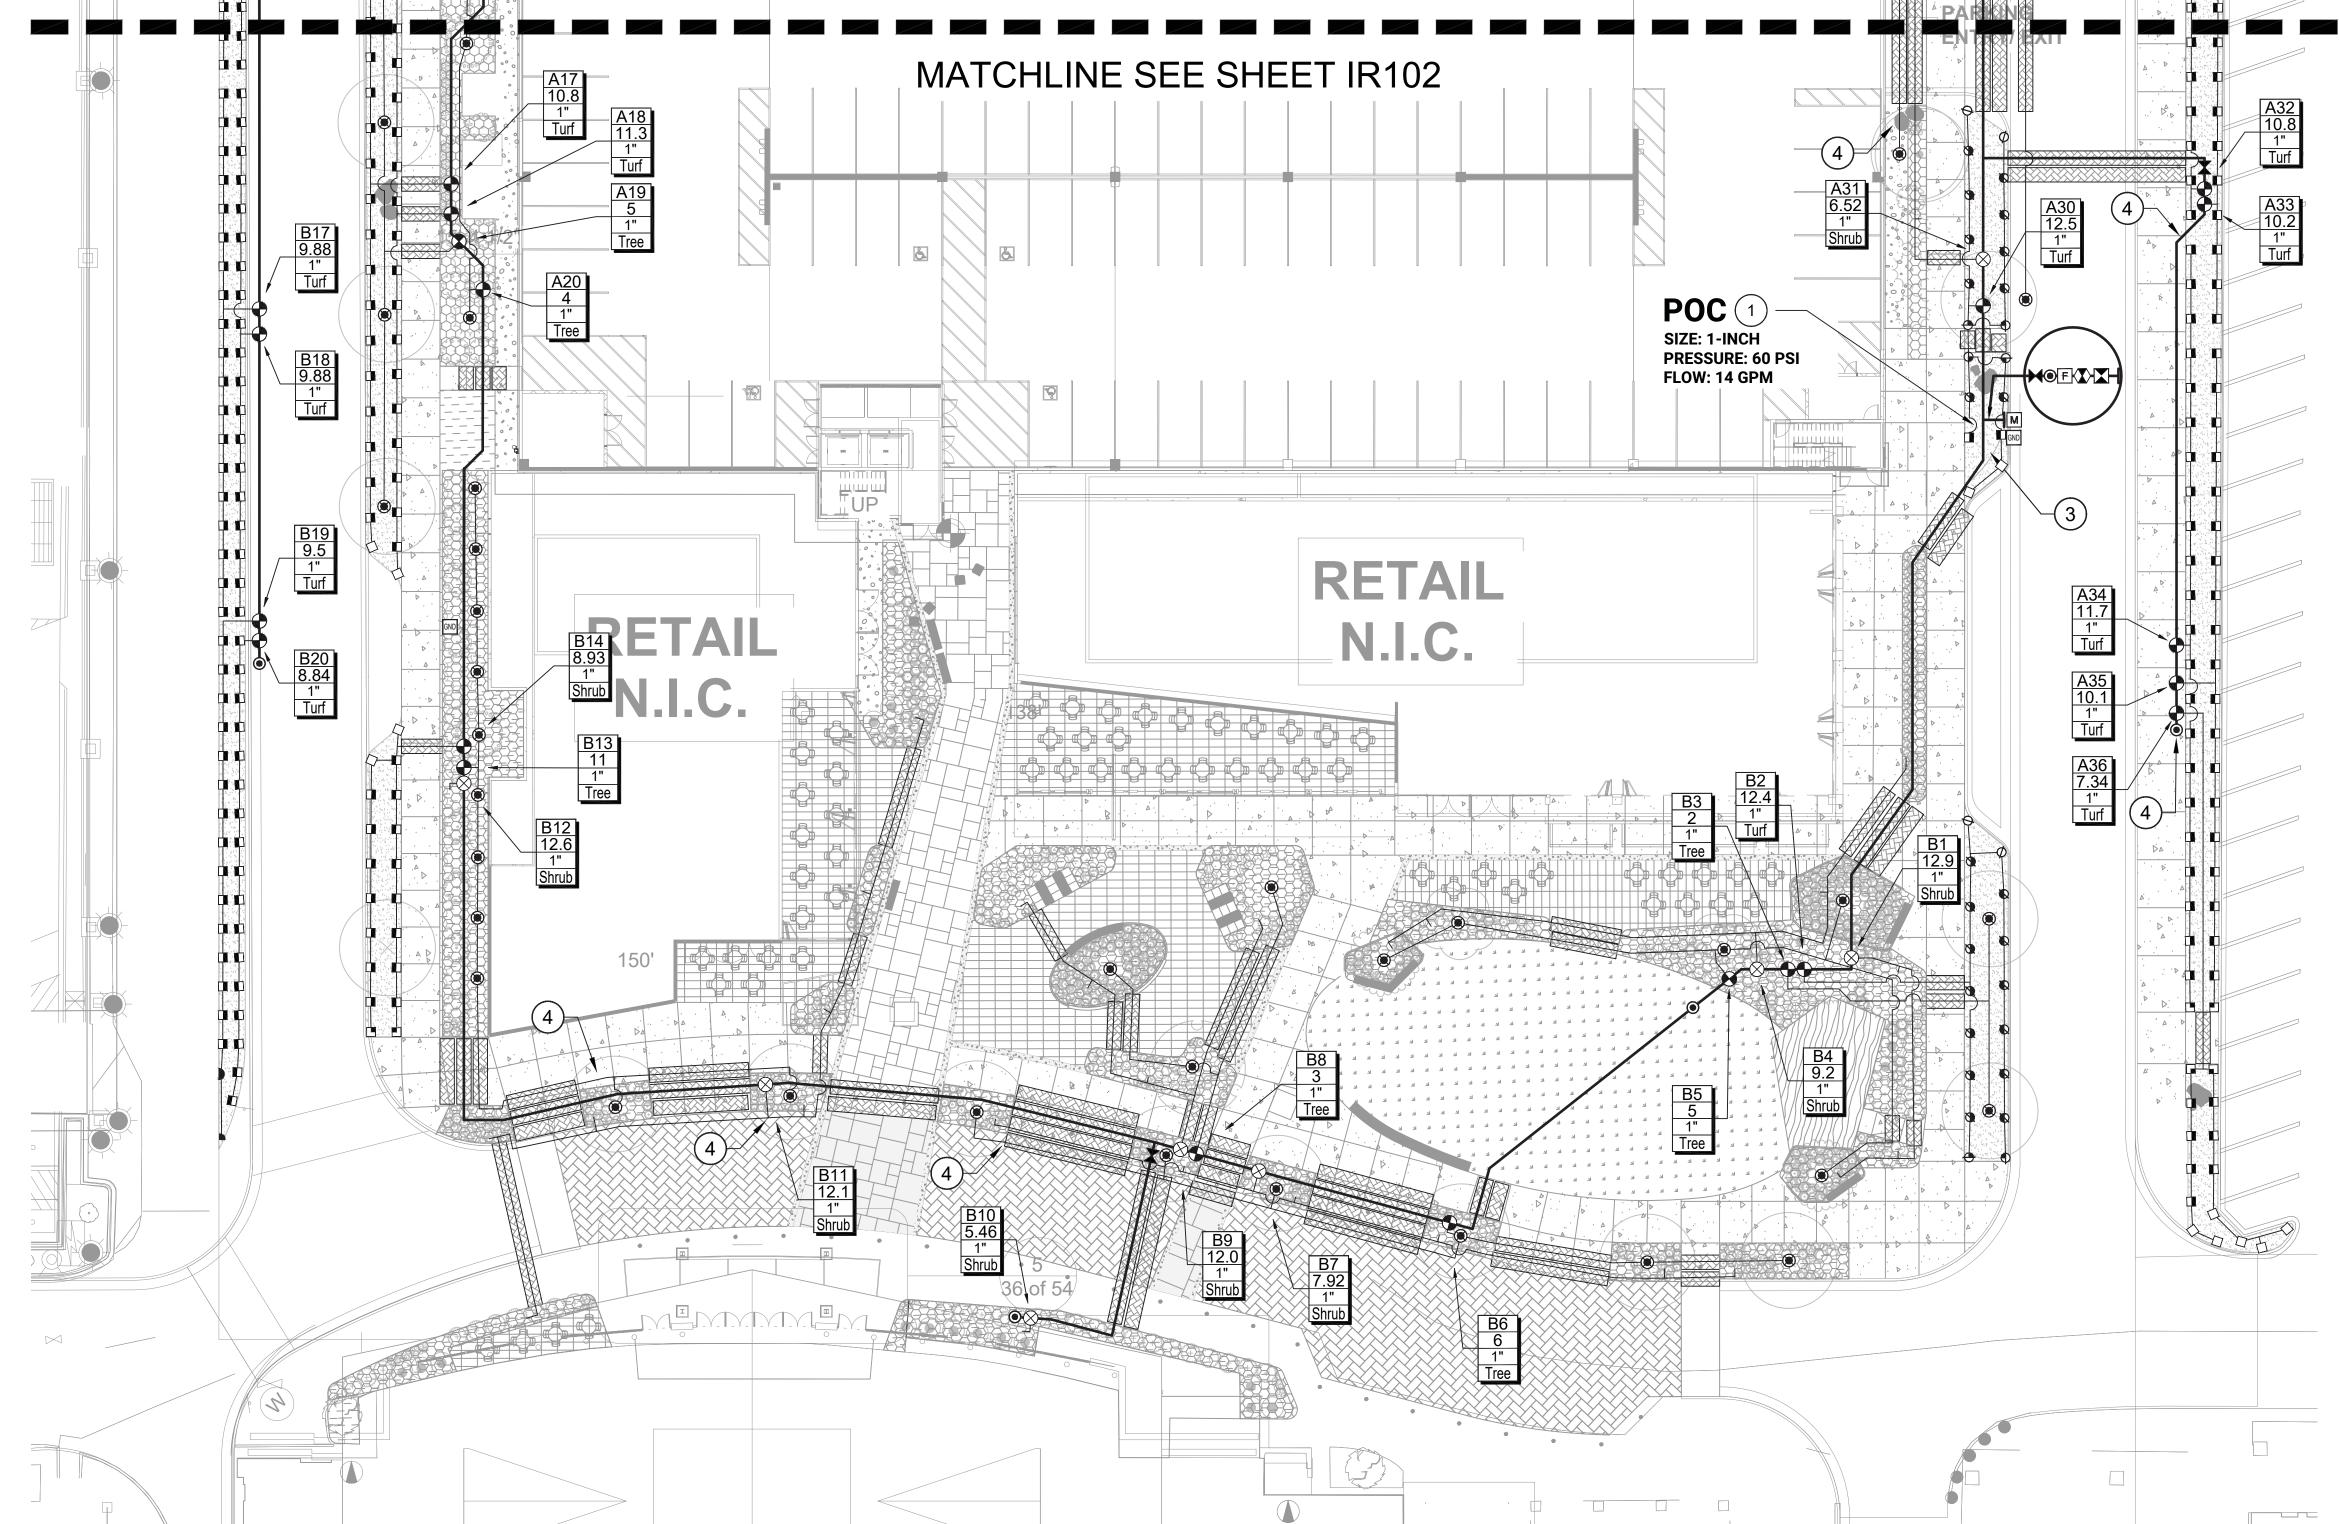



- THE IRRIGATION SYSTEM POINT-OF-CONNECTION (POC) SHALL BE DOWNSTREAM OF THE IRRIGATION WATER TAP AND METER INSTALLED BY THE UTILITY CONTRACTOR AT THE APPROXIMATE LOCATION SHOWN. IRRIGATION CONTRACTOR TO INSTALL BACKFLOW PREVENTION UNIT. VERIEY EXACT LOCATION OF POC WITH OWNER'S REPRESENTATIVE
- IRRIGATION CONTRACTOR TO WALL MOUNT THE IRRIGATION CONTROLLER AT THE APPROXIMATE LOCATION SHOWN. ELECTRICAL POWER TO THE CONTROLLER TO BE PROVIDED BY THE ELECTRICAL CONTRACTOR, TERMINATED IN A JUNCTION BOX FOR HARD-WIRE CONNECTION TO THE IRRIGATION CONTROLLER. CARE SHOULD BE TAKEN TO INSTALL THE IRRIGATION CONTROLLER IN A LOCATION THAT IS ACCESSIBLE FOR MAINTENANCE, AND SCREENED FROM VIEW EITHER BEHIND ENTRY WALLS, NEXT TO BUILDINGS, OR BEHIND PLANT MATERIAL. FINAL LOCATION TO BE APPROVED BY OWNER'S REPRESENTATIVE.
- 3 IRRIGATION CONTRACTOR TO CUT AND CAP MAINLINE FOR EXPANSION TO PHASE 1 AT FULL BUILDOUT AND COIL 3 FEET OF CONTROL WIRE IN 10-INCH ROUND VALVE BOX AT APPROXIMATE LOCATION SHOWN.
- 4 IRRIGATION SHOWN OUT OF LANDSCAPED AREA FOR CLARITY ONLY. INSTALL IRRIGATION COMPONENTS WITHIN LANDSCAPED AREA.

REMOTE CONTROL VALVES LABELED "B" TO BE INSTALLED IN PHASE 1B. REMOTE CONTROL VALVES LABELED "A" ARE EXISTING AND INSTALLED IN PHASE 1A



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PARK MEADOWS TOWN CENTER FILING NO. 1-A, 8TH AMENDMENT, LOT

4-C

DATE REVISION COMMENTS
03-29-2024 IST SUBMITTAL


05-10-2024 2ND SUBMITTAL 06-03-2024 3RD SUBMITTAL

PROJECT #: 231016

IR101 -IRRIGATION PLAN


SHEET NUMBER

24 of 54

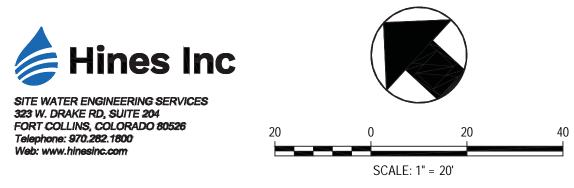

PLANNING AREA # 4.32 ACRES SIP #SP24-0010

8517 PARK MEADOWS CENTER DRIVE

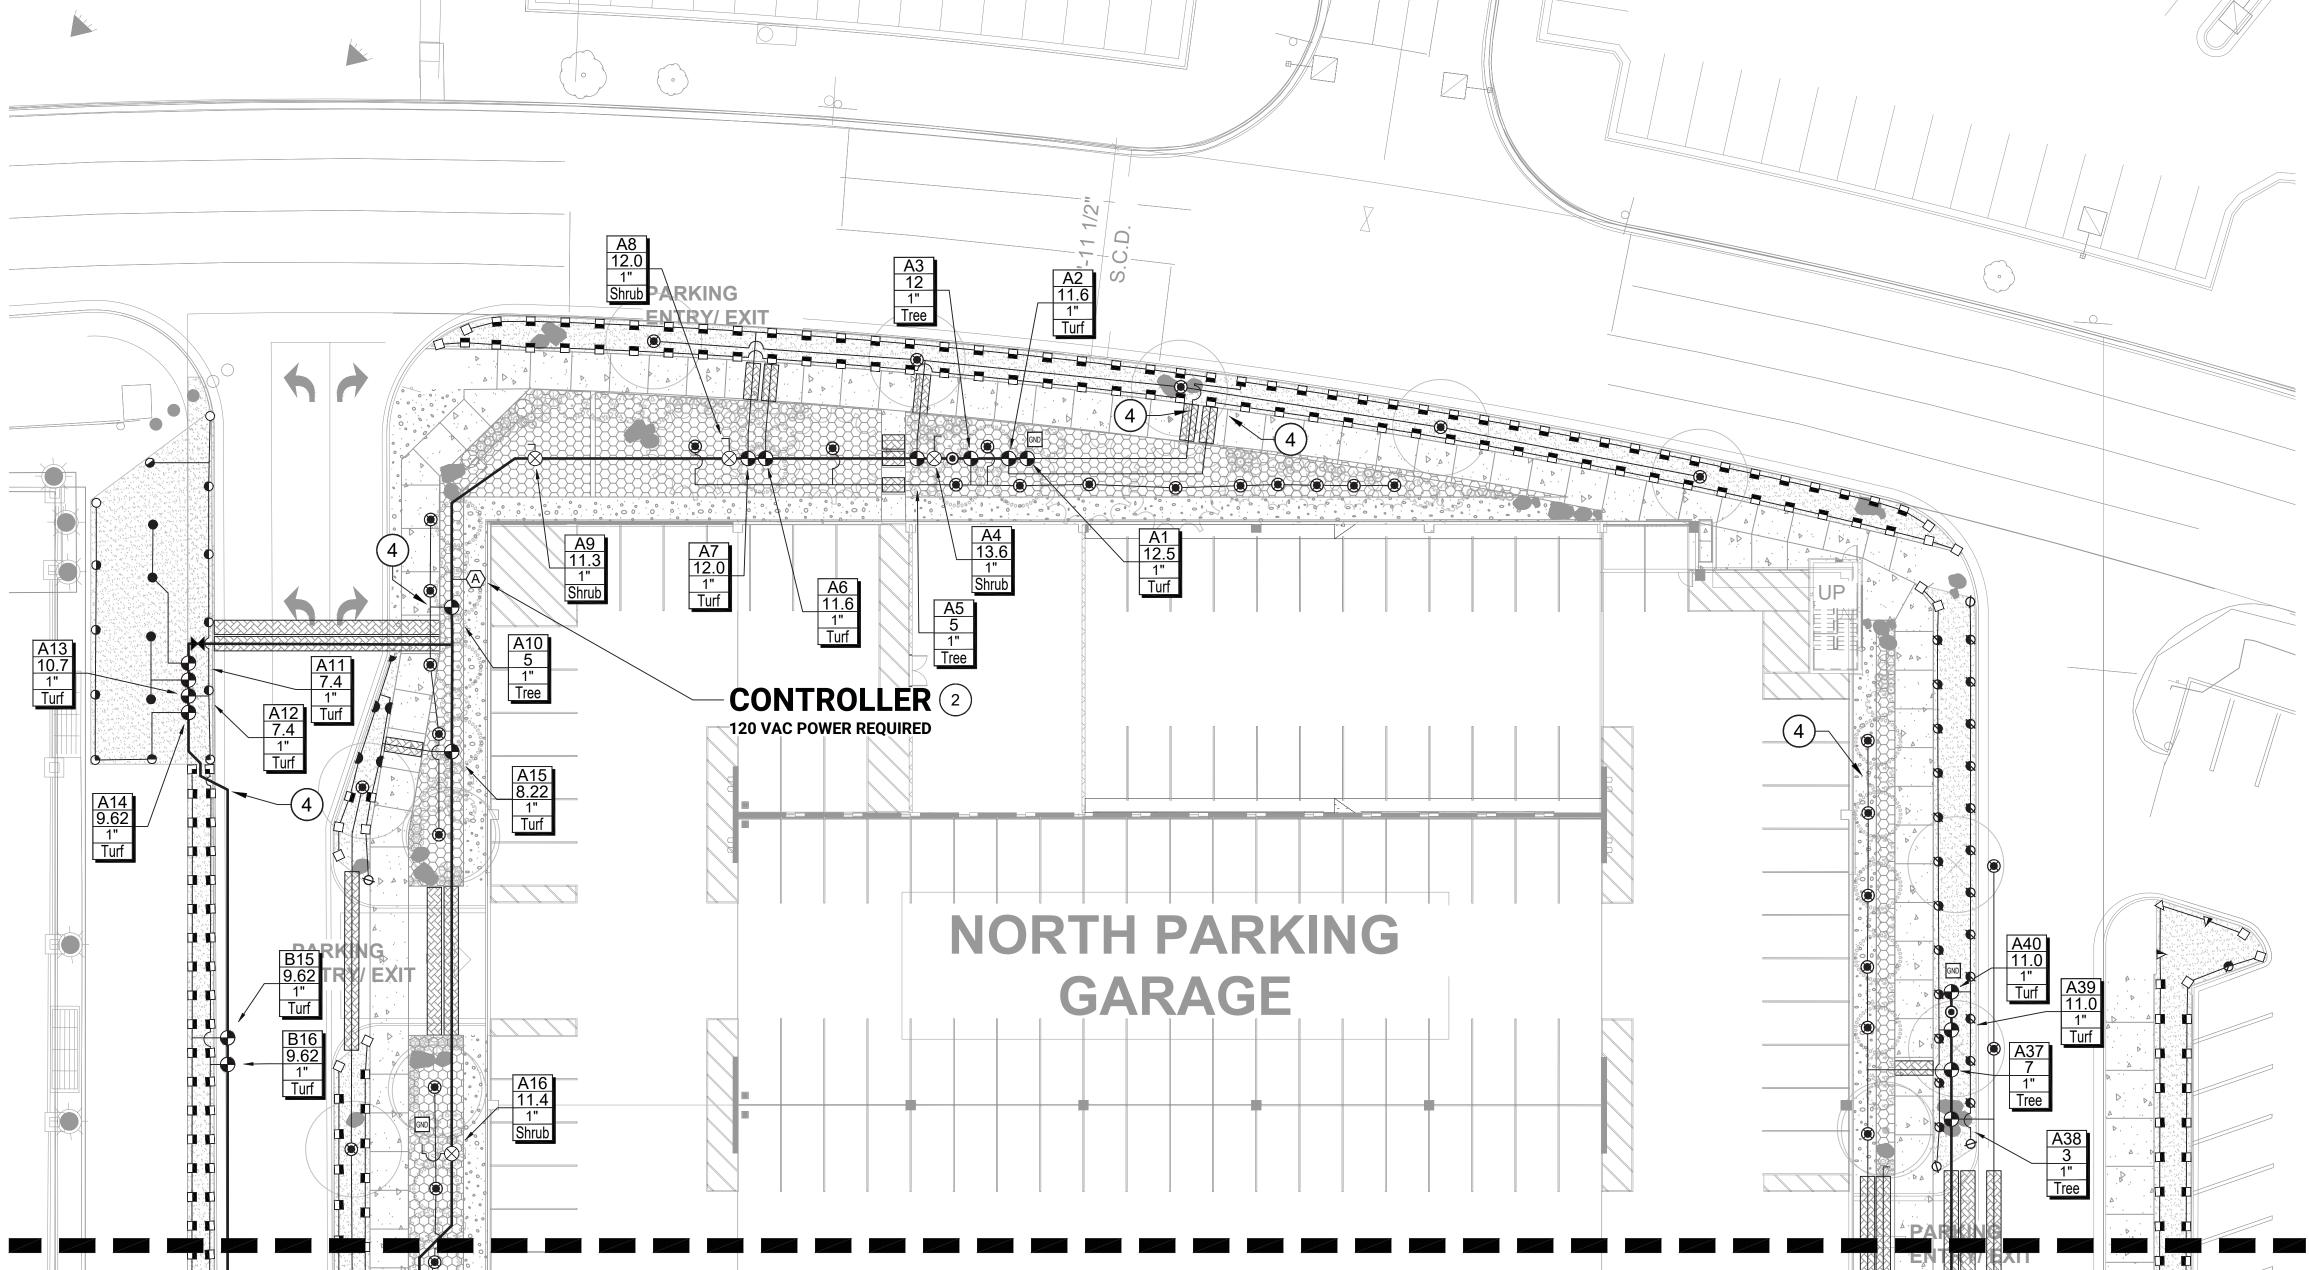

MATCHLINE SEE SHEET IR101

IRRIGATION NOTES

- THE IRRIGATION SYSTEM POINT-OF-CONNECTION (POC) SHALL BE DOWNSTREAM OF THE IRRIGATION WATER TAP AND METER INSTALLED BY THE UTILITY CONTRACTOR AT THE APPROXIMATE LOCATION SHOWN. IRRIGATION CONTRACTOR TO INSTALL BACKFLOW PREVENTION UNIT. VERIFY EXACT LOCATION OF POC WITH OWNER'S REPRESENTATIVE.
- IRRIGATION CONTRACTOR TO WALL MOUNT THE IRRIGATION CONTROLLER AT THE APPROXIMATE LOCATION SHOWN. ELECTRICAL POWER TO THE CONTROLLER TO BE PROVIDED BY THE ELECTRICAL CONTRACTOR, TERMINATED IN A JUNCTION BOX FOR HARD-WIRE CONNECTION TO THE IRRIGATION CONTROLLER. CARE SHOULD BE TAKEN TO INSTALL THE IRRIGATION CONTROLLER IN A LOCATION THAT IS ACCESSIBLE FOR MAINTENANCE, AND SCREENED FROM VIEW EITHER BEHIND ENTRY WALLS, NEXT TO BUILDINGS, OR BEHIND PLANT MATERIAL. FINAL LOCATION TO BE APPROVED BY OWNER'S REPRESENTATIVE.
- (3) IRRIGATION CONTRACTOR TO CUT AND CAP MAINLINE FOR EXPANSION TO PHASE 1 AT FULL BUILDOUT AND COIL 3 FEET OF CONTROL WIRE IN 10-INCH ROUND VALVE BOX AT APPROXIMATE LOCATION SHOWN.
- 4 IRRIGATION SHOWN OUT OF LANDSCAPED AREA FOR CLARITY ONLY. INSTALL IRRIGATION COMPONENTS WITHIN LANDSCAPED AREA.

REMOTE CONTROL VALVES LABELED "B" TO BE INSTALLED IN PHASE 1B. REMOTE CONTROL VALVES LABELED "A" ARE EXISTING AND INSTALLED IN PHASE 1A



1120 Lincoln Street, Suite 1000 Denver, Colorado 80203 P: 303.623.6300 F: 303.623.6311 HarrisKocherSmith.com

OWNER:

PARK MEADOWS MALL, LLC / PARK
MEADOWS ANCHOR ACQUISITION, LLC
8401 PARK MEADOWS CENTER DRIVE
LONE TREE, CO 80124

PARK MEADOWS TOWN CENTER FILING NO. 1-A, 8TH AMENDMENT, LOT

DATE REVISION COMMENTS

03-29-2024 1ST SUBMITTAL

05-10-2024 2ND SUBMITTAL

06-03-2024 3RD SUBMITTAL


PROJECT #: 231016

IR102 -IRRIGATION PLAN

SHEET NUMBER

25 of 54



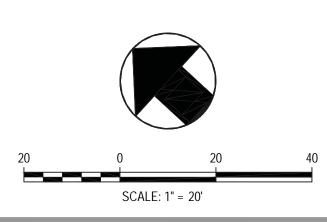

PARK MEADOWS TOWN CENTER FILING NO. 1-A, 8TH AMENDMENT, LOT 4-C-1 PARK MEADOWS PLANNED DEVELOPMENT, 2ND AMENDMENT

PLANNING AREA #1 4.32 ACRES SIP #SP24-0010

8517 PARK MEADOWS CENTER DRIVE

PIPE AND WIRE

SLEEVING


— PIPE

SLEEVE

- WIRING

SLEEVE

CONCRETE SLAB —

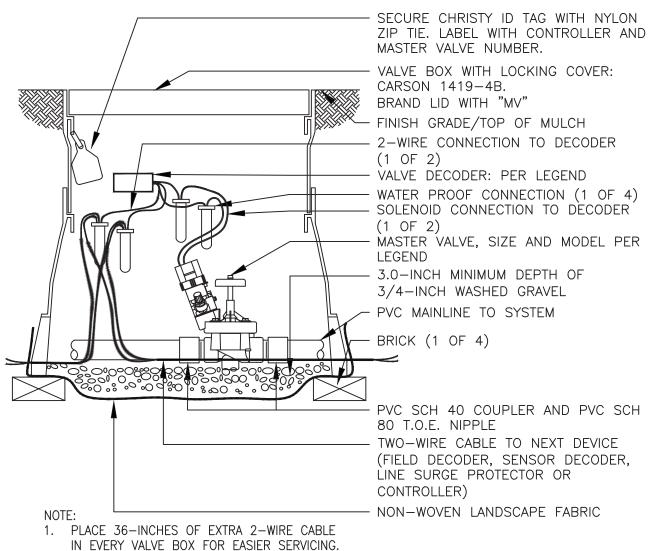

SECURE CHRISTY ID TAG WITH NYLON ZIP TIE. LABEL WITH CONTROLLER AND FLOW SENSOR NUMBER. VALVE BOX WITH LOCKING COVER: CARSON 1419-4B. BRAND "FM" ON LID W/ 3-INCH HIGH LTRS. - FINISH GRADE/TOP OF MULCH TWO (2) CONDUCTOR TWISTED PAIR SHIELDÉD DIRECT BURIAL CABLE FOR CONNECTION TO TRANSMITTER WATER PROOF CONNECTION (1 OF 2) - FLOW SENSOR PER LEGEND MIN. 10 PIPE DIA. MIN. 5 PIRE, DIA. STRAIGHT PIPE FLOW -PVC MAINLINE BRICK (1 OF 4) 3-INCH MINIMUM DEPTH OF 3/4-INCH WASHED GRAVEL NON-WOVEN LANDSCAPE FABRIC

LATERAL PIPE

EXCAVATED MATERIAL

-- WARNING TAPE

TYPICAL TRENCHING

1. SLEEVE ALL PIPE AND WIRE SEPARATELY.

DIRECTION OVER 30 DEGREES.

BEDDING & COVER MATERIAL

3. ALL 120-V WIRING SHALL BE INSTALLED IN ACCORDANCE WITH LOCAL CODE

REQUIREMENTS. PROVIDE LOOSE 20" LOOP OF 2-WIRE CABLE AT ALL CHANGES OF

2. ALL PIPE TO BE INSTALLED PER MANUFACTURER'S SPECIFICATIONS."SNAKE" UNSLEEVED


PLASTIC PIPE IN TRENCH. PROVIDE A MINIMUM OF 2" CLEARANCE TO SIDE OF TRENCH

FLOW SENSOR

-FINISH GRADE-

& 24-V WIRE

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1. NOMINAL SIZE OF GATE VALVE TO MATCH NOMINAL MAINLINE SIZE.

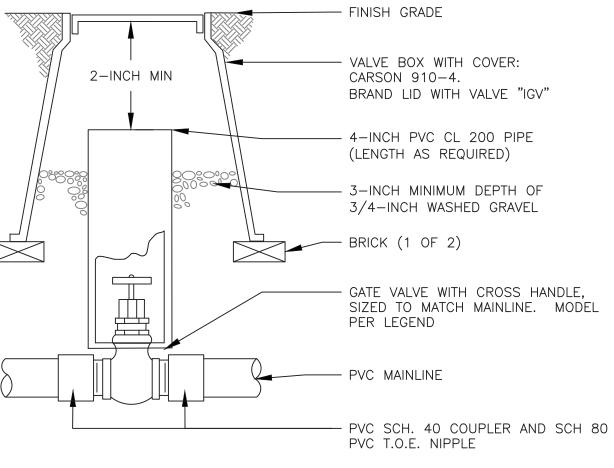
__ 3-INCH MAX FINISH GRADE - QUICK COUPLING VALVE PER LEGEND STAINLESS STEEL HOSE CLAMP (1 OF 2) - 36-INCH No. 6 EPOXY COATED REBAR 3-INCH DEPTH OF 3/4-INCH WASHED - BRICK (1 OF 2) SCH 80 PVC NIPPLE, TOE (LENGTH VARIES) PRE-FABRICATED SWING JOINT: SPEARS 5815-010-10 PVC MAINLINE PIPE SCH 40 PVC TEE OR EL WITH FPT OUTLET NON-WOVEN LANDSCAPE FABRIC

VALVE BOX WITH COVER:


BRAND LID WITH VALVE "QC"

CARSON 910-4.

ISOLATION GATE VALVE ASSEMBLY 2.5-INCH MAINLINE AND SMALLER

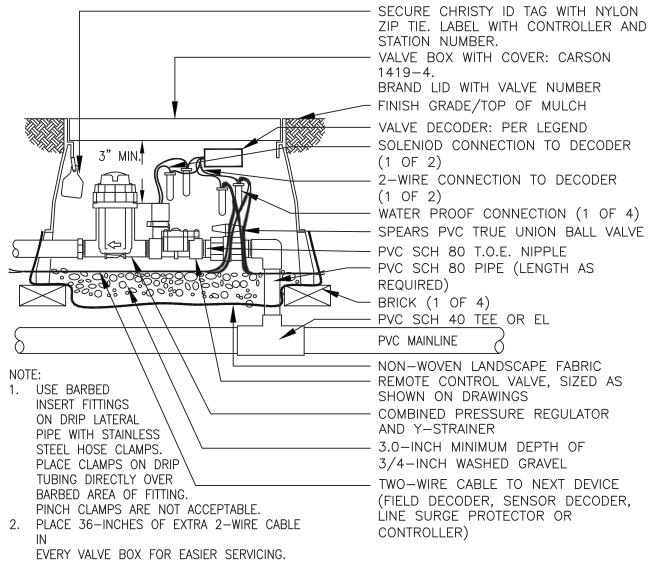

REMOTE CONTROL DRIP VALVE ASSEMBLY

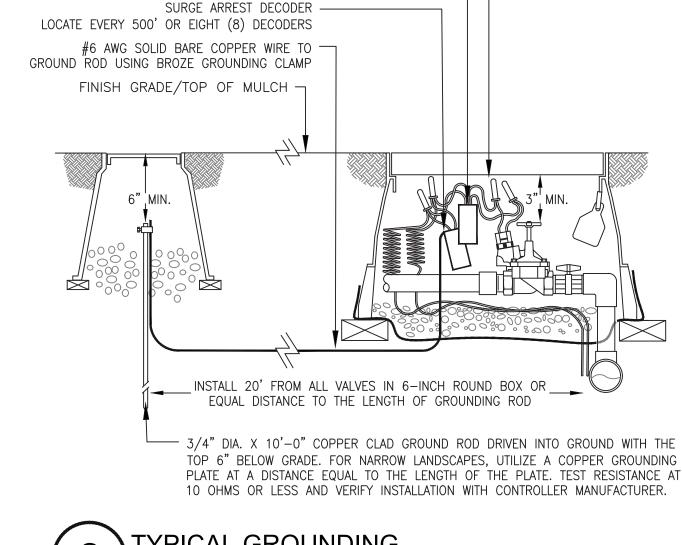

TYPICAL GROUNDING (AT VALVE) ASSEMBLY


QUICK COUPLING

ALVE ASSEMBLY


WATER PROOF CONNECTION (QUANTITY AS REQUIRED) ——

VALVE DECODER

MASTER VALVE **ASSEMBLY**

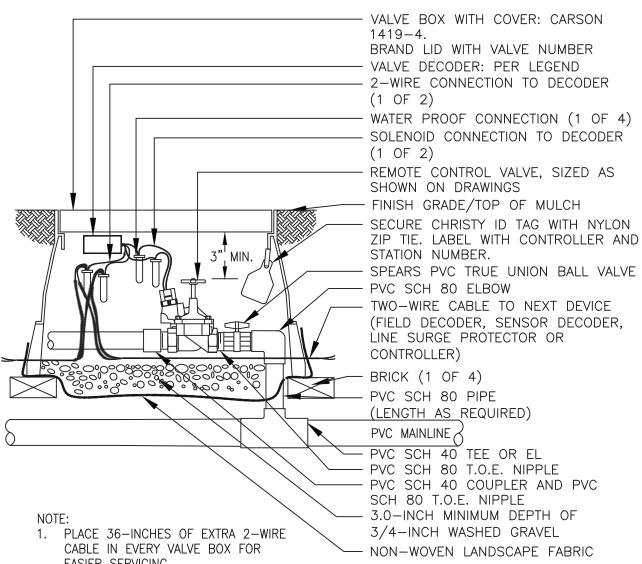


EASIER SERVICING. REMOTE CONTROL BUBBLER VALVE ASSEMBLY

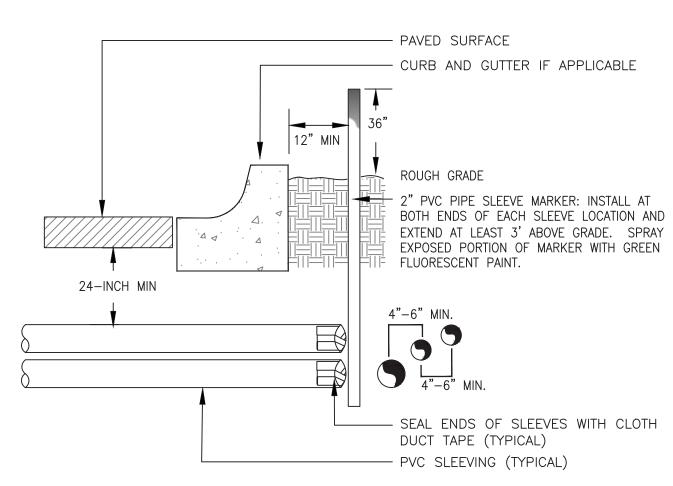


1) ALL SLEEVING TO BE CLASS 200 BE PVC, SIZED AS NOTED. 2) INSTALL SLEEVES IN SIDE-BY-SIDE CONFIGURATION WHERE MULTIPLE SLEEVES ARE TO BE INSTALLED. SPACE SLEEVES 4" TO 6" APART. DO NOT STACK SLEEVES VERTICALLY.

TYPICAL SLEEVING

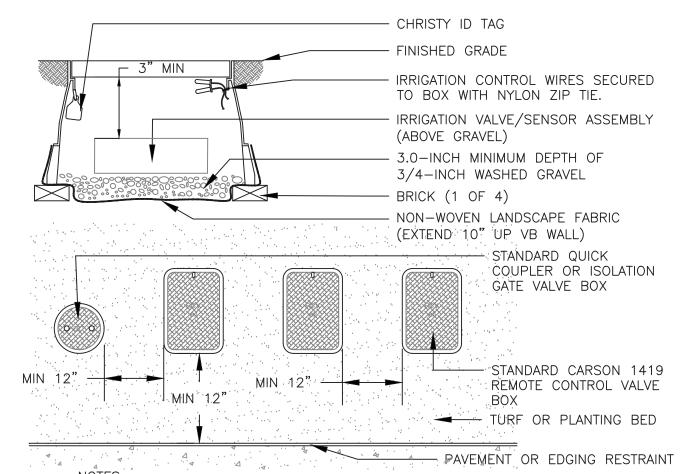

1. INSTALL ONLY ONE RCV TO VALVE BOX. LOCATE AT LEAST 12-INCHES FROM AND ALIGN WITH NEARBY WALLS OR EDGES OF PAVED AREAS. GROUP RCV ASSEMBLIES TOGETHER WHERE PRACTICAL. 4. GROUP RCV ASSEMBLIES TOGETHER WHERE PRACTICAL, BUT AVOID GROUPING MORE THAN THREE (3) STANDARD VALVE BOXES TOGETHER IN A SERIES. 5. ARRANGE GROUPED VALVE BOXES IN RECTANGULAR PATTERNS.

TYPICAL VALVE BOX INSTALLATION

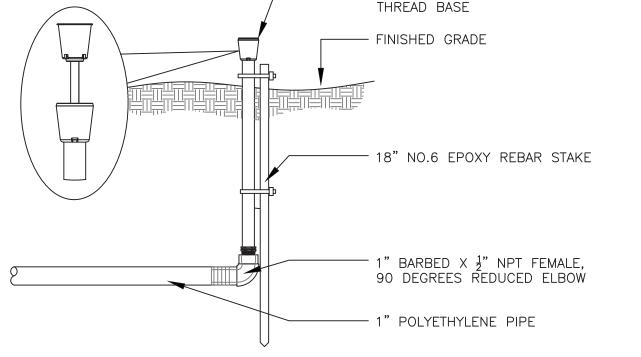

MICRO POPUP INDICATOR ON 3" NPT

DIG MODEL: DSP1-12 12" WITH $\frac{1}{2}$ "MALE

DRIP SYSTEM OPERATION INDICATOR

06-03-2024 3RD SUBMITTAL PROJECT #: 231016

SHEET NUMBER

Denver, Colorado 80203 P: 303.623.6300 F: 303.623.6311 HarrisKocherSmith.com

OWNER: PARK MEADOWS MALL, LLC / PARK MEADOWS ANCHOR ACQUISITION, LLC 8401 PARK MEADOWS CENTER DRIVE LONE TREE, CO 80124

> **AMENDMENT** 8TH Ý-OWS - GARAGE / NO. FILING CENTER PARK TOWN

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DATE | REVISION COMMENTS 03-29-2024 | 1ST SUBMITTAL 05-10-2024 | 2ND SUBMITTAL

MEADOWS

PARK

IR201 -**DETAILS**

Hines Inc

SITE WATER ENGINEERING SERVICES

323 W. DRAKE RD, SUITE 204


Telephone: 970.282.1800

FORT COLLINS, COLORADO 80526

PARK MEADOWS TOWN CENTER FILING NO. 1-A, 8TH AMENDMENT, LOT 4-C-1 PARK MEADOWS PLANNED DEVELOPMENT, 2ND AMENDMENT

PLANNING AREA #1 4.32 ACRES SIP #SP24-0010

8517 PARK MEADOWS CENTER DRIVE

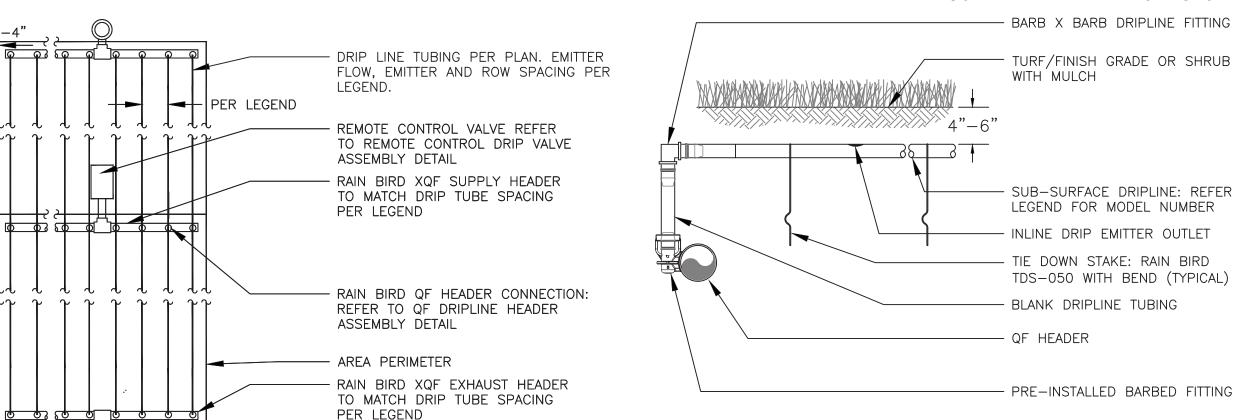

NOTES:

1. INSTALL SYSTEM PER MANUFACTURER'S INSTRUCTIONS AND RECOMMENDATIONS
FOR FOURIER APPLICATION, AND INSTALL ATION

PVC (TYP)

- FLUSH CAP ASSEMBLY PLUMBED TO


- CURB OR PLANTING BED EDGE

FOR EQUIPMENT APPLICATION AND INSTALLATION.

2. MAXIMUM FLOW FOR 1—INCH REMOTE CONTROL VALVE ASSEMBLY IS 14 GPM.

3. INSTALL AT A DEPTH OF 4"-6" IN UNIFORM SOIL.

(12) SUBSURFACE DRIP ASSEMBLY IN SHRUB BEDS

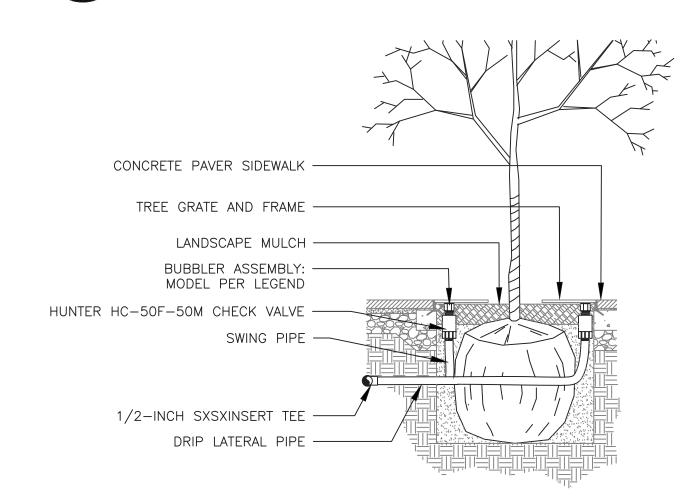

NOTES:
1. REFER TO LANDSCAPE PLANS FOR TREE GRATE INSTALLATION AND DETAILS.

16) BUBBLER ASSEMBLY FOR TREES IN GRATES

NOTES:
1. REFER TO LANDSCAPE PLANS FOR TREE GRATE INSTALLATION AND DETAILS.

1. PLACE TIE-DOWN STAKES EVERY THREE FEED IN SAND, FOUR FEET IN LOAM.

2. AT FITTINGS WHERE THERE IS A CHANGE OF DIRECTION SUCH AS TEES OR

3. INSERTION PLOW AND TRENCHED INSTALLATIONS DO NOT REQUIRE TIE-DOWN

ELBOWS, USE TIE-DOWN STAKES ON EACH LEG OF THE CHANGE OF

QF DRIPLINE HEADER

LANDSCAPE TURF -

LANDSCAPE MULCH

BUBBLER ASSEMBLY:

MODEL PER LEGEND

1/2-INCH SXSXINSERT TEE


DRIP LATERAL PIPE

HUNTER HC-50F-50M CHECK VALVE

AND FIVE FEET IN CLAY.


STAKES.



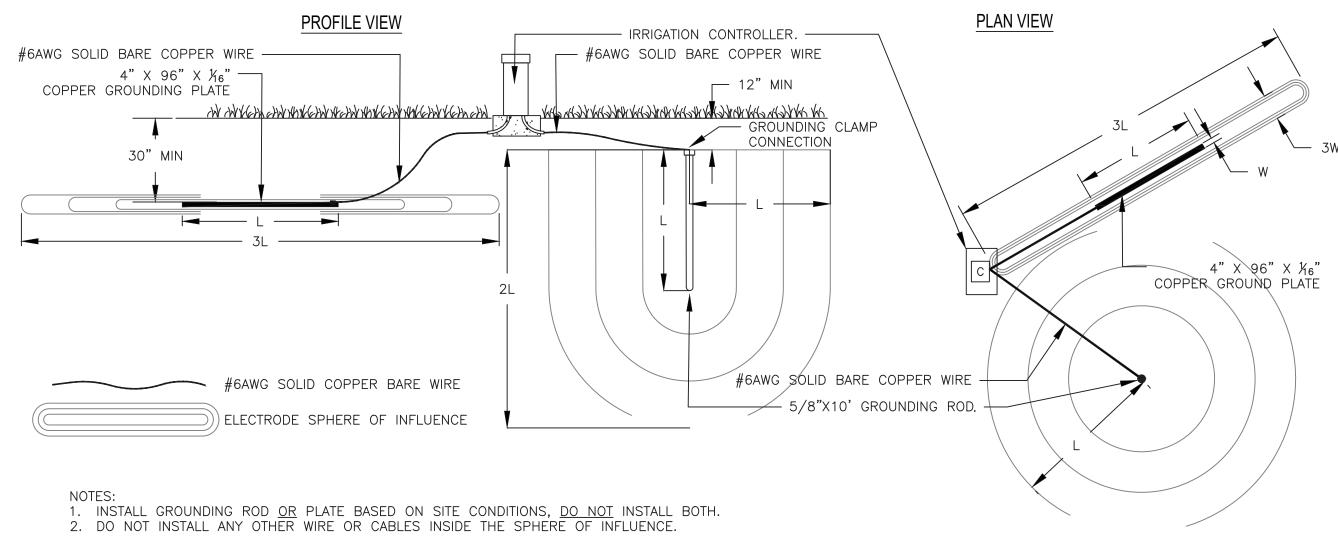


3. INSTALL GROUNDING PLATE AT A MINIMUM OF 30-INCHES BELOW GRADE OR BELOW FROST-LINE, WHICHEVER IS DEEPER.
4. TYPICAL INSTALLATION SHOWN FOR AN IRRIGATION CONTROLLER CAPACITY OF 64 STATIONS OR LESS, INSTALL AN ADDITIONAL GROUNDING ROD/PLATE PER 64 STATIONS.

TYPICAL IRRIGATION CONTROLLER GROUNDING ROD OR PLATE INSTALLATION

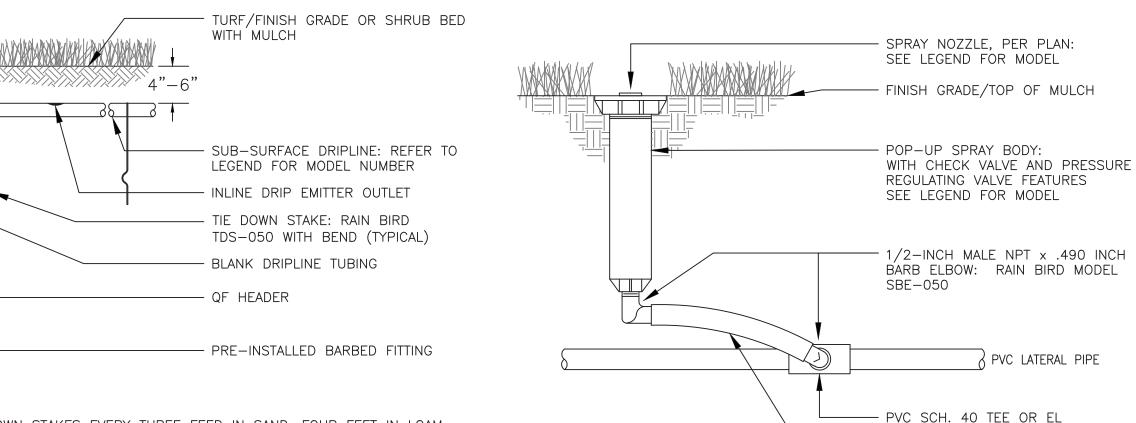

(14) 6-INCH POP UP SPRAY SPRINKLER ASSEMBLY

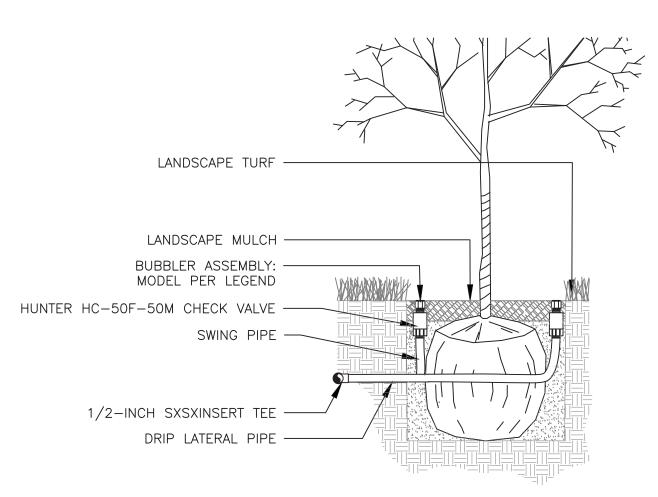


SWING PIPE, 12-INCH LENGTH:

RAIN BIRD SPX-FLEX100


NOTES:
1. REFER TO LANDSCAPE PLANS FOR TREE GRATE INSTALLATION AND DETAILS.

BUBBLER ASSEMBLY FOR

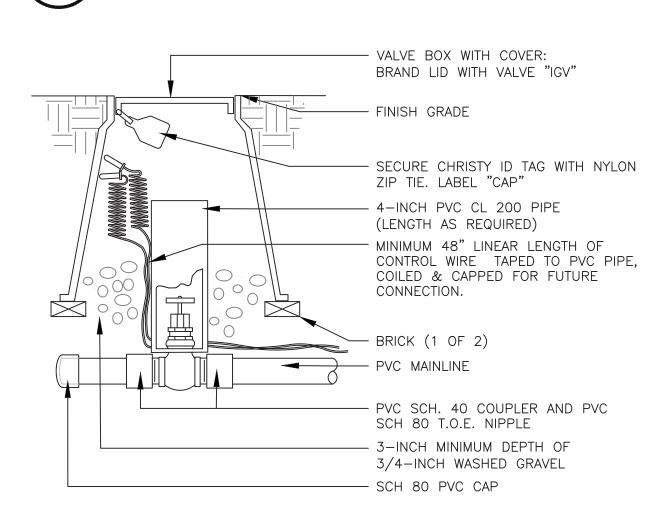

 NOMINAL SIZE OF GATE VALVE TO MATCH NOMINAL MAINLINE SIZE.
 INSTALL SCH 80 PVC CAP A MINIMUM OF 4-INCHES DOWNSTREAM OF ISOLATION GATE VALVE FOR FUTURE INSTALLATION OF SCH 80 PVC COUPLER.

MAINLINE & CONTROL WIRE STUB-OUT (FUTURE CONNECTION)

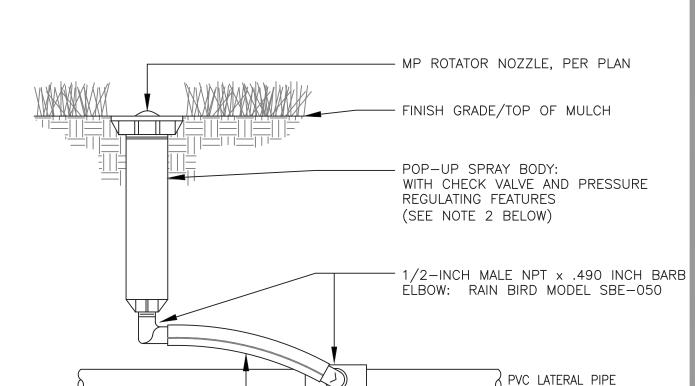

NOTES:

1. IF POLYETHYLENE PIPE IS USED FOR LATERAL PIPE, SUBSTITUTE INSERT TEE OR EL WITH STAINLESS STEEL CLAMPS FOR PVC SLIP TEE OR EL SHOWN ABOVE.


2. TO ACHIEVE MINIMUM RADIUS WITH ANY MP ROTATOR MODEL, USE 30 PSI PRESSURE REGULATING SPRAY BODY.

- PVC SCH. 40 TEE OR EL

RAIN BIRD SPX-FLEX100

SWING PIPE, 12-INCH LENGTH:

(15) 6-INCH POP UP MP-ROTATOR ASSEMBLY

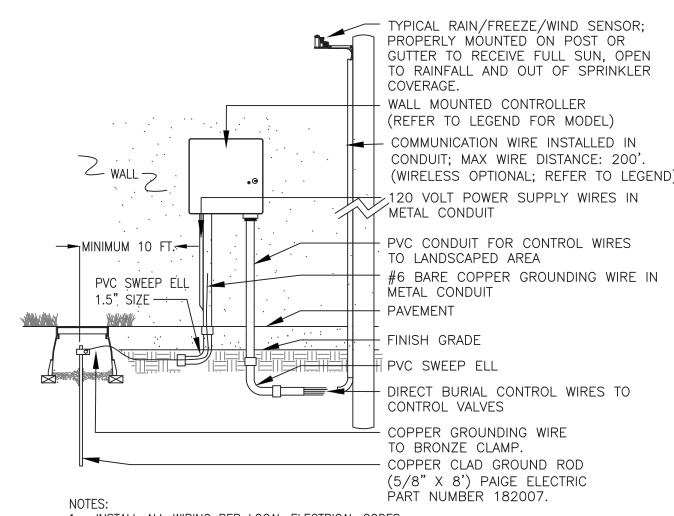

INSTALL ALL WIRING PER LOCAL ELECTRICAL CODES.
 INSTALL GROUND ROD WITHIN IRRIGATED TURF AREA. IF IRRIGATED TURF AREA IS NOT IN CLOSE PROXIMITY TO CONTROLLER, INSTALL ONE (1) DRIP EMITTER FROM NEAREST DRIP VALVE IN VALVE BOX HOUSING GROUNDING ROD.





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OWNER:

PARK MEADOWS MALL, LLC / PARK MEADOWS ANCHOR ACQUISITION, LLC 8401 PARK MEADOWS CENTER DRIVE LONE TREE, CO 80124

PARK MEADOWS TOWN CENTER FILING NO. 1-A, 8TH AMENDMENT, LOT
PARK MEADOWS - GARAGE AND PLAZA
SITE IMPROVEMENT PLAN

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 DATE
 REVISION COMMENTS

 03-29-2024
 1ST SUBMITTAL

 05-10-2024
 2ND SUBMITTAL

 06-03-2024
 3RD SUBMITTAL

PROJECT #: 231016

IR202 -DETAILS

SHEET NUMBER



PARK MEADOWS TOWN CENTER FILING NO. 1-A, 8TH AMENDMENT, LOT 4-C-1 PARK MEADOWS PLANNED DEVELOPMENT, 2ND AMENDMENT PLANNING AREA #1 4.32 ACRES SIP #SP24-0010

8517 PARK MEADOWS CENTER DRIVE

es architecture+ urban design 2040 Addison St, Berkeley, CA 94704 **510.549.2929 | elsarch.com**

GARAGE LUMINARE SCHEDULE

									•
Label	Symbol	Quantity	Image	Manufacturer	Catalog Number	Description	Lamp	Voltage	Wattage
Af	<(\(\)>	169		Eco Parking Technologies	FTEL-100PF-U-40-244D2-H-F-PR	Eco EDGE 100W-II w/ Falcon, Pendant Ready	type II 4000K	120-270 VAC	88.9
Bf		30		Eco Parking Technologies	FTEL-100PF-U-40-146D5-H-F-PR	Eco EDGE 100W-V w/ Falcon, Pendant Ready	type V 4000K	120-270 VAC	90.0
Bw		10		Eco Parking Technologies	FTEL-100PF-U-40-146D5-H-W-PR	Eco EDGE 100W-V w/ Wattstopper, Pendant Ready	type V 4000K	120-270 VAC	90.0
Dw		39		Eco Parking Technologies	FTEL-45PF-U-40-146D5-H-W-PR	Eco EDGE 45W-II w/ Wattstopper, Pendant Ready	type V 4000K	120-270 VAC	43.2
Cf	0	1		Eco Parking Technologies	FALCON STANDALONE CAMERA	Falcon Standalone Camera with Parking Indicator	N/A	120-270 VAC	10.7

SITE LIGHTING SCHEDULE

		UDIO					Designer	ON 05	TREE, CO 5/30/2024 @rl.studio rl.studio
UMINA	AIRE SCHEDULE				ı				
TYPE	MFR	CATALOG NUMBER	FIXTURE DESCRIPTION	LAMP	MTG HEIGHT	LOAD / DIM TYPE	WATT	UNIT	VOLT
LD1	ANP	OSSD24-MO10LDD-W-30K-2ST18-CBC- 100GLPRGUP-FINISH	24" LED Dome Pendant with 18" Stem Rod Mount, 1250 LUMENS, Cast Round Cover Plate, Prismatic Glass and Small Wire Guard ARCH TO VERIFY FINISH	Integral 3000k LED	Surface, Ceiling (18" STEM)	0-10V / ELV	10	EA	120 / 277V
LD2	Kuzco Lighting	AT7972-BK	72" Linear Indirect Sconce, 7200 Lumens, 90 CRI, Black Finish	Integral 3000k LED	Surface Wall	ELV	88	EA	120V
LL1	Environmental Lights	wp-3000K-CL-10-5m CS116-2m EL-CLIP-78 EL-CAP-160-H / EL-CAP-160	Wet Rated High Efficacy Continuous Line LED Tape with Metal Extrusion and Frosted Lens, Metal Mounting Clips and End Caps	Integral 3000k LED	Surface / Millwork	0-10V / ELV / MLV	5	FT	24V
LL1 (XFMR)	Environmental Lights	UNV-24-96	Universal Dimming Driver Available in 60, 96, 2x96, 3x96 watt options	N/A	Surface / Millwork	0-10V / ELV / MLV	96	EA	24V / 120V
LL2	Environmental Lights	FDS-D-5m FDS-SI wp-3000K-2835PL-128-10-5m	Wet Rated LED Tape with Dome Top Flexible Diffusing Sleeve and Silicone Channel	Integral 3000k LED	Surface / Millwork	0-10V / ELV / MLV	3	FT	24V
LL2 (XFMR)	Environmental Lights	UNV-24-96	Universal Dimming Driver Available in 60, 96, 2x96, 3x96 watt options	N/A	Surface / Millwork	0-10V / ELV / MLV	96	EA	24V / 120V
LL3	Coronet	LS WET-X'-30-HIGH-UNV-DB-FINISH-WM-SD- NA-NA-CAN-X	Wall Mounted Wet Rated LED luminaire with High Lumen output (844 lumens/ft), Continuous Run, 90 CRI, Standard Diffuser, FINISH PER ARCHITECT	Integral 3000k LED	Surface / Wall	0-10V	10	FT	120V / 277V
LR1	WE-EF	134-6102-FINISH DOC110 LED	4.5" Round Downlight, Medium Beam Spread, 80 CRI ARCH TO VERIFY FINISH	Integral 3000k LED	Recessed, Ceiling	0-10V	15	EA	120 / 277V
LS1a LS1b	LSI Industries LSI Industries	OMITTED OMITTED							
LS2	Coronet	LS1 -6-30-HIGH-UNV-DB-FINISH-AC-FL- WISM-WISD-STD	6' Pendant Mount Linear Strip, High Output 800 LUMENS/FT, Flat Diffuser, Wattstopper Occupancy and Daylight Sensors ARCH TO VERIFY FINISH	Integral 3000k LED	Ceiling Pendant / AC Cable	0-10V	60	EA	120 / 277V
LS3	Coronet	LS1 UPDN-6-30-MED-MED-UNV-DB-FINISH- WM-FL-FL-WISM-WISD	6' Wall Mounted Linear Strip with Up/Down Optics, Medium Output 600 LUMENS/FT, Flat Diffuser, Wattstopper Occupancy and Daylight Sensors ARCH TO VERIFY FINISH	Integral 3000k LED	Surface, Ceiling	0-10V	84	EA	120 / 277V
LS5a	LSI Industries	XDLM-A-FT-LED-VHO-WW-UE-FINISH-SA5-S IMSBT1-IL	Lifestyle Medium Angled Outdoor Decorative Area Light, 25000 LUMENS, Forward Throw Optic, Integral Louver Shield, integral Motion and Photocell Sensor ARCH / EE TO ADVISE POLE REQUIREMENTS ARCH TO VERIFY FINISH	Integral 3000k LED	20' AFF Pole Mount	MOTION / PHOTOCE LL	196	EA	120 / 277V
LS6	Contech	SQL3T-3-30K-12D1-D-X-F-FINISH	3.5" Square Wall Mounted Downlight with DOWN ONLY output, 36° Flood, 1800 Im Output ARCH TO VERIFY FINISH	Integral 3000k LED	Canopy Side Mount	0-10V	20	EA	120V
LS7	WE-EF	FLC220 LED 139-2001 147-0544 139-1987	CONTRACTOR TO VERIFY POLE SIZE Pole Mounted LED Adjustable Accent Light with Medium Beam, 1533 Lumens, Pole Clamp (exact width tbd) SNOOT FOR DARK SKY ARCH TO VERIFY FINISH	Integral 3000k LED	Pole Mount	PHOTOCE LL	14.5	EA	120 / 277V
LS8a	WE-EF	ZFT430-FT-LED-115-1860 159-0321 693-9320 / AMW-Z-20-MA	Pole Mounted LED Street Lighter with S65 Streetlighting Distribution, 6145 Lumens, + LIGHT SHIELD FOR DARK SKY 20' WOOD POLE ARCH TO VERIFY FINISH	Integral 3000k LED	20' AFF Pole Mount	PHOTOCE LL	42	EA	120 / 277V
LS8b	WE-EF	LTM440 LED-FT 115-1565 159-0321	Pole Mounted LED Path Lighter withType V Short (C50) Distribution, 5171 Lumens, + LIGHT SHIELD FOR DARK SKY 157" Pole Included ARCH TO VERIFY FINISH	Integral 3000k LED	13' AFF Pole Mount	PHOTOCE LL	42	EA	120 / 277V
LS9a	Contech	CY3S-3-30K-12D1-C-X-WW-P	Outdoor rated Ceiling Mounted Cylinder with Wallwash Optic, 1800 LM ARCH TO VERIFY MATTE WHITE FINISH	Integral 3000k LED	Ceiling Surface Mount	TRIAC / ELV	20	EA	120 / 277V
LS9b	Contech	CY3S-3-30K-12D1-C-X-WF-P	Outdoor rated Celling Mounted Cylinder with Wide Flood Optic, 1800 LM ARCH TO VERIFY MATTE WHITE FINISH	Integral 3000k LED	Ceiling Surface Mount	TRIAC / ELV	20	EA	120 / 277V
LS10	Lumenpulse	LBG-VOLTS-30K-NF-WF-LSLV-FINISH-DIM- SY-UL-	Wall mounted LED luminaire with Hi Lumen output (12k), with dual optics at 20° and 30° for maximum coverage.	Integral 3000k LED	Ceiling Surface Mount	0-10V	100	EA	120 / 277V
LS11	Ecosense	F080-2H-HO-30-8-40-FINISH-F-B	Surface Mounted Double Head Adjustable Accent Light, 40° Flood Optic, 80 CRI, High Output, Full Snoot, 10' External Cable, Side Exit, Surface Mount, UL Listed	Integral 3000k LED	Ceiling Surface Mount	0-10V	23	EA	120 / 277V
LX1	American Lighting	LS2-M-24-48-BK	Wire Interconnectable String Lights; Medium Base; 48ft; 24 Sockets; Black Patio Lighting lamps, box of 25 2700K Warm White	PS14-E26- WW	String Light	ELV	34	EA	120V
LX2	WAC Lighting	5011-30-BZ 5010-SNOOT-BZ	Adjustable LED landscape light with locakable adjustable beam angle, Integral Dimmer, Glare reduction Snoot Mounting stake, 6' lead wire and direct burial gel filled wire nuts	Integral 3000k LED	Ground Stake Mount	MLV	18	EA	12V
LX2 XFMR	WAC Lighting	9075-TRN-SS	TRANSFORMER AVAILABLE IN 75, 150, 300, AND 600 WATT, EE TO VERIFY WATTAGE REQUIRED Stainless Steel, 12-15V output, IP65 rated, UL 1838 listed See transformer spec sheet for details and its accessories	n/a	Surface	MLV	75	EA	120V
LX3	1800BOLLARDS	I LUM LED BZ CL 12L C A BP	LIGHT COLOR TBD - RGB IF AVAILABLE Heavy Duty Aluminum Bollard with triple light beam effect	Integral LED COLOR TBD	Surface	ELV	32	EA	120 / 277V
LX4	Cooledge	TILE-EXT-900-30-R3 TACC-EXT-CUT-900-30-R3 TCBL-SCT-T4/T10 TACC-EXT-SCT-STR	FINAL FIXTURE SIZE TO BE DETERMINED PER MILLWORK SHOP DRAWINGS. FIXTURES SHALL BE INSTALLED IN 4" RECESS CAVITY BEHIND P95 MATTE CLEAR ACRYLIC (OR SIMILAR). Configurable Exterior Rated Light Tiles, available in Field Cuttable and connectable sheets, nominally 23.5" x 11.8". Total dimensions to equal approx. 4'x4' square (per millwork)	Integral 3000k LED	Surface	0-10V	100	EA	120V
LX5	EXISTING - QUALITY LIGHTING CO	CL-124(MOD. ADJ. SKT.)-VS-1000MH- CL80-480-FDD-CC-RE ON A 37'-0" HIGH POLE, VALMONT DS2109.0E370-P2-CC (7 GUAGE)	EXISTING TO BE RELOCATED 27" Square x 15" Deep Aluminum Housing, Sharp Cut-off, Type Vertical Square (VS) distribution (80° Cut Off)	(3) 1000 WATT METAL HALID	37' Pole Mounted	ND	3300	EA	480V
LX6	EXISTING - QUALITY LIGHTING CO	CL-127(MOD. ADJ. SKT.)-VS-1000MH- CL80-480-FDD-CC-RE ON A 37'-0" HIGH POLE, VALMONT DS2109.0E370-P2-CC (7 GUAGE)	EXISTING TO BE RELOCATED 27" Square x 15" Deep Aluminum Housing, Sharp Cut-off, Type Vertical Square (VS) distribution (80° Cut Off)	(4) 1000 Watt Metal Halid	37' Pole Mounted	ND	4400	EA	480V

OWNER:

PARK MEADOWS MALL, LLC / PARK MEADOWS ANCHOR ACQUISITION, LLC 8401 PARK MEADOWS CENTER DRIVE LONE TREE, CO 80124

> FILING NO. 1-A, 8TH AMENDMENT, LOT 4-C-1 PARK MEADOWS - GARAGE AND PLAZA SITE IMPROVEMENT PLAN PARK MEADOWS TOWN CENTER

	REVISION COMMENTS
DATE	Sheet
03-29-2024	1ST SUBMITTAL
05-10-2024	2ND SUBMITTAL

PROJECT #: 2022-27


LIGHTING SCHEDULE


Sheet Number 28 of 54

PARK MEADOWS TOWN CENTER FILING NO. 1-A, 8TH AMENDMENT, LOT 4-C-1 PARK MEADOWS PLANNED DEVELOPMENT, 2ND AMENDMENT PLANNING AREA #1 4.32 ACRES SIP #SP24-0010

8517 PARK MEADOWS CENTER DRIVE



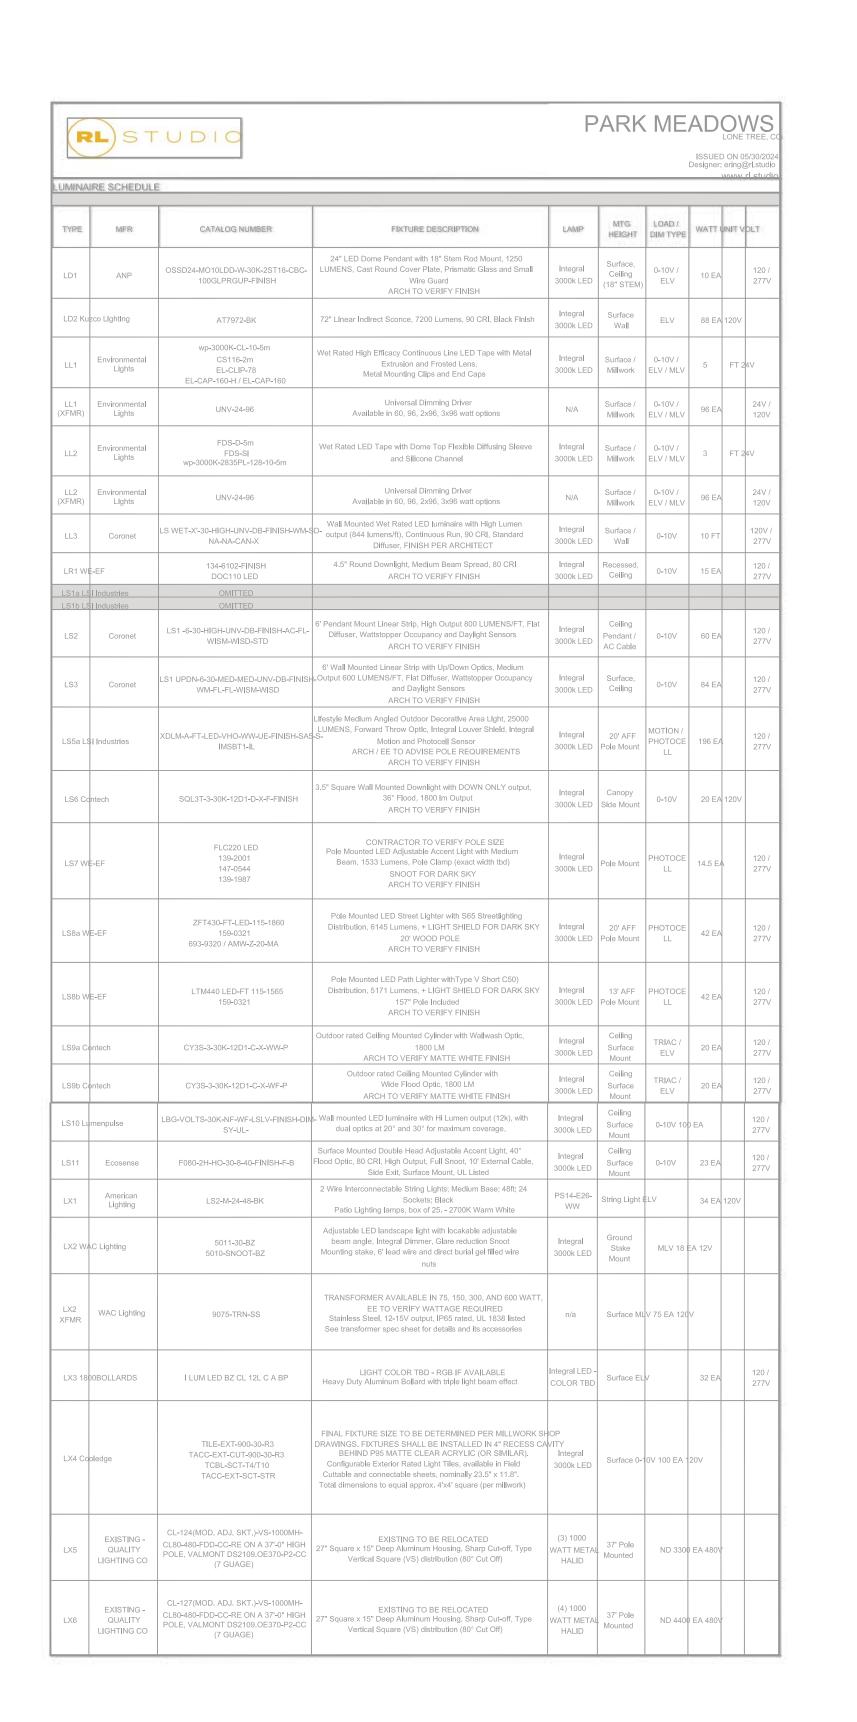

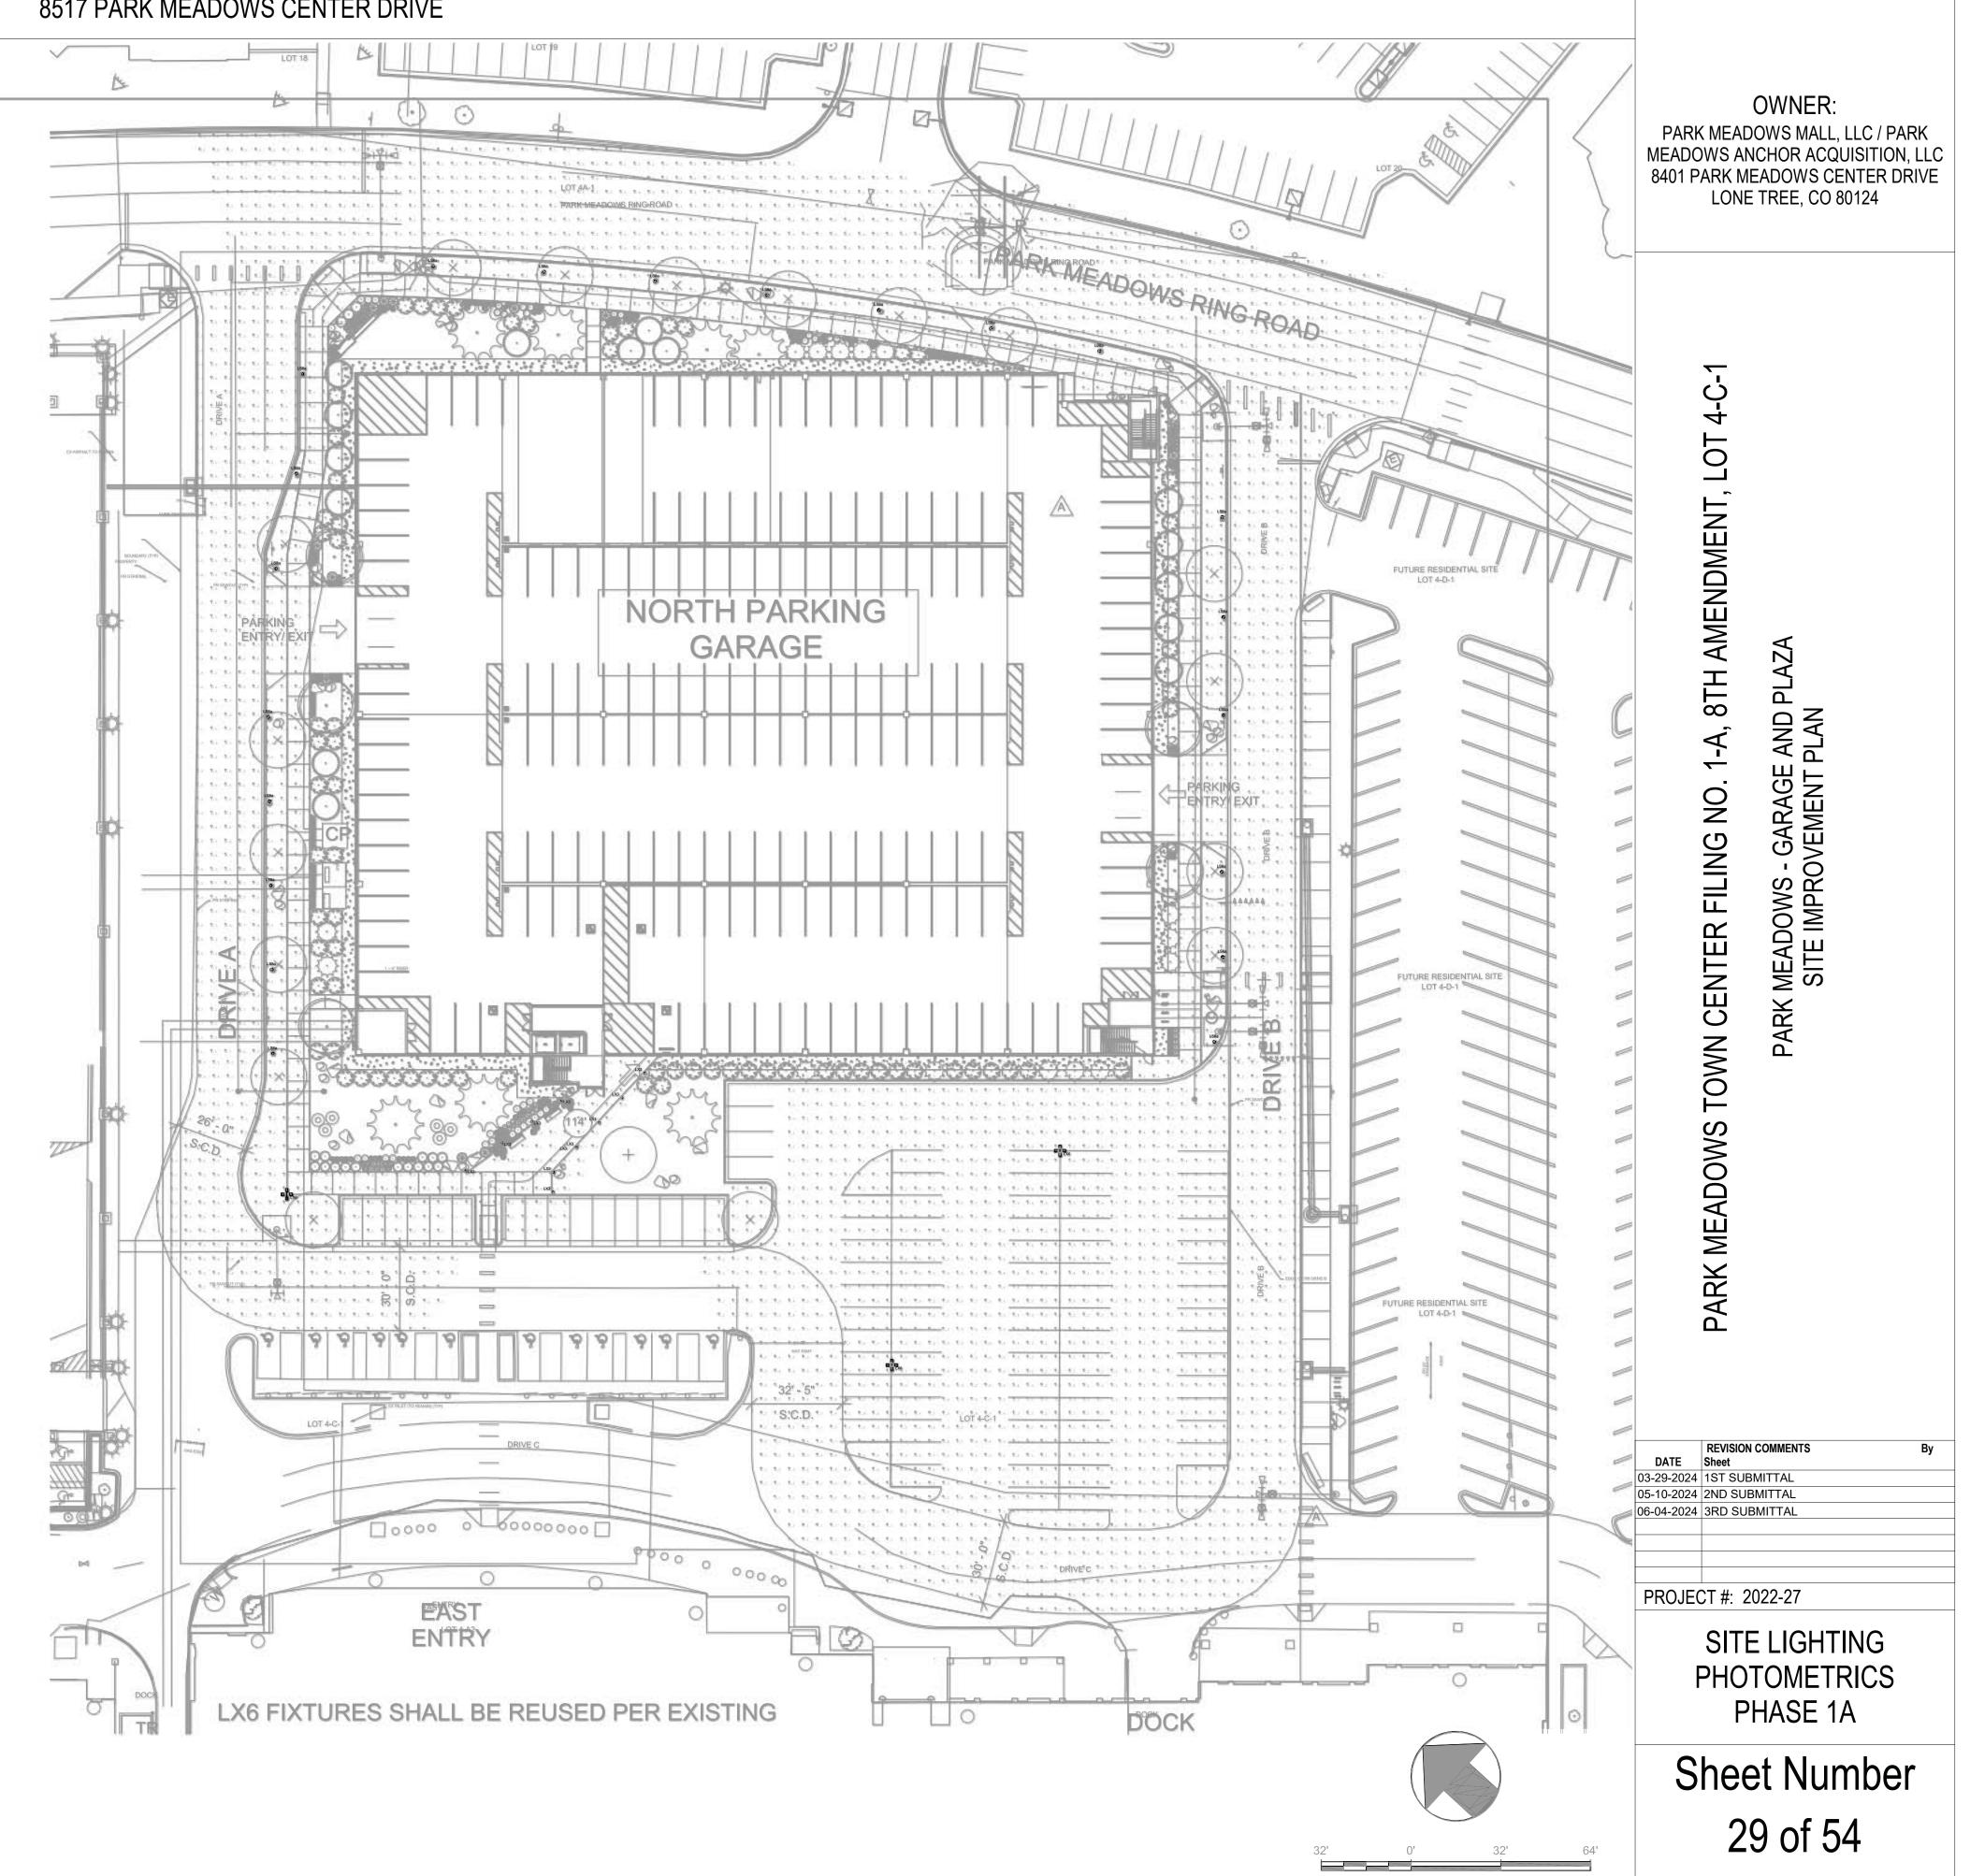


SCALE: 1/32" = 1' - 0"

PARK MEADOWS TOWN CENTER FILING NO. 1-A, 8TH AMENDMENT, LOT 4-C, 4-D, 4-E, & 21-A PARK MEADOWS PLANNED DEVELOPMENT, 2ND AMENDMENT PLANNING AREA #1 23.61 ACRES SIP #SP24-0010

F	ST	UDIO		۲	PARK		ISSUE Designer	LONE D ON 0	TRE 05/30 @rl.s
_UMINA	IRE SCHEDULE				I	I			
TYPE	MFR	CATALOG NUMBER	FIXTURE DESCRIPTION	LAMP	MTG HEIGHT	LOAD / DIM TYPE	WATT	UNIT V	OLT
LD1	ANP	OSSD24-MO10LDD-W-30K-2ST18-CBC- 100GLPRGUP-FINISH	24" LED Dome Pendant with 18" Stem Rod Mount, 1250 LUMENS, Cast Round Cover Plate, Prismatic Glass and Small Wire Guard ARCH TO VERIFY FINISH	Integral 3000k LED	Surface, Ceiling (18" STEM)	0-10V / ELV	10 EA		120 277
LD2 Ku	zco Lighting	AT7972-BK	72" Linear Indirect Sconce, 7200 Lumens, 90 CRI, Black Finish	Integral 3000k LED	Surface Wall	ELV	88 E <i>F</i>	120V	
LL1	Environmental Lights	wp-3000K-CL-10-5m CS116-2m EL-CLIP-78 EL-CAP-160-H / EL-CAP-160	Wet Rated High Efficacy Continuous Line LED Tape with Metal Extrusion and Frosted Lens, Metal Mounting Clips and End Caps	Integral 3000k LED	Surface / Millwork	0-10V / ELV / MLV	5	FT 2	24V
LL1 (XFMR)	Environmental Lights	UNV-24-96	Universal Dimming Driver Available in 60, 96, 2x96, 3x96 watt options	N/A	Surface / Millwork	0-10V / ELV / MLV	96 E <i>A</i>		24V 120
LL2	Environmental Lights	FDS-D-5m FDS-SI wp-3000K-2835PL-128-10-5m	Wet Rated LED Tape with Dome Top Flexible Diffusing Sleeve and Silicone Channel	Integral 3000k LED	Surface / Millwork	0-10V / ELV / MLV	3	FT 2	24V
LL2 (XFMR)	Environmental Lights	UNV-24-96	Universal Dimming Driver Available in 60, 96, 2x96, 3x96 watt options	N/A	Surface / Millwork	0-10V / ELV / MLV	96 E <i>A</i>		24V 120
LL3	Coronet	LS WET-X'-30-HIGH-UNV-DB-FINISH-WM- NA-NA-CAN-X	Wall Mounted Wet Rated LED luminaire with High Lumen 3D- output (844 lumens/ft), Continuous Run, 90 CRI, Standard Diffuser, FINISH PER ARCHITECT	Integral 3000k LED	Surface / Wall	0-10V	10 FT		120\ 277
LR1 W	E-EF	134-6102-FINISH DOC110 LED	4.5" Round Downlight, Medium Beam Spread, 80 CRI ARCH TO VERIFY FINISH	Integral 3000k LED	Recessed, Ceiling	0-10V	15 EA		120 277
	SI Industries Coronet	OMITTED LS1 -6-30-HIGH-UNV-DB-FINISH-AC-FL- WISM-WISD-STD	6' Pendant Mount Linear Strip, High Output 800 LUMENS/FT, Flat Diffuser, Wattstopper Occupancy and Daylight Sensors	Integral 3000k LED	Ceiling Pendant /	0-10V	60 EA		120
LS3	Coronet	LS1 UPDN-6-30-MED-MED-UNV-DB-FINISI	6' Wall Mounted Linear Strip with Up/Down Optics, Medium -Output 600 LUMENS/FT, Flat Diffuser, Wattstopper Occupancy	Integral	AC Cable Surface,	0-10V	84 E <i>A</i>		120
	Colonet	WM-FL-FL-WISM-WISD	and Daylight Sensors ARCH TO VERIFY FINISH Lifestyle Medium Angled Outdoor Decorative Area Light, 25000 LUMENS, Forward Throw Optic, Integral Louver Shield, integral	3000k LED	Ceiling		04 LF		277
LS5a L	SI Industries	XDLM-A-FT-LED-VHO-WW-UE-FINISH-SA: IMSBT1-IL	S- Motion and Photocell Sensor ARCH / EE TO ADVISE POLE REQUIREMENTS ARCH TO VERIFY FINISH	Integral 3000k LED	20' AFF Pole Mount	MOTION / PHOTOCE LL	196 E/	۵.	120 277
LS6 Co	ontech	SQL3T-3-30K-12D1-D-X-F-FINISH	3.5" Square Wall Mounted Downlight with DOWN ONLY output, 36° Flood, 1800 Im Output ARCH TO VERIFY FINISH	Integral 3000k LED	Canopy Side Mount	0-10V	20 E <i>F</i>	A 120V	
LS7 W	E-EF	FLC220 LED 139-2001 147-0544 139-1987	CONTRACTOR TO VERIFY POLE SIZE Pole Mounted LED Adjustable Accent Light with Medium Beam, 1533 Lumens, Pole Clamp (exact width tbd) SNOOT FOR DARK SKY ARCH TO VERIFY FINISH	Integral 3000k LED	Pole Mount	PHOTOCE LL	14.5 E.	A	120 277
LS8a W	/E-EF	ZFT430-FT-LED-115-1860 159-0321 693-9320 / AMW-Z-20-MA	Pole Mounted LED Street Lighter with S65 Streetlighting Distribution, 6145 Lumens, + LIGHT SHIELD FOR DARK SKY 20' WOOD POLE ARCH TO VERIFY FINISH	Integral 3000k LED	20' AFF Pole Mount	PHOTOCE LL	42 E <i>F</i>	4	120 277
LS8b W	/E-EF	LTM440 LED-FT 115-1565 159-0321	Pole Mounted LED Path Lighter withType V Short C50) Distribution, 5171 Lumens, + LIGHT SHIELD FOR DARK SKY 157" Pole Included ARCH TO VERIFY FINISH	Integral 3000k LED	13' AFF Pole Mount	PHOTOCE LL	42 E/	Ą	120 277
LS9a C	ontech	CY3S-3-30K-12D1-C-X-WW-P	Outdoor rated Ceiling Mounted Cylinder with Wallwash Optic, 1800 LM ARCH TO VERIFY MATTE WHITE FINISH	Integral 3000k LED	Ceiling Surface Mount	TRIAC / ELV	20 EA	1	120 277
LS9b C	ontech	CY3S-3-30K-12D1-C-X-WF-P	Outdoor rated Ceiling Mounted Cylinder with Wide Flood Optic, 1800 LM ARCH TO VERIFY MATTE WHITE FINISH	Integral 3000k LED	Ceiling Surface Mount	TRIAC / ELV	20 E <i>F</i>	1	120 277
LS10 Li	umenpulse	LBG-VOLTS-30K-NF-WF-LSLV-FINISH-DIN SY-UL-	⊩ Wall mounted LED luminaire with Hi Lumen output (12k), with dual optics at 20° and 30° for maximum coverage.	Integral 3000k LED	Ceiling Surface Mount	0-10V 10	0 EA		120 277
LS11	Ecosense	F080-2H-HO-30-8-40-FINISH-F-B	Surface Mounted Double Head Adjustable Accent Light, 40° Flood Optic, 80 CRI, High Output, Full Snoot, 10' External Cable, Side Exit, Surface Mount, UL Listed	Integral 3000k LED	Ceiling Surface Mount	0-10V	23 EA		120 277
LX1	American Lighting	LS2-M-24-48-BK	2 Wire Interconnectable String Lights; Medium Base; 48ft; 24 Sockets; Black Patio Lighting lamps, box of 25 2700K Warm White	PS14-E26- WW	String Light I	ELV	34 EA	120V	
LX2 W	AC Lighting	5011-30-BZ 5010-SNOOT-BZ	Adjustable LED landscape light with locakable adjustable beam angle, Integral Dimmer, Glare reduction Snoot Mounting stake, 6' lead wire and direct burial gel filled wire nuts	Integral 3000k LED	Ground Stake Mount	MLV 18	EA 12V		
LX2 XFMR	WAC Lighting	9075-TRN-SS	TRANSFORMER AVAILABLE IN 75, 150, 300, AND 600 WATT, EE TO VERIFY WATTAGE REQUIRED Stainless Steel, 12-15V output, IP65 rated, UL 1838 listed See transformer spec sheet for details and its accessories	n/a	Surface MI	V 75 EA 120	5V		
LX3 18	00BOLLARDS	I LUM LED BZ CL 12L C A BP	LIGHT COLOR TBD - RGB IF AVAILABLE Heavy Duty Aluminum Bollard with triple light beam effect	Integral LED - COLOR TBD	Surface EL	V	32 EA		120 277
LX4 Co	oledge	TILE-EXT-900-30-R3 TACC-EXT-CUT-900-30-R3 TCBL-SCT-T4/T10 TACC-EXT-SCT-STR	FINAL FIXTURE SIZE TO BE DETERMINED PER MILLWORK SI DRAWINGS. FIXTURES SHALL BE INSTALLED IN 4" RECESS CA BEHIND P95 MATTE CLEAR ACRYLIC (OR SIMILAR). Configurable Exterior Rated Light Tiles, available in Field Cuttable and connectable sheets, nominally 23.5" x 11.8". Total dimensions to equal approx. 4'x4' square (per millwork)	1	Surface 0-	0V 100 EA	120V		
LX5	EXISTING - QUALITY LIGHTING CO	CL-124(MOD. ADJ. SKT.)-VS-1000MH- CL80-480-FDD-CC-RE ON A 37'-0" HIGH POLE, VALMONT DS2109.0E370-P2-CC (7 GUAGE)	EXISTING TO BE RELOCATED 27" Square x 15" Deep Aluminum Housing, Sharp Cut-off, Type Vertical Square (VS) distribution (80° Cut Off)	(3) 1000 WATT META HALID	37' Pole Mounted	ND 330	0 EA 480\	V	
LX6	EXISTING - QUALITY LIGHTING CO	CL-127(MOD. ADJ. SKT.)-VS-1000MH- CL80-480-FDD-CC-RE ON A 37'-0" HIGH POLE, VALMONT DS2109.0E370-P2-CC (7 GUAGE)	EXISTING TO BE RELOCATED 27" Square x 15" Deep Aluminum Housing, Sharp Cut-off, Type Vertical Square (VS) distribution (80° Cut Off)	(4) 1000 WATT META HALID	37' Pole Mounted	ND 440	0 EA 480\	V	

1 ARCHITECTURAL SITE PLAN - PHASE 1B - OVERALL LEVEL 1

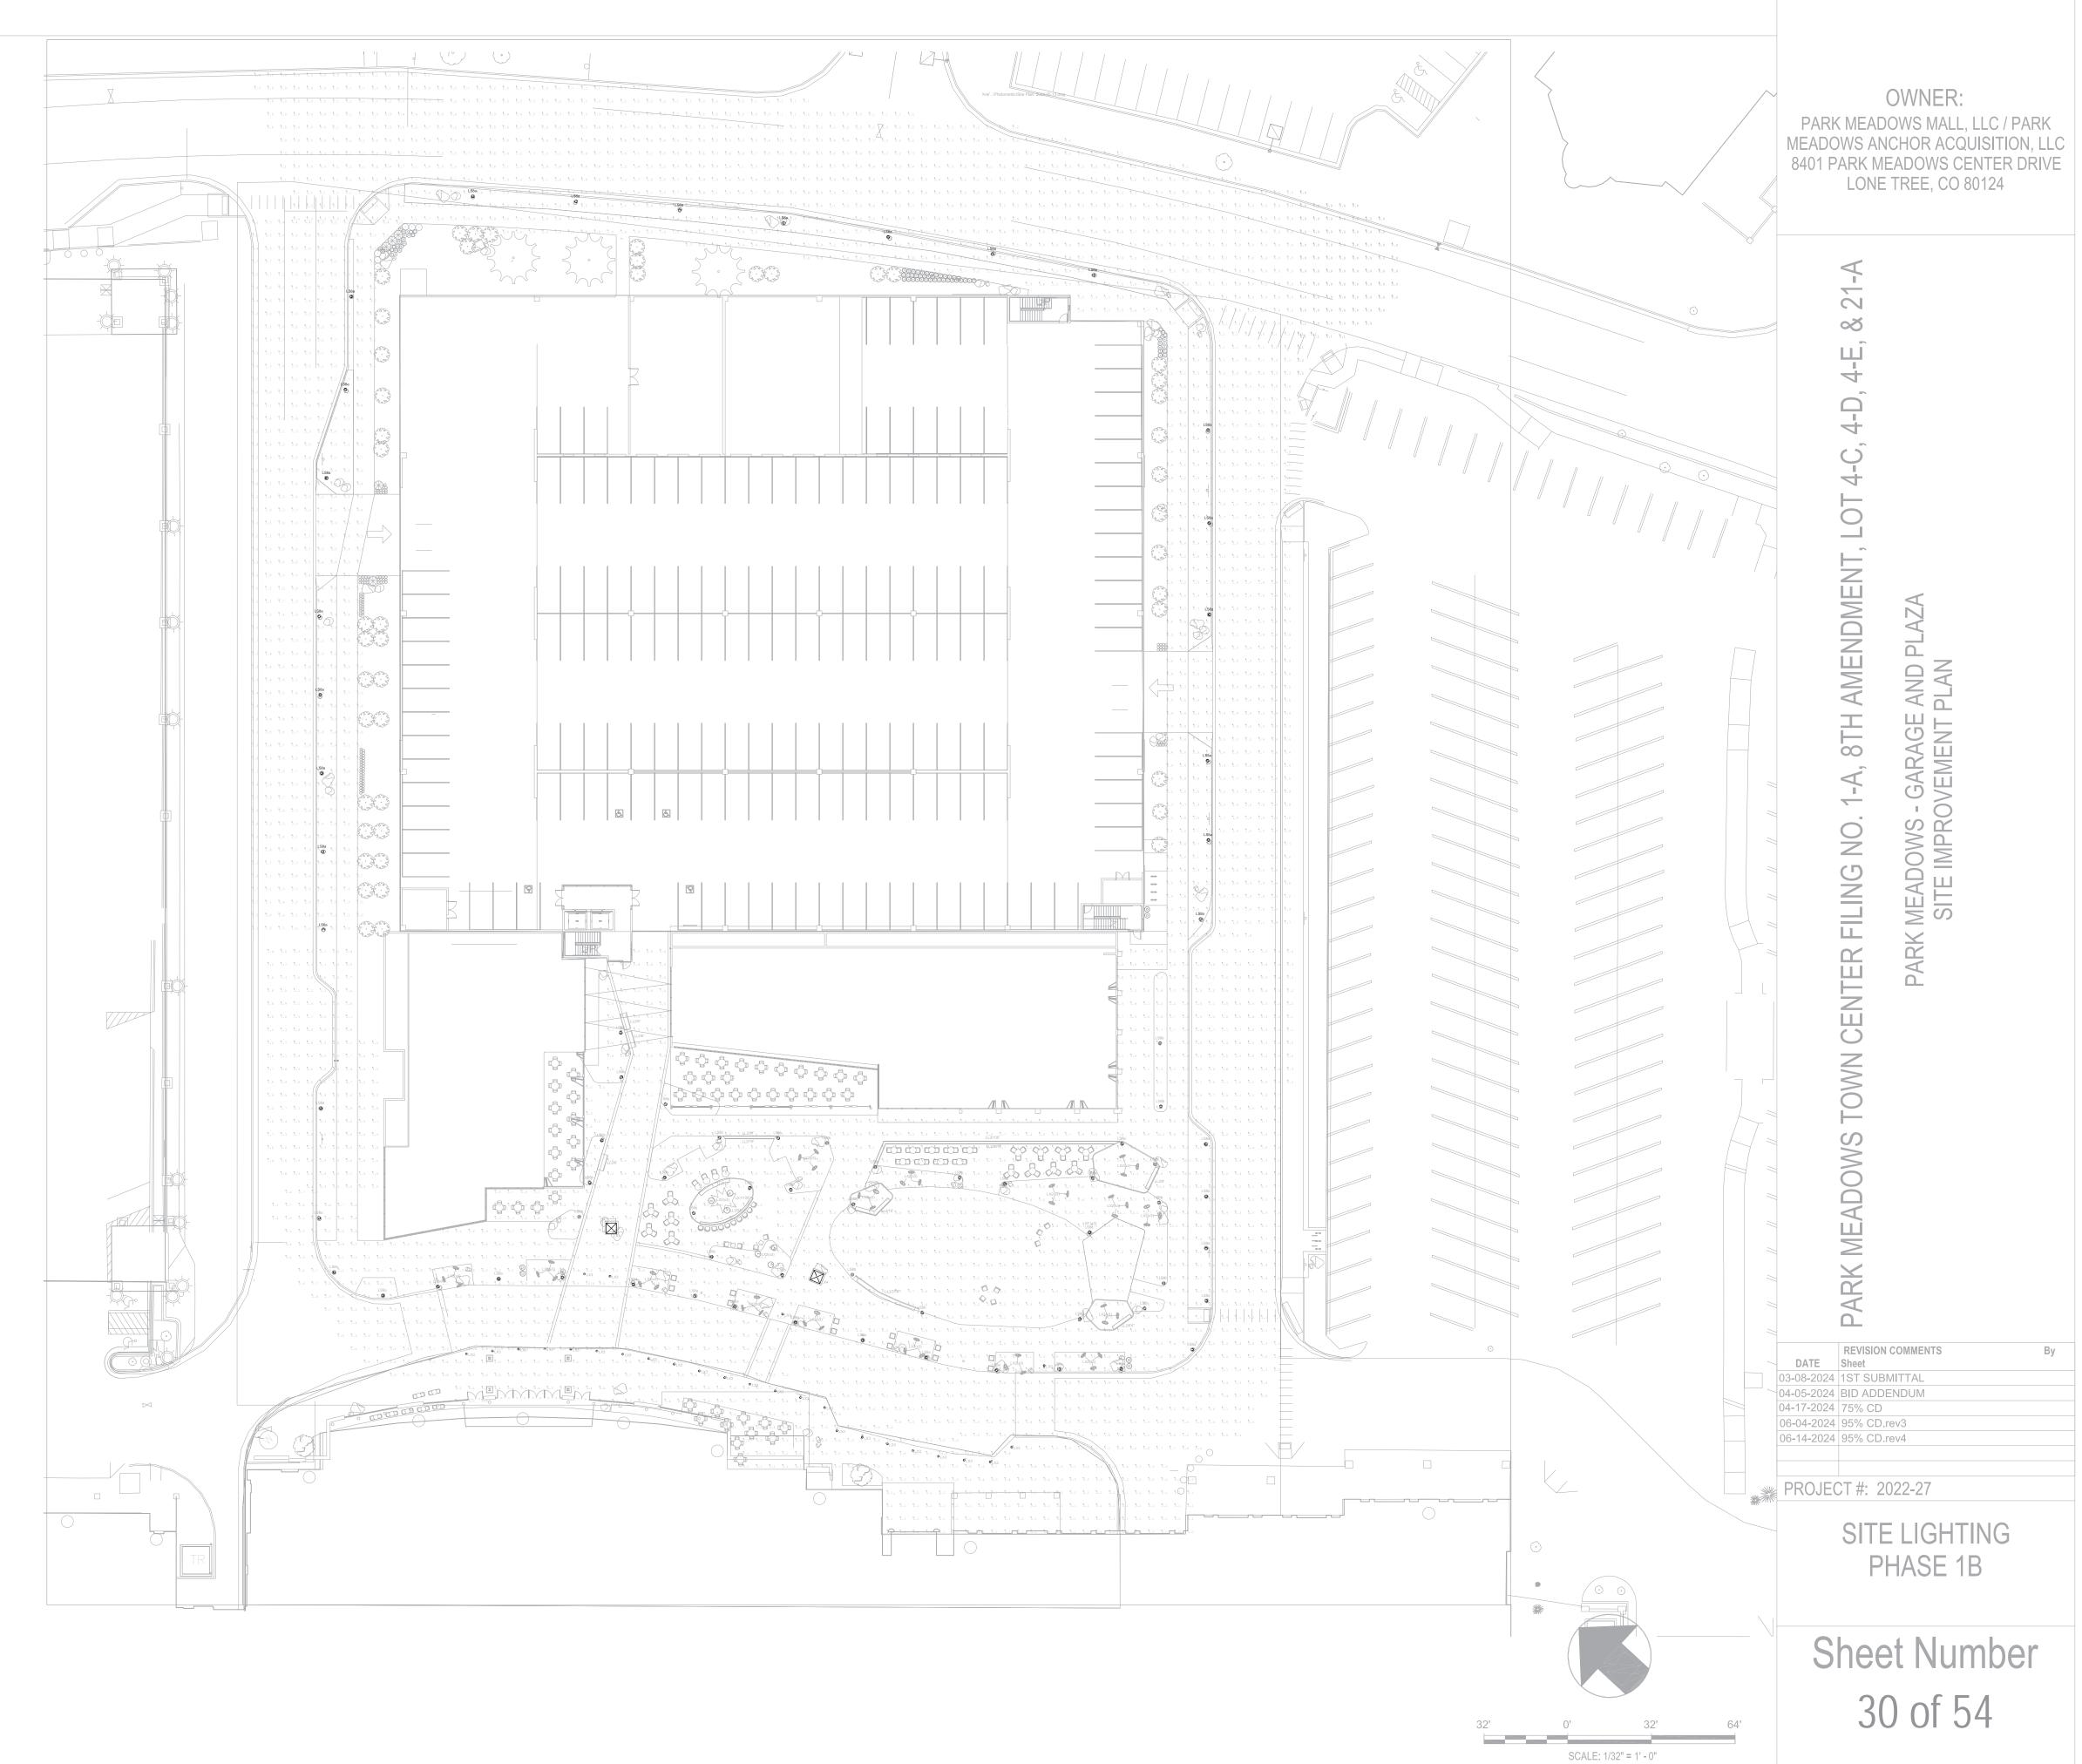


PARK MEADOWS TOWN CENTER FILING NO. 1-A, 8TH AMENDMENT, LOT 4-C-1 PARK MEADOWS PLANNED DEVELOPMENT, 2ND AMENDMENT PLANNING AREA #1 4.32 ACRES

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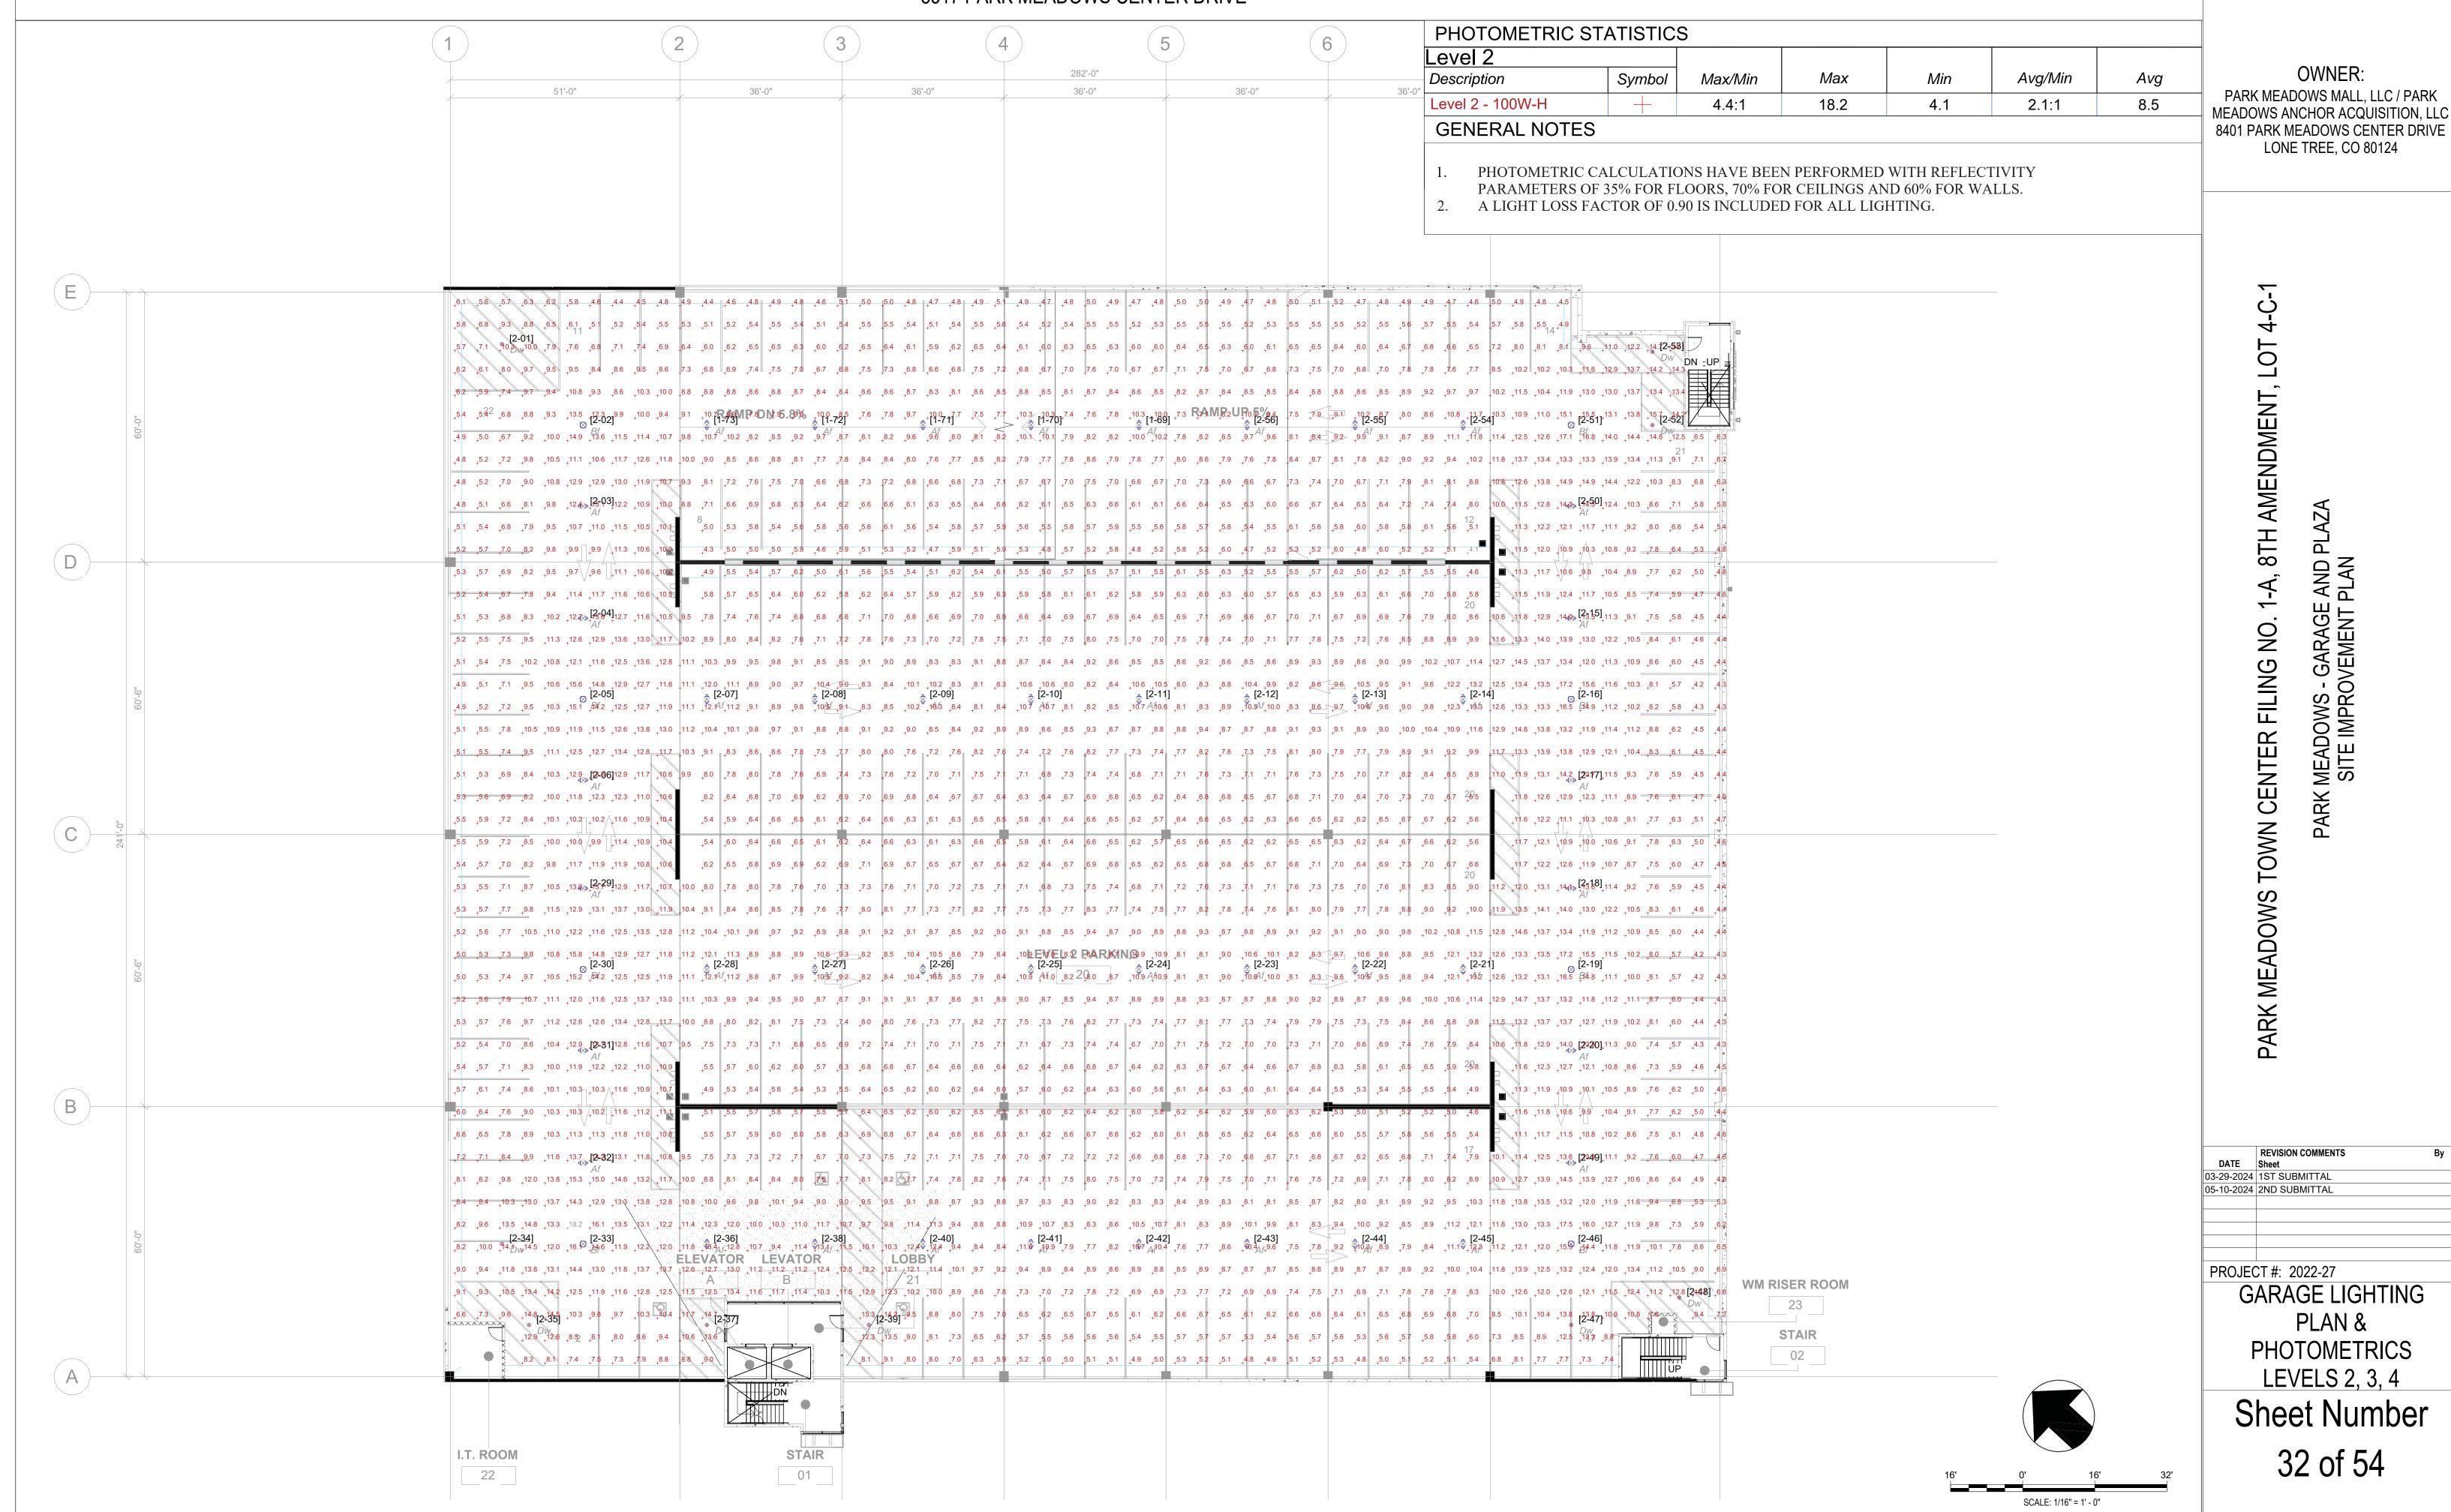


PARK MEADOWS TOWN CENTER FILING NO. 1-A, 8TH AMENDMENT, LOT 4-C-1 PARK MEADOWS PLANNED DEVELOPMENT, 2ND AMENDMENT

PLANNING AREA #1 4.32 ACRES SIP #SP24-0010

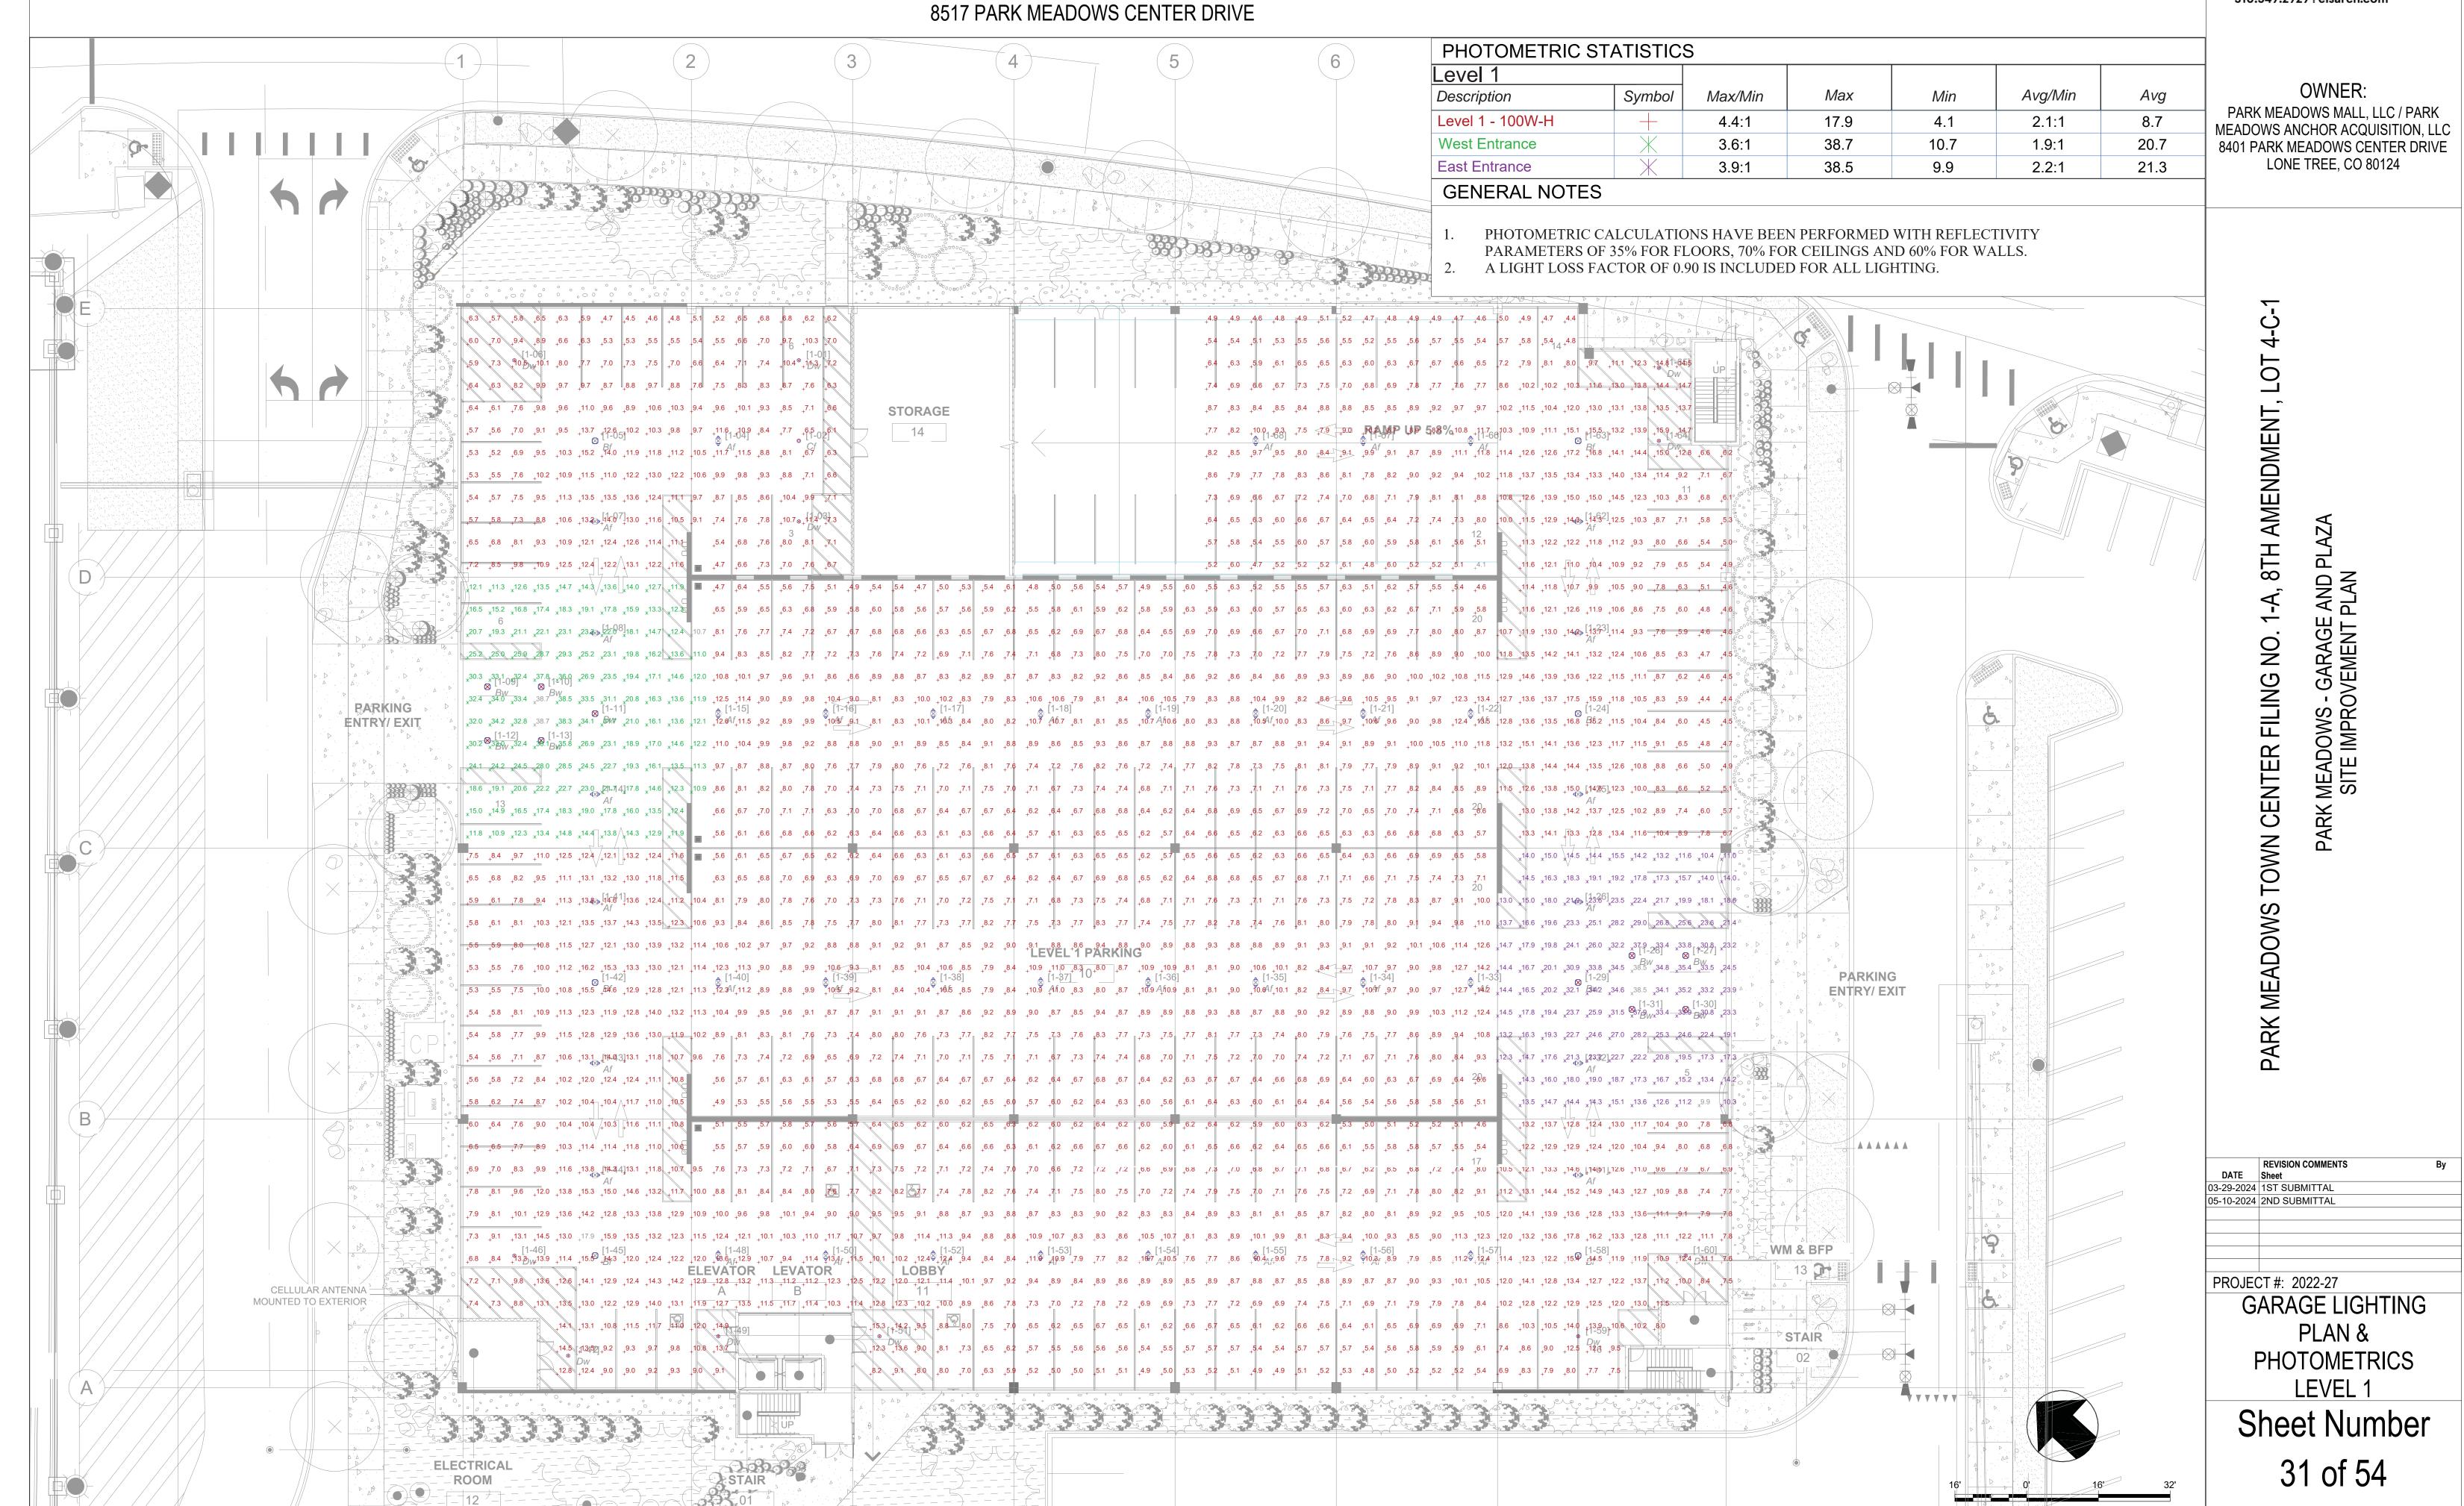
8517 PARK MEADOWS CENTER DRIVE

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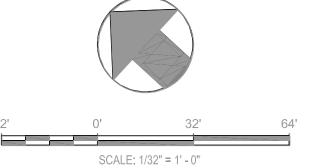


PARK MEADOWS TOWN CENTER FILING NO. 1-A, 8TH AMENDMENT, LOT 4-C-1 PARK MEADOWS PLANNED DEVELOPMENT, 2ND AMENDMENT PLANNING AREA #1

4.32 ACRES SIP #SP24-0010 8517 PARK MEADOWS CENTER DRIVE

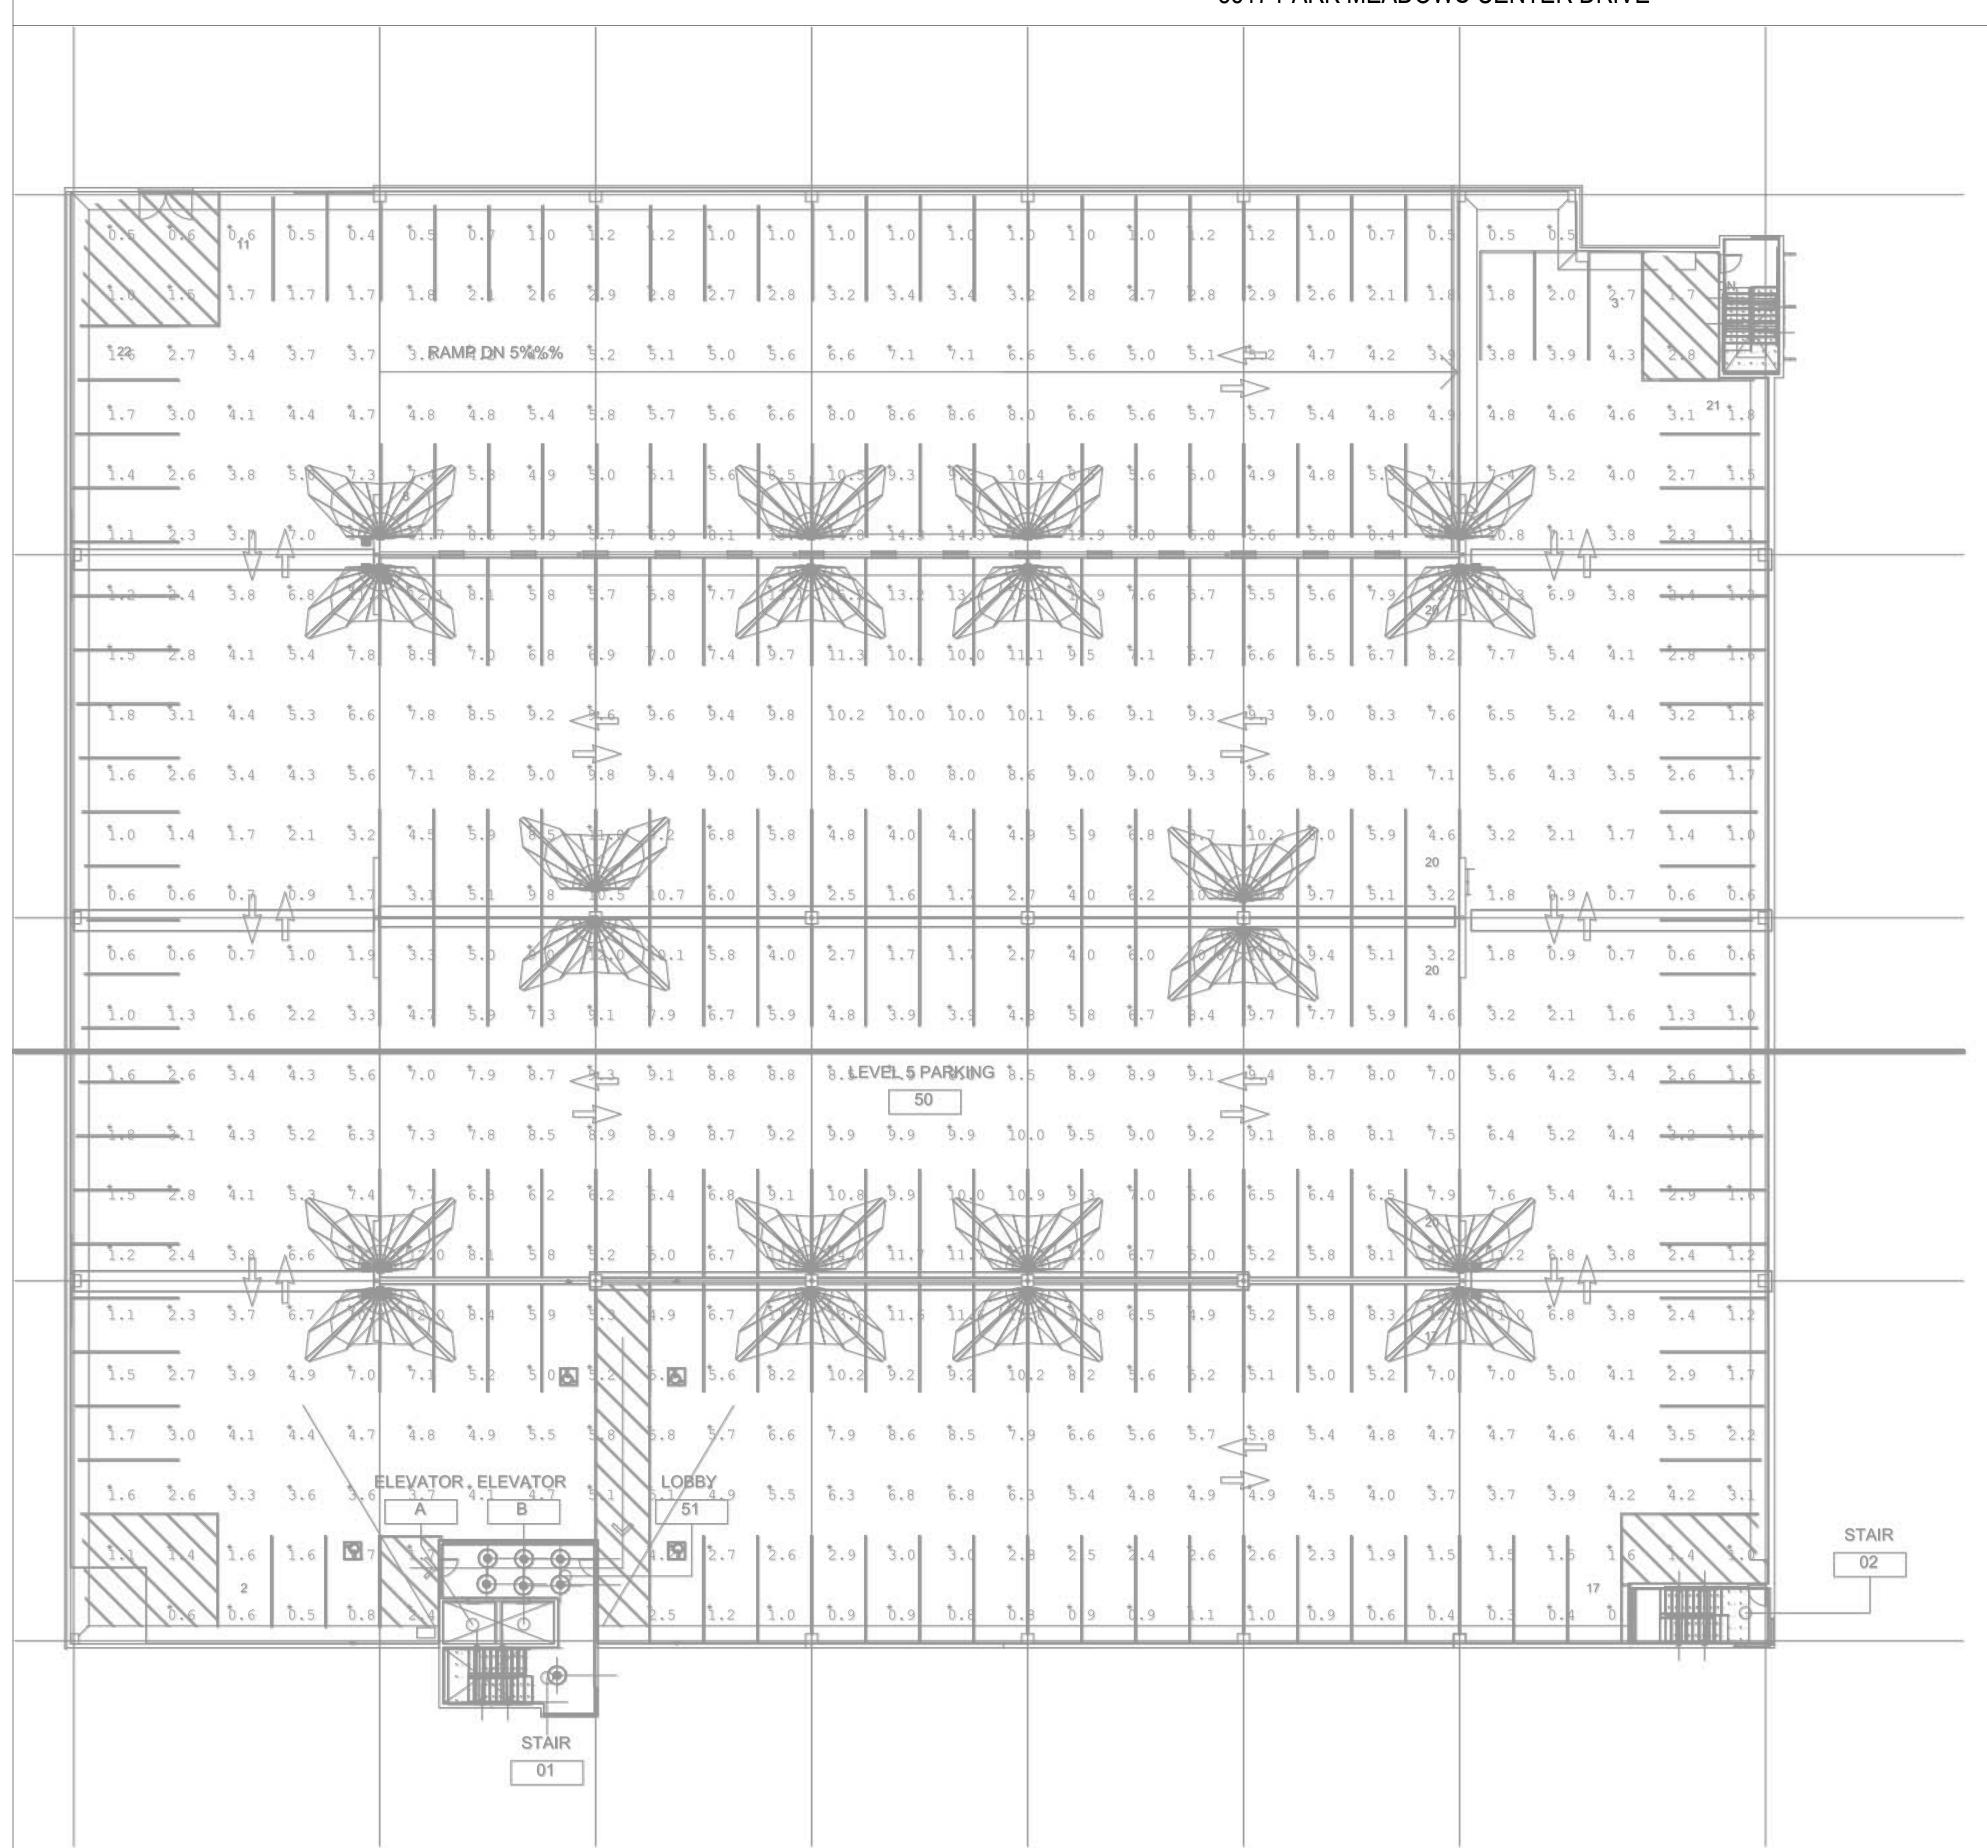

		UDIO			PARK		ISSUE Designer	D
LUMINA	IRE SCHEDULI	E.			100			T
TYPE	MFR	CATALOG NUMBER	FIXTURE DESCRIPTION	LAMP	MTG HEIGHT	LOAD / DIM TYPE	WATT	UN
LD1	ANP	OSSD24-MO10LDD-W-30K-2ST18-CBC- 100GLPRGUP-FINISH	24" LED Dome Pendant with 18" Stem Rod Mount, 1250 LUMENS, Cast Round Cover Plate, Prismatic Glass and Small Wire Guard ARCH TO VERIFY FINISH	Integral 3000k LED	Surface, Ceillng (18" STEM)	0-10V / ELV	10 EA	A
LD2 Ku	zco Lighting	AT7972-BK	72" Linear Indirect Sconce, 7200 Lumens, 90 CRI, Black Finish	Integral 3000k LED	Surface Wall	ELV	88 E/	12
LL1	Environmental Lights	wp-3000K-CL-10-5m CS116-2m EL-CLIP-78 EL-CAP-160-H / EL-CAP-160	Wet Rated High Efficacy Continuous Line LED Tape with Metal Extrusion and Frosted Lens, Metal Mounting Clips and End Caps	Integral 3000k LED	Surface / Millwork	0-10V / ELV / MLV	5	
LL1 (XFMR)	Environmental Lights	UNV-24-96	Universal Dimming Driver Available in 60, 96, 2x96, 3x96 watt options	N/A	Surface / Millwork	0-10V / ELV / MLV	96 E/	4
LL2	Environmental Lights	FDS-D-5m FDS-SI wp-3000K-2835PL-128-10-5m	Wet Rated LED Tape with Dome Top Flexible Diffusing Sleeve and Silicone Channel	Integral 3000k LED	Surface / Millwork	0-10V / ELV / MLV	3	
LL2 (XFMR)	Environmental Lights	UNV-24-96	Universal Dimming Driver Available in 60, 96, 2x96, 3x96 watt options	N/A	Surface /	0-10V / ELV / MLV	96 EA	
LL3	Coronet	LS WET-X'-30-HIGH-UNV-DB-FINISH-WM-S NA-NA-CAN-X	Wall Mounted Wet Rated LED luminaire with High Lumen	Integral 3000k LED	Surface /	0-10V	10 FT	-
LR1 WE	E-EF	134-6102-FINISH DOC110 LED	4.5" Round Downlight, Medium Beam Spread, 80 CRI ARCH TO VERIFY FINISH	Integral 3000k LED	Recessed, Ceiling	0-10V	15 E/	
	I Industries	OMITTED	ANOTHE VENIET FINISH	JOUGK LED	Johning			
LS1b LS	I Industries Coronet	OMITTED LS1 -6-30-HIGH-UNV-DB-FINISH-AC-FL-WISM-WISD-STD	6' Pendant Mount Linear Strlp, High Output 800 LUMENS/FT, Flat Diffuser, Wattstopper Occupancy and Daylight Sensors ARCH TO VERIFY FINISH	Integral 3000k LED	Celling Pendant / AC Cable	0-10V	60 E/	4
LS3	Coronet	LS1 UPDN-6-30-MED-MED-UNV-DB-FINISH WM-FL-FL-WISM-WISD	6' Wall Mounted Linear Strip with Up/Down Optics, Medium -Output 600 LUMENS/FT, Flat Diffuser, Wattstopper Occupancy and Daylight Sensors ARCH TO VERIFY FINISH	Integral 3000k LED	Surface, Ceiling	0-10V	84 E/	4
LS5a LS	I Industries	XDLM-A-FT-LED-VHO-WW-UE-FINISH-SAS	Lifestyle Medium Angled Outdoor Decorative Area Light, 25000 LUMENS, Forward Throw Optic, Integral Louver Shield, integral S- Motion and Photocell Sensor ARCH / EE TO ADVISE POLE REQUIREMENTS ARCH TO VERIFY FINISH	Integral 3000k LED	20' AFF Pole Mount	MOTION / PHOTOCE LL	196 E.	A
LS6 Co	ntech	SQL3T-3-30K-12D1-D-X-F-FINISH	3.5" Square Wall Mounted Downlight with DOWN ONLY output, 36° Flood, 1800 Im Output ARCH TO VERIFY FINISH	Integral 3000k LED	Canopy Side Mount	0-10V	20 E/	1
LS7 WI	E-EF	FLC220 LED 139-2001 147-0544 139-1987	CONTRACTOR TO VERIFY POLE SIZE Pole Mounted LED Adjustable Accent Light with Medium Beam, 1533 Lumens, Pole Clamp (exact width tbd) SNOOT FOR DARK SKY ARCH TO VERIFY FINISH	Integral 3000k LED	Pole Mount	PHOTOCE LL	14.5 E	
LS8a W	E-EF	ZFT430-FT-LED-115-1860 159-0321 693-9320 / AMW-Z-20-MA	Pole Mounted LED Street Lighter with S65 Streetlighting Distribution, 6145 Lumens, + LIGHT SHIELD FOR DARK SKY 20' WOOD POLE ARCH TO VERIFY FINISH	Integral 3000k LED	20' AFF Pole Mount	PHOTOCE LL	42 E/	4
LS8b W	E-EF	LTM440 LED-FT 115-1565 159-0321	Pole Mounted LED Path Lighter withType V Short C50) Distribution, 5171 Lumens, + LIGHT SHIELD FOR DARK SKY 157" Pole Included ARCH TO VERIFY FINISH	Integral 3000k LED	13' AFF Pole Mount	PHOTOCE LL	42 E/	٩
LS9a Co	ontech	CY3S-3-30K-12D1-C-X-WW-P	Outdoor rated Ceiling Mounted Cylinder with Wallwash Optic, 1800 LM	Integral 3000k LED	Ceiling Surface	TRIAC / ELV	20 E/	1
LS9b Co	ontech	CY3S-3-30K-12D1-C-X-WF-P	ARCH TO VERIFY MATTE WHITE FINISH Outdoor rated Ceiling Mounted Cylinder with Wide Flood Optic, 1800 LM	Integral	Mount Ceiling Surface	TRIAC /	20 E/	
	menpulse	LBG-VOLTS-30K-NF-WF-LSLV-FINISH-DIN	ARCH TO VERIFY MATTE WHITE FINISH 1- Wall mounted LED luminaire with Hi Lumen output (12k), with	3000k LED	Mount Ceiling Surface	0-10V 10		
LS11	Ecosense	SY-UL- F080-2H-HO-30-8-40-FINISH-F-B	dual optics at 20° and 30° for maximum coverage. Surface Mounted Double Head Adjustable Accent Light, 40° Flood Optic, 80 CRI, High Output, Full Snoot, 10' External Cable, Side Exit, Surface Mount, UL Listed	3000k LED Integral 3000k LED	Mount Ceiling Surface	0-10V	23 E/	
LX1	American Lighting	LS2-M-24-48-BK	2 Wire Interconnectable String Lights; Medium Base; 48ft; 24 Sockets; Black	PS14-E26-	Mount String Light	LV	34 E/	1:
	Lighting AC Lighting	5011-30-BZ 5010-SNOOT-BZ	Patio Lighting lamps, box of 25 2700K Warm White Adjustable LED landscape light with locakable adjustable beam angle, Integral Dimmer, Glare reduction Snoot Mounting stake, 6' lead wire and direct burial gel filled wire nuts	WW Integral 3000k LED	Ground Stake Mount	MLV 18		
LX2 XFMR	WAC Lighting	9075-TRN-SS	TRANSFORMER AVAILABLE IN 75, 150, 300, AND 600 WATT, EE TO VERIFY WATTAGE REQUIRED Stainless Steel, 12-15V output, IP65 rated, UL 1838 listed See transformer spec sheet for details and its accessories	n/a	Surface MI	.V 75 EA 120	OV	
LX3 18	00BOLLARDS	I LUM LED BZ CL 12L C A BP	LIGHT COLOR TBD - RGB IF AVAILABLE Heavy Duty Aluminum Bollard with triple light beam effect	Integral LED - COLOR TBD	Surface EL	V	32 E <i>F</i>	
LX4 Co	oledge	TILE-EXT-900-30-R3 TACC-EXT-CUT-900-30-R3 TCBL-SCT-T4/T10 TACC-EXT-SCT-STR	FINAL FIXTURE SIZE TO BE DETERMINED PER MILLWORK SID DRAWINGS. FIXTURES SHALL BE INSTALLED IN 4" RECESS CABEHIND P95 MATTE CLEAR ACRYLIC (OR SIMILAR). Configurable Exterior Rated Light Tiles, available in Field Cuttable and connectable sheets, nominally 23.5" x 11.8". Total dimensions to equal approx. 4'x4' square (per millwork)		Surface 0-	0V 100 EA	120V	
LX5	EXISTING - QUALITY LIGHTING CO	CL-124(MOD. ADJ. SKT.)-VS-1000MH- CL80-480-FDD-CC-RE ON A 37'-0" HIGH POLE, VALMONT DS2109.0E370-P2-CC (7 GUAGE)	EXISTING TO BE RELOCATED 27" Square x 15" Deep Aluminum Housing, Sharp Cut-off, Type Vertical Square (VS) distribution (80° Cut Off)	(3) 1000 WATT META HALID	37' Pole Mounted	ND 330	0 EA 480'	,
LX6	EXISTING - QUALITY LIGHTING CO	CL-127(MOD. ADJ. SKT.)-VS-1000MH- CL80-480-FDD-CC-RE ON A 37'-0" HIGH POLE, VALMONT DS2109.0E370-P2-CC (7 GUAGE)	EXISTING TO BE RELOCATED 27" Square x 15" Deep Aluminum Housing, Sharp Cut-off, Type Vertical Square (VS) distribution (80° Cut Off)	(4) 1000 WATT META HALID	37' Pole Mounted	ND 440	0 EA 480'	V



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OWNER:

PARK MEADOWS MALL, LLC / PARK MEADOWS ANCHOR ACQUISITION, LLC 8401 PARK MEADOWS CENTER DRIVE LONE TREE, CO 80124

> 8TH AMENDMENT, PARK MEADOWS - GARAGE AND PLAZA SITE IMPROVEMENT PLAN FILING NO. PARK MEADOWS TOWN CENTER

03-29-2024 1ST SUBMITTAL 05-10-2024 2ND SUBMITTAL 06-04-2024 3RD SUBMITTAL

PROJECT #: 2022-27

GARAGE LIGHTING PLAN & PHOTOMETRICS LEVEL 5

Sheet Number 33 of 54

1 ARCHITECTURAL SITE PLAN - OVERALL LEVEL 5

PARK MEADOWS TOWN CENTER FILING NO. 1-A, 8TH AMENDMENT, LOT 4-C-1 PARK MEADOWS PLANNED DEVELOPMENT, 2ND AMENDMENT PLANNING AREA #1 4.32 ACRES SIP #SP24-0010 es architecture+ urban design 2040 Addison St, Berkeley, CA 94704 **510.549.2929 | elsarch.com** 8517 PARK MEADOWS CENTER DRIVE OWNER: PARK MEADOWS MALL, LLC / PARK MEADOWS ANCHOR ACQUISITION, LLC PARK MEADOWS RING ROAD 8401 PARK MEADOWS CENTER DRIVE LONE TREE, CO 80124 FILING NO. 1-A, 8TH AMENDMENT, LOT 4-C-1 PARKING ENTRY/ EXIT NORTH PARKING GARAGE PARK MEADOWS - GARAGE AND PLAZA SITE IMPROVEMENT PLAN PARKING ENTRY/ EXIT DRI PARK MEADOWS TOWN CENTER **' ' '** | DRIVE DATE Sheet 03-29-2024 1ST SUBMITTAL 05-10-2024 2ND SUBMITTAL EAST ENTRY PROJECT #: 2022-27 ARCHITECTURAL DOCK SITE PLAN PHASE 1A - SIP PARK MEADOWS MALL EXISTING BUILDING **Sheet Number** 1 ARCHITECTURAL SITE PLAN PHASE 1A 34 of 54 SCALE: 1/32" = 1' - 0"

PARK MEADOWS TOWN CENTER FILING NO. 1-A, 8TH AMENDMENT, LOT 4-C-1 PARK MEADOWS PLANNED DEVELOPMENT, 2ND AMENDMENT PLANNING AREA #1 4.32 ACRES SIP #SP24-0010 es architecture+ urban design 2040 Addison St, Berkeley, CA 94704 **510.549.2929 | elsarch.com** 8517 PARK MEADOWS CENTER DRIVE OWNER: PARK MEADOWS MALL, LLC / PARK MEADOWS ANCHOR ACQUISITION, LLC 8401 PARK MEADOWS CENTER DRIVE LONE TREE, CO 80124 FILING NO. 1-A, 8TH AMENDMENT, LOT 4-C-1 PARKING ENTRY/ EXIT NORTH PARKING GARAGE PARK MEADOWS - GARAGE AND PLAZA SITE IMPROVEMENT PLAN PARKING ENTRY/ EXIT PARK MEADOWS TOWN CENTER COMMERCIAL D1 7,990 SF COMMERCIAL D2 12,080 SF DATE Sheet 03-29-2024 1ST SUBMITTAL 05-10-2024 2ND SUBMITTAL NEW TRUCK DOCK GATE EAST ENTRY PROJECT #: 2022-27 ARCHITECTURAL SITE PLAN PHASE 1B - SIP PARK MEADOWS MALL EXISTING BUILDING **Sheet Number** 1 ARCHITECTURAL SITE PLAN PHASE 1B - OVERALL LEVEL 1 35 of 54 SCALE: 1/32" = 1' - 0"

PARK MEADOWS TOWN CENTER FILING NO. 1-A, 8TH AMENDMENT, LOT 4-C-1 PARK MEADOWS PLANNED DEVELOPMENT, 2ND AMENDMENT PLANNING AREA #1 4.32 ACRES

SIP #SP24-0010 8517 PARK MEADOWS CENTER DRIVE



OWNER:

STL PL., PTD.

PARK MEADOWS MALL, LLC / PARK MEADOWS ANCHOR ACQUISITION, LLC 8401 PARK MEADOWS CENTER DRIVE

LONE TREE, CO 80124

LOT 8TH AMENDMENT, PARK MEADOWS - GARAGE AND PLAZA SITE IMPROVEMENT PLAN FILING NO.


PARK MEADOWS TOWN CENTER


REVISION COMMENTS 03-29-2024 1ST SUBMITTAL 05-10-2024 2ND SUBMITTAL


PROJECT #: 2022-27

MALL ENTRY CANOPY, TRUCK DOCK GATE -PHASE 1B

Sheet Number 36 of 54

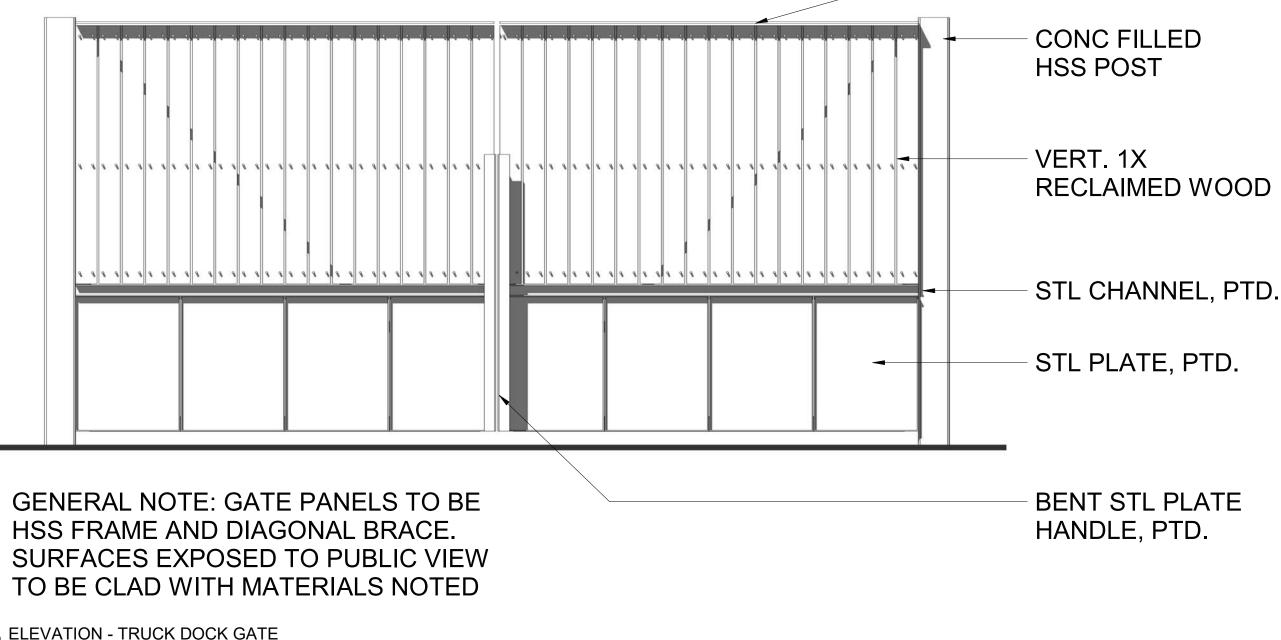


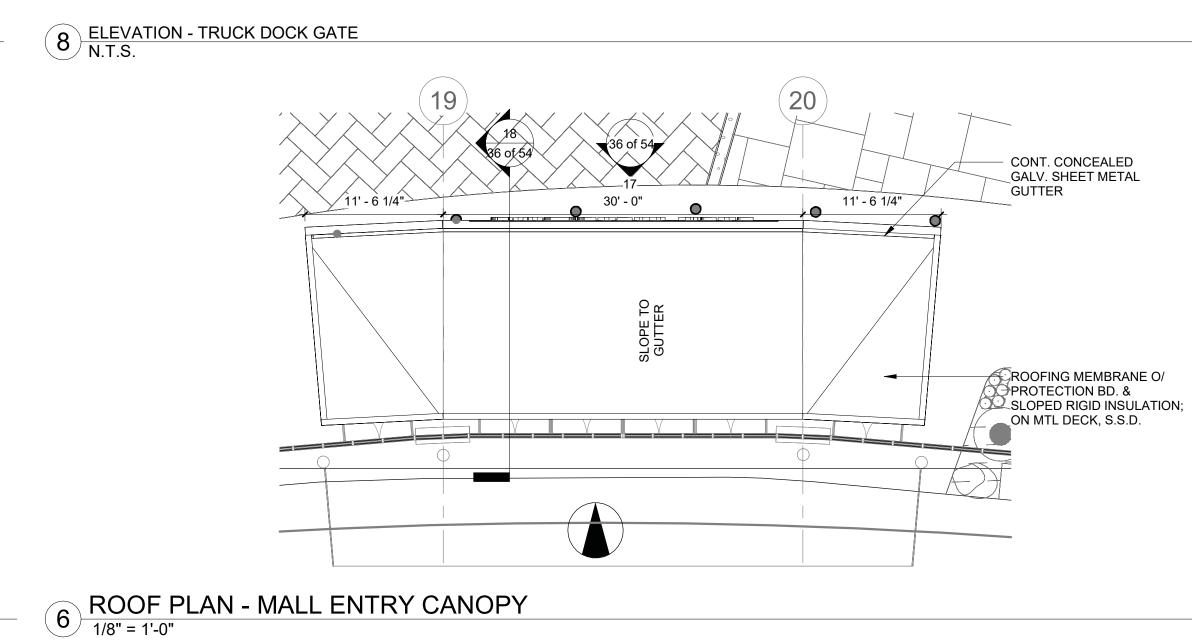


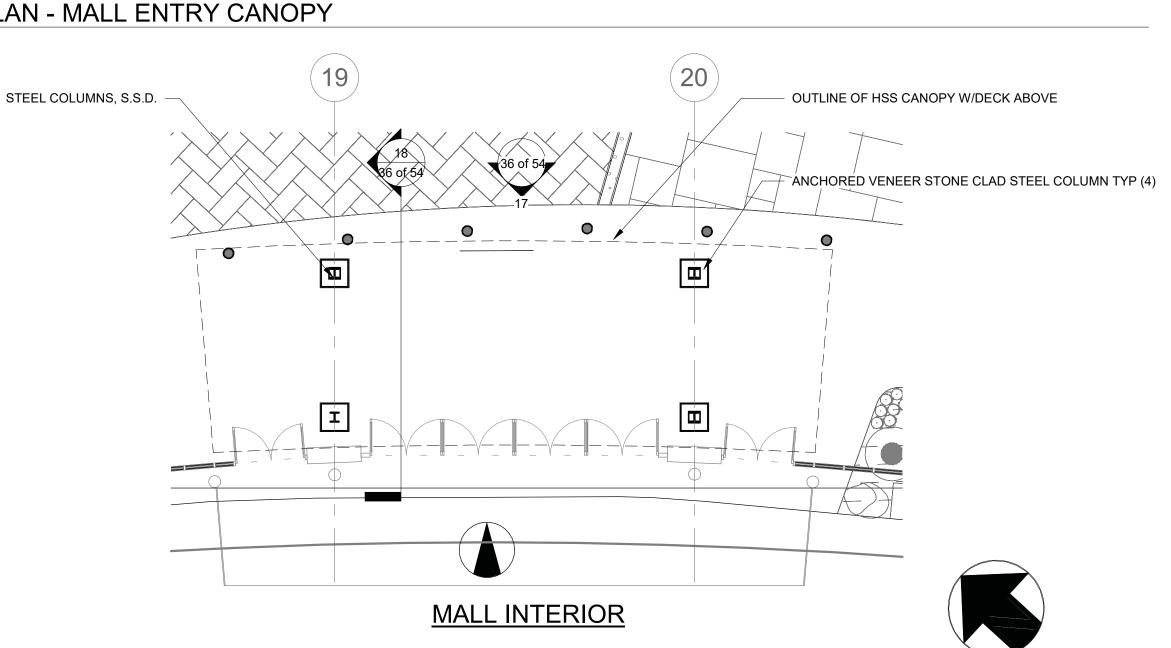





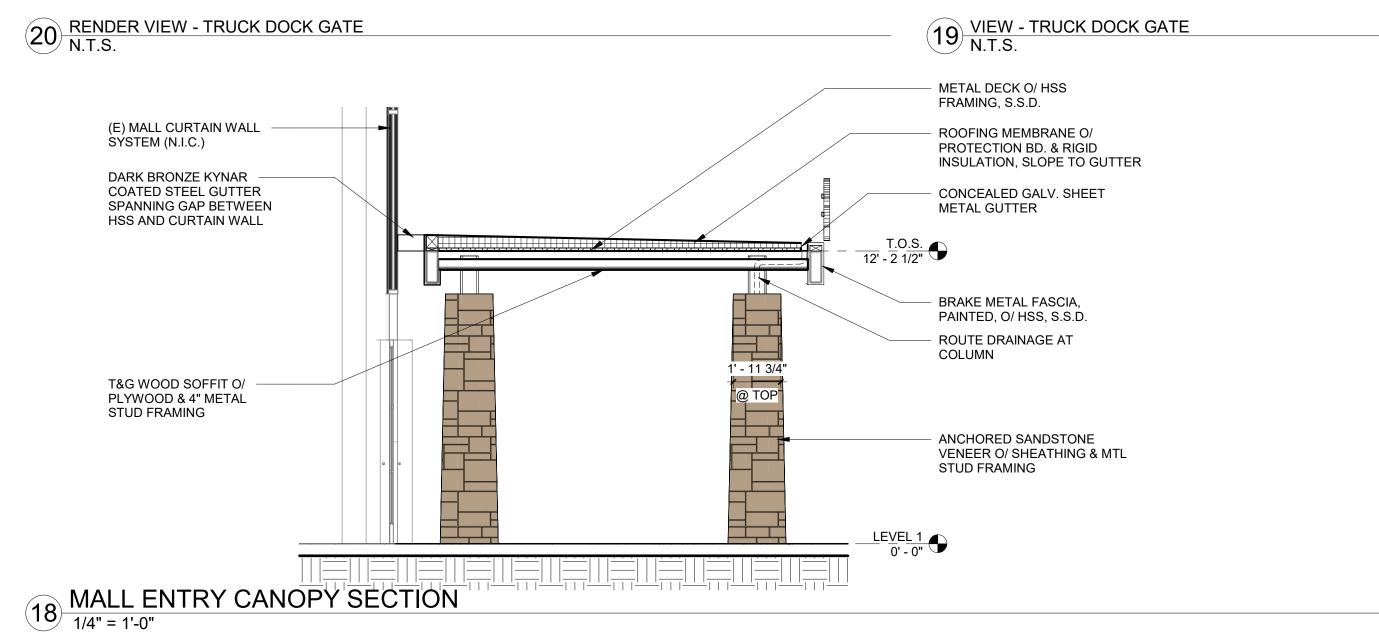

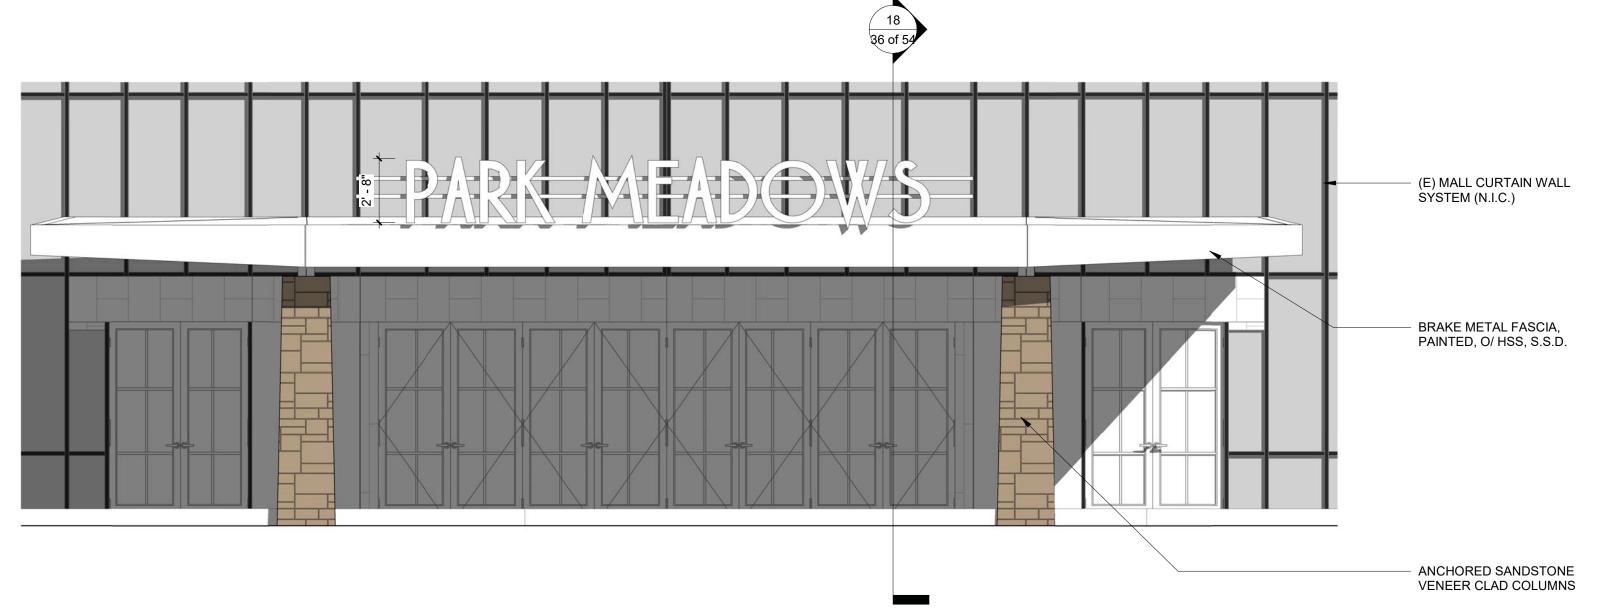

4.32 ACRES SIP #SP24-0010 8517 PARK MEADOWS CENTER DRIVE



OWNER:

PARK MEADOWS MALL, LLC / PARK MEADOWS ANCHOR ACQUISITION, LLC 8401 PARK MEADOWS CENTER DRIVE LONE TREE, CO 80124

1-A, 8TH AMENDMENT, LOT 4-C-1 OWS - GARAGE AND PLAZA MPROVEMENT PLAN FILING NO. TOWN CENTER PARK MEADO SITE IN PARK MEADOWS

REVISION COMMENTS


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PROJECT #: 2022-27


EXTERIOR

ELEVATIONS

Sheet Number 37 of 54

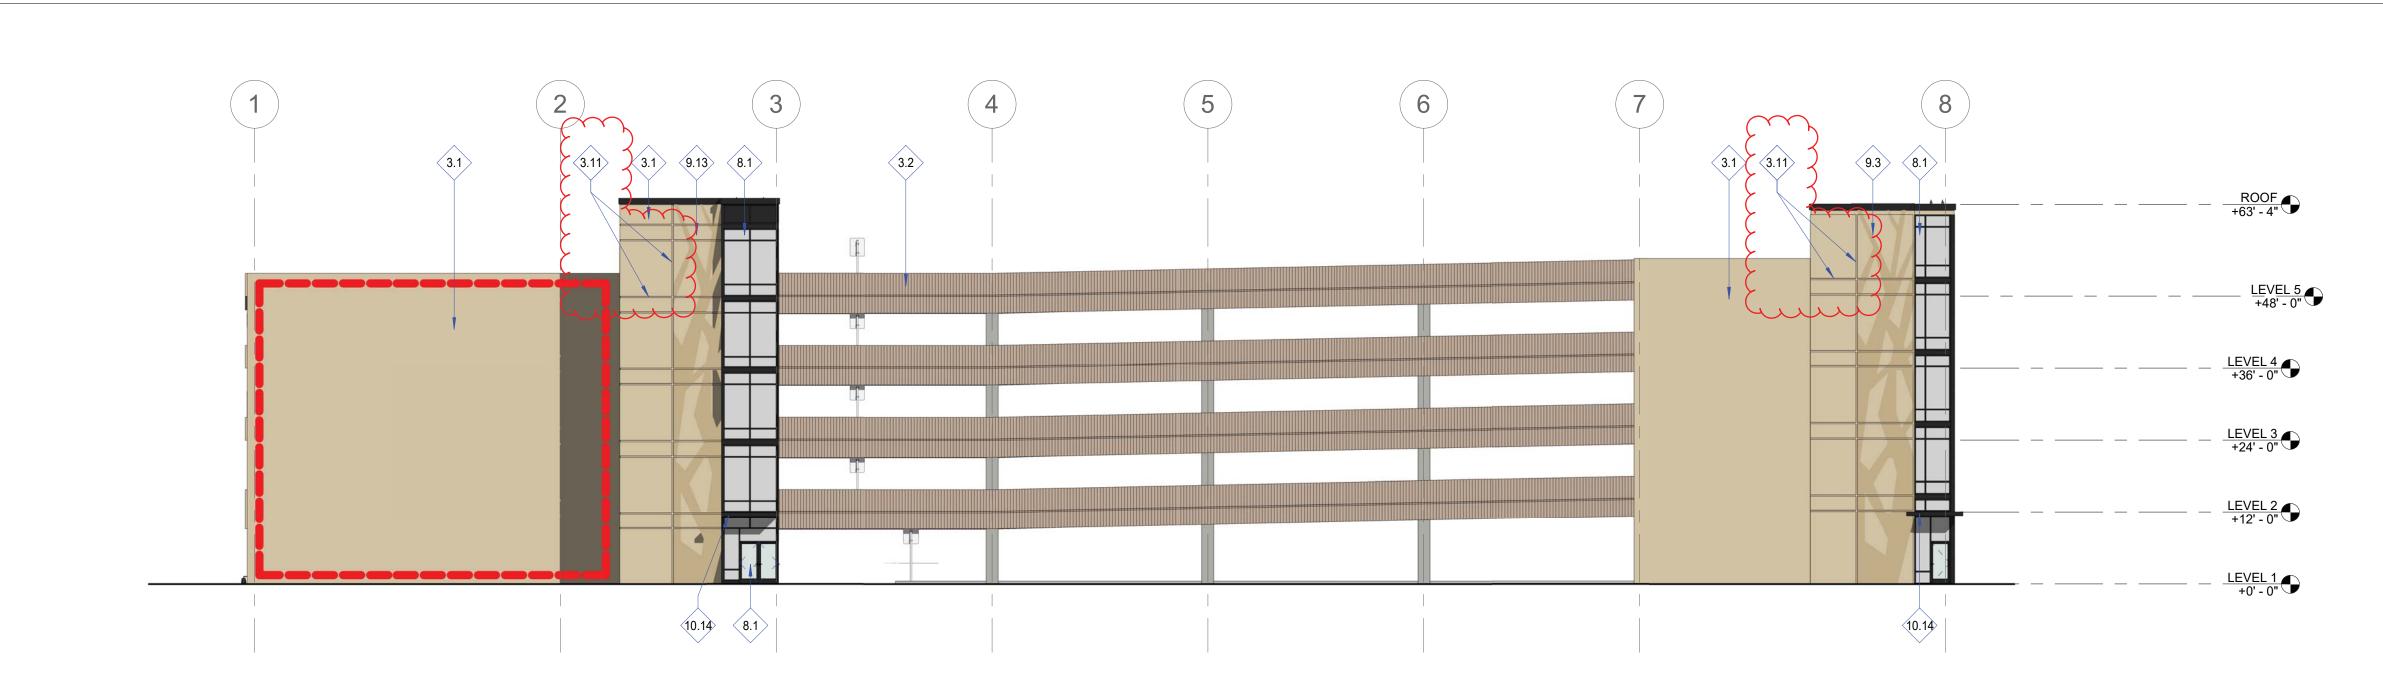

2 SOUTH ELEVATION PAHSE 1B 1/16" = 1'-0"

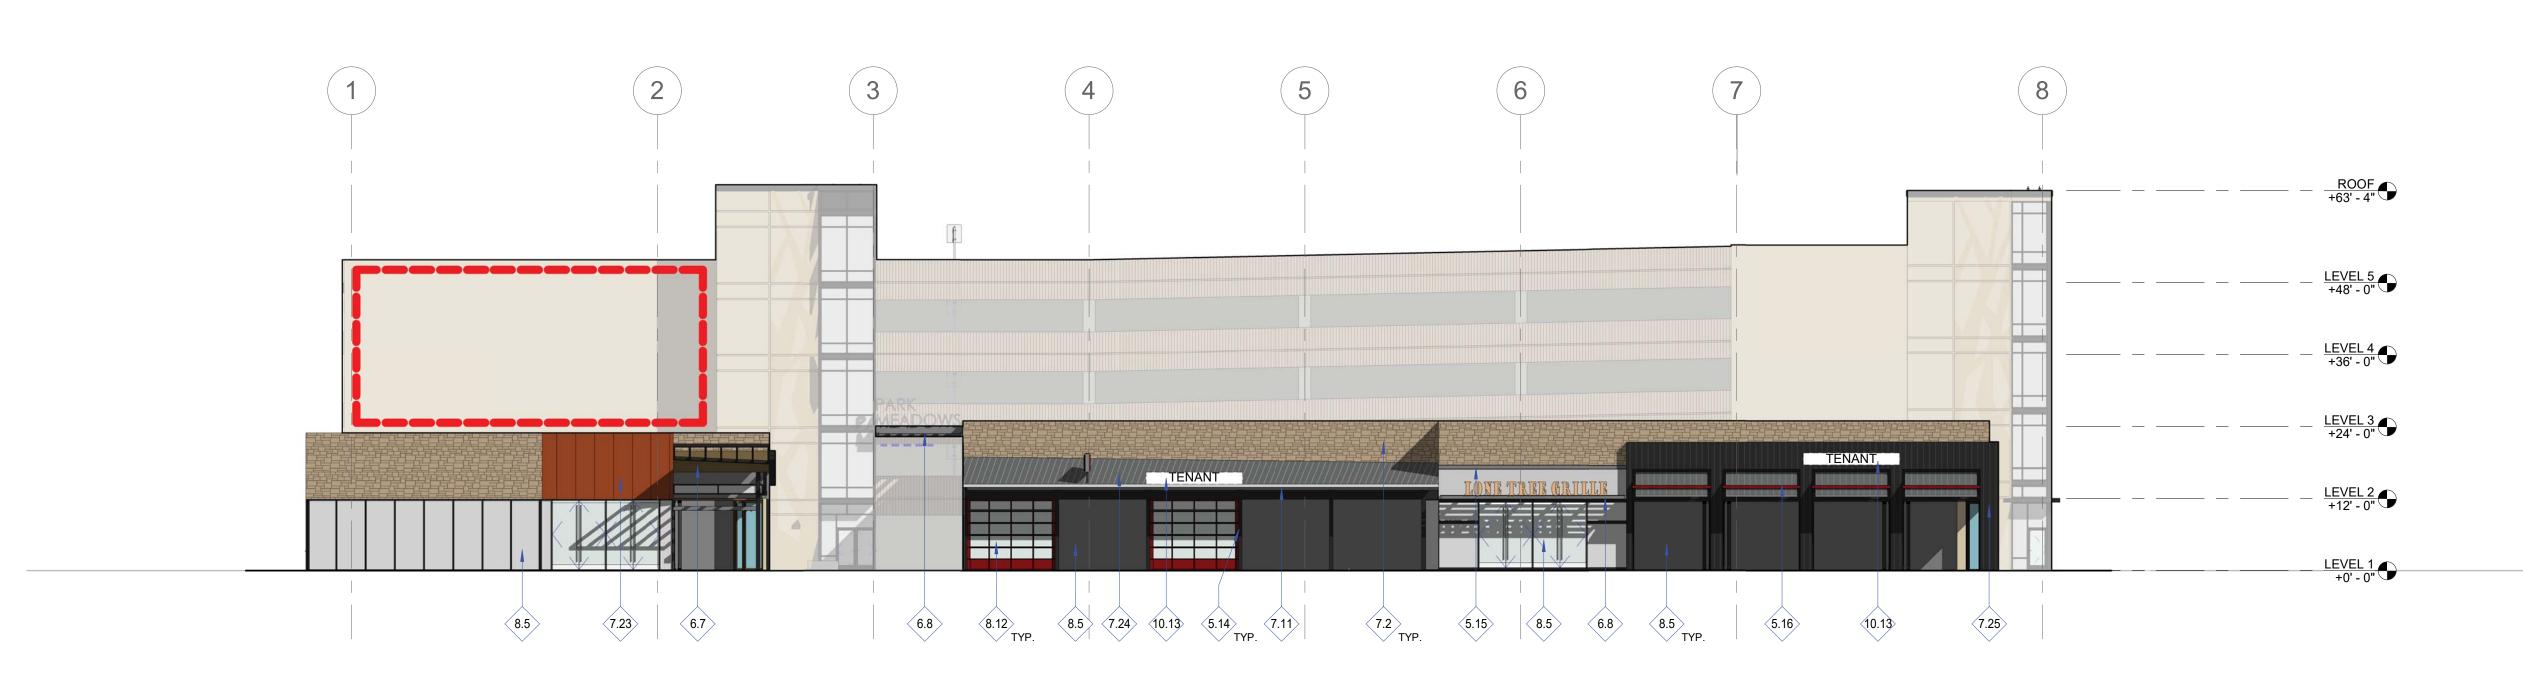

SOUTH ELEVATION PHASE 1B 1/16" = 1'-0"

MATERIAL KEY

- PRECAST CONCRETE, S.S.D. INTEGRAL COLOR, LIGHT ACID WASH. B.O.D. MSPRECAST MCI-229-AL PRECAST CONCRETE, S.S.D. INTEGRAL COLOR W/ FORM LINER TEXTURE. B.O.D. SCOTT SYSTEM FORM 7.25 LINER #193 MICRO FRACTURE. BID ALTERNATE #1: CUSTOM FORM LINER TEXTURE ON PRECAST CONCRETE SPANDRELS TO CREATE TREE BRANCH AESTHETIC, SEE PRECAST CONCRETE SCHEDULE
- SHEETS (A803, A804, A805) AND DETAIL 2/A303. 3.11 6" TALL CONCRETE CURB, S.S.D. 5.14 AESS FRAMING, PAINTED

7.11 SHEET METAL GUTTER

- 5.15 STEEL CHANNEL, PTD. 5.16 METAL PANEL AWNING, PTD. RECLAIMED WOOD SOFFIT CLADDING
- HONED AND FLAMED FINISH. B.O.D.: LYONS SANDSTONE, PRAIRIE GOLD
- RECLAIMED WOOD SIDING, MFR. TERRAMAI LOST COAST REDWOOD SIDING, WEATHERED WITH CLEAR COAT FINISH ANCHORED SANDSTONE VENEER; COMBINATION

LEGEND

STANDING SEAM METAL SIDING, MFR. WESTERN STATES METAL ROOFING, FINISH: "WEATHERED RUSTIC" PVDF. SIMULATED WEATHERED STEEL CORRUGATED METAL ROOF PANEL, PTD. PROFILED METAL SIDING, MFR. PAC CLAD, PROFILE BOX RIB 1, COLOR: PARC CLAD "GRAPHITE" ALUMINUM AND GLASS WINDOW WALL SYSTEM.

ALUMINUM AND GLASS STOREFRONT SYSTEM PAINTED METAL ROLL-UP DOORS WITH CLEAR GLASS INSERTS PRECAST CONCRETE, PAINTED 9.13 PAINTED PATTERN 10.13 CONCEPTUAL SIGNAGE UNDER SEPARATE PERMIT 10.14 FIXED METAL CANOPY

AREA DESIGNATED FOR MURALS, MURALS TO REMAIN IN PHASE 1B



3.1 - PC1 PRECAST CONCRETE, INTEGRAL COLOR, LIGHT ACID WASH. **BOD: MSPRECAST MCI-229-AL GOLD BUFF**

PRECAST CONCRETE,

MICRO FRACTURE;

SAME COLOR AS 1.01

TEXTURE. BOD: SCOTT

SYSTEM FORM LINER #193

INTEGRAL COLOR, FORM LINER



7.2 - S1 **ANCHORED SANDSTONE** VENEER COMBINATION HONED AND FLAMED FINISH. **BOD: LYONS SANDSTONE** "PRAIRIE GOLD"

8.1 - WW1

8.2 - WW2

ALUM AND GLASS

"DARK BRONZE"

ALUM AND GLASS

WINDOW WALL SYSTEM,

STOREFRONT SYSTEM



RECLAIMED WOOD SIDING MFR. TERRAMAI LOST COAST REDWOOD SIDING, **WEATHERED WITH** CLEAR COAT FINISH

6.8 - WD1



STANDING SEAM METAL SIDING, MFR. WESTERN STATES **METAL ROOFING,** FINISH: "WEATHERED RUSTIC" PVDF. (SIMULATED WEATHERED STEEL)



CORRUGATED METAL ROOFING MFR. WESTERN STATES METAL ROOFING, FINISH: "GRAY ZINC MATTE"
(SIMULATED WEATHERED ZINC)

PROFILED METAL SIDING,

7.25 - MTL

MFR. PAC CLAD,

"GRAPHITE"

PROFILE BOX RIB 1,

COLOR: PAC CLAD

4.32 ACRES SIP #SP24-0010 8517 PARK MEADOWS CENTER DRIVE



OWNER:

PARK MEADOWS MALL, LLC / PARK MEADOWS ANCHOR ACQUISITION, LLC 8401 PARK MEADOWS CENTER DRIVE LONE TREE, CO 80124

1-A, 8TH AMENDMENT, LOT 4-C-1 OWS - GARAGE AND PLAZA MPROVEMENT PLAN FILING NO. PARK MEADC SITE IN PARK MEADOWS TOWN CENTER

REVISION COMMENTS

03-29-2024 1ST SUBMITTAL


05-10-2024 2ND SUBMITTAL


PROJECT #: 2022-27

EXTERIOR

ELEVATIONS

Sheet Number 38 of 54

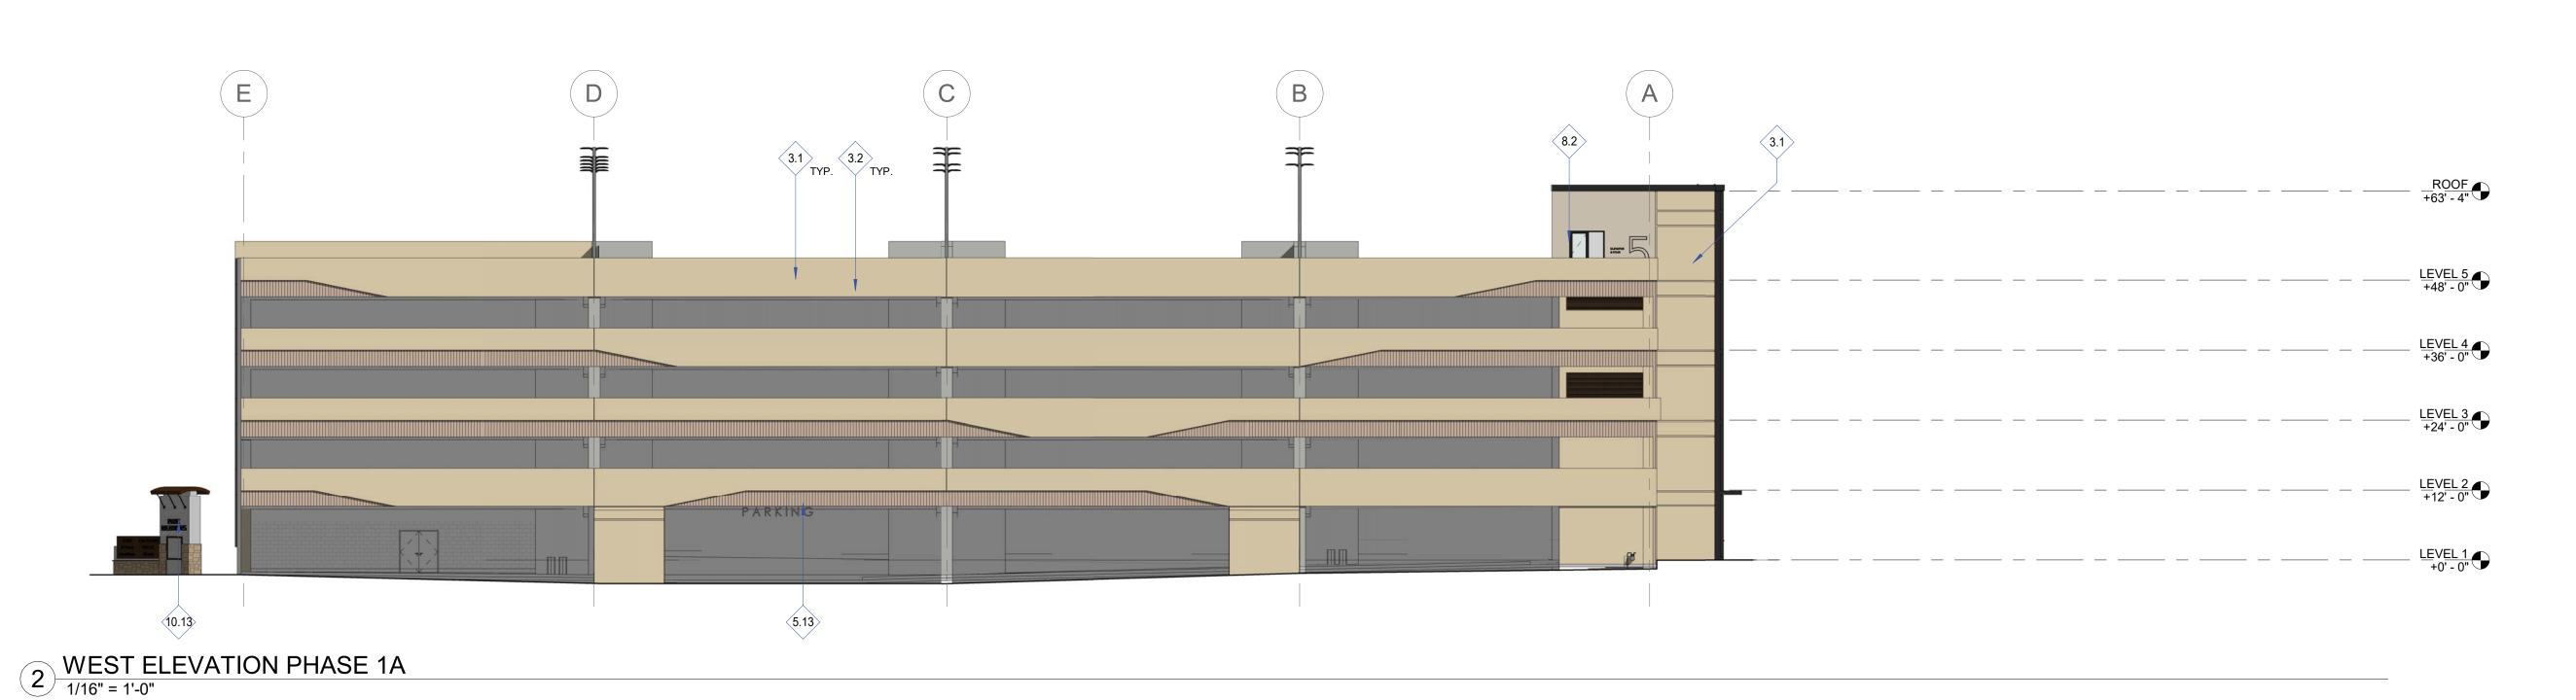

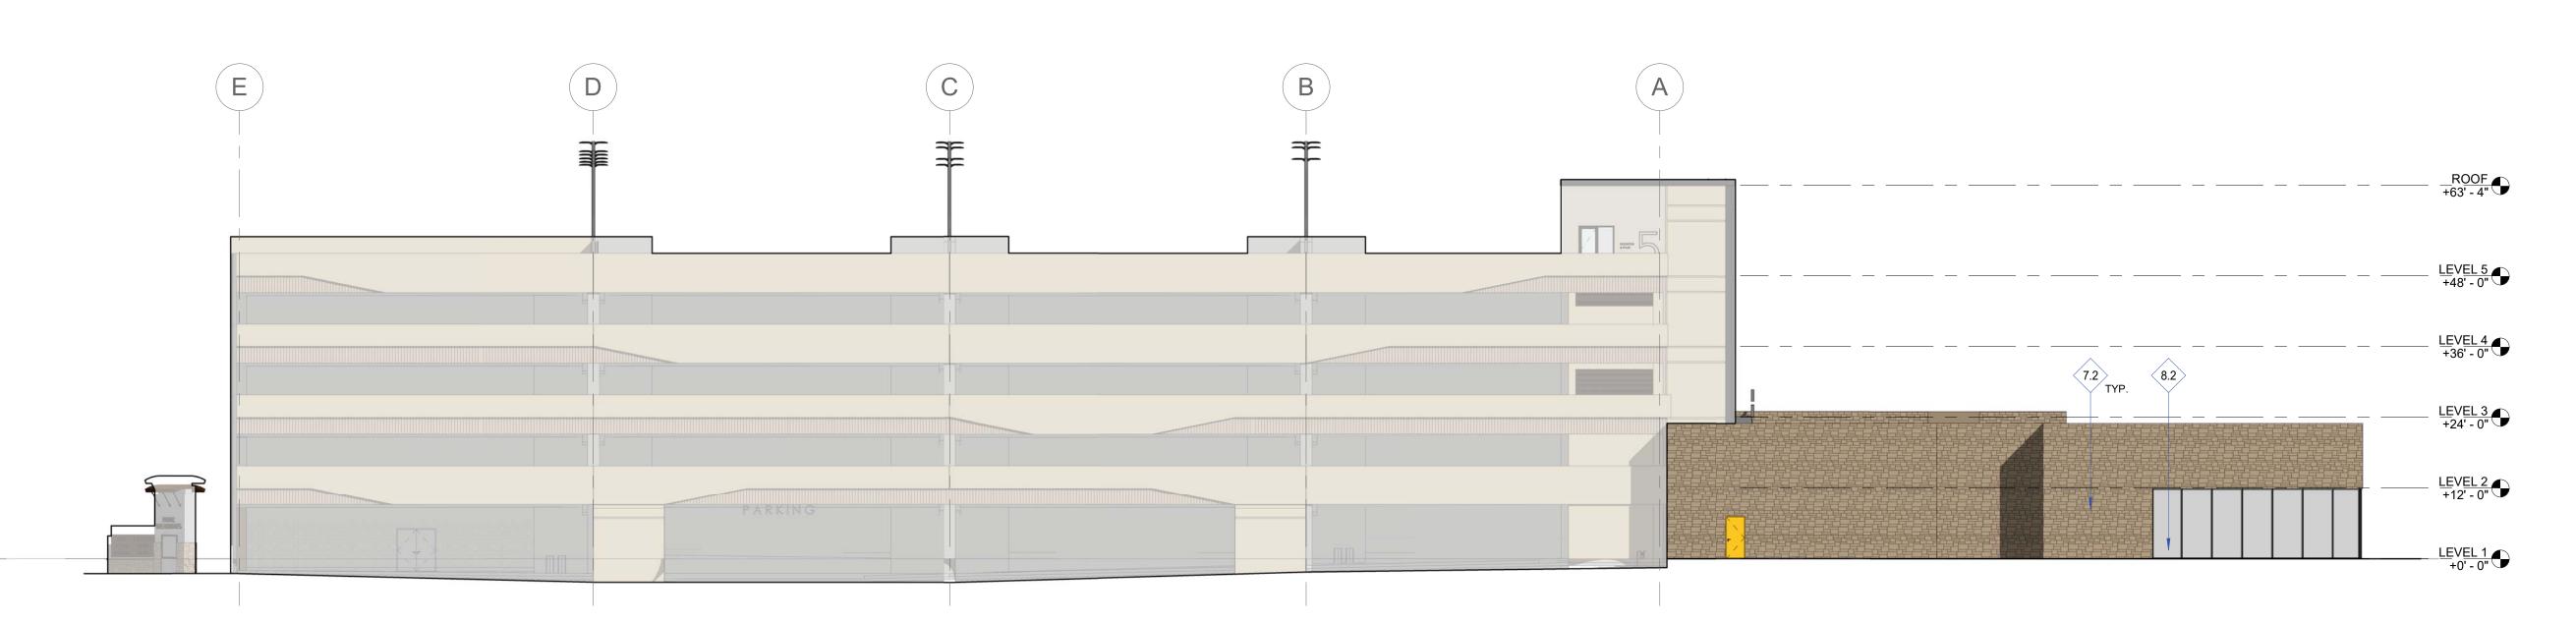

1 WEST ELEVATION PHASE 1B

MATERIAL KEY

3.1 PRECAST CONCRETE, S.S.D. INTEGRAL COLOR, LIGHT ACID WASH. B.O.D. MSPRECAST MCI-229-AL

PRECAST CONCRETE, S.S.D. INTEGRAL COLOR W/ FORM LINER TEXTURE. B.O.D. SCOTT SYSTEM FORM LINER #193 MICRO FRACTURE. BID ALTERNATE #1: CUSTOM FORM LINER TEXTURE ON PRECAST CONCRETE SPANDRELS TO CREATE TREE BRANCH AESTHETIC, SEE PRECAST CONCRETE SCHEDULE

SHEETS (A803, A804, A805) AND DETAIL 2/A303. 5.13 HORIZONTAL TUBE STEEL RAIL FOR PARKING SIGNAGE MOUNTING, PTD., TYP.

ANCHORED SANDSTONE VENEER; COMBINATION HONED AND FLAMED FINISH. B.O.D.: LYONS SAMBSTONE, PRAIRIE GOLD

ALUMINUM AND GLASS STOREFRONT SYSTEM. B.O.D.: KAWNEER TRIFAB 451T THERMALLY BROKEN 10.13 CONCEPTUAL SIGNAGE UNDER SEPARATE PERMIT



3.1 - PC1 PRECAST CONCRETE, INTEGRAL COLOR, LIGHT ACID WASH. **BOD: MSPRECAST MCI-229-AL GOLD BUFF**

PRECAST CONCRETE,

TEXTURE. BOD: SCOTT

MICRO FRACTURE; SAME COLOR AS 1.01

SYSTEM FORM LINER #193

INTEGRAL COLOR, FORM LINER



7.2 - S1 ANCHORED SANDSTONE VENEER COMBINATION HONED AND FLAMED FINISH. **BOD: LYONS SANDSTONE** "PRAIRIE GOLD"

8.1 - WW1 ALUM AND GLASS

"DARK BRONZE"

ALUM AND GLASS

STOREFRONT SYSTEM

8.2 - WW2

WINDOW WALL SYSTEM,



6.8 - WD1 **RECLAIMED WOOD SIDING** MFR. TERRAMAI LOST COAST REDWOOD SIDING, **WEATHERED WITH CLEAR COAT FINISH**

7.23 - ST1 STANDING SEAM METAL SIDING,

FINISH: "WEATHERED RUSTIC" PVDF

(SIMULATED WEATHERED STEEL)

MFR. WESTERN STATES

METAL ROOFING,







CORRUGATED METAL ROOFING MFR. WESTERN STATES METAL ROOFING, FINISH: "GRAY ZINC MATTE" (SIMULATED WEATHERED ZINC)

7.25 - MTL PROFILED METAL SIDING,

MFR. PAC CLAD,

"GRAPHITE"

PROFILE BOX RIB 1,

COLOR: PAC CLAD

SIP #SP24-0010 8517 PARK MEADOWS CENTER DRIVE



OWNER:

PARK MEADOWS MALL, LLC / PARK MEADOWS ANCHOR ACQUISITION, LLC 8401 PARK MEADOWS CENTER DRIVE LONE TREE, CO 80124

1-A, 8TH AMENDMENT, LOT 4-C-1

OWS - GARAGE AND PLAZA MPROVEMENT PLAN PARK MEADC SITE IN

FILING NO.

TOWN CENTER

PARK MEADOWS

REVISION COMMENTS

03-29-2024 1ST SUBMITTAL 05-10-2024 2ND SUBMITTAL

PROJECT #: 2022-27


EXTERIOR ELEVATIONS

Sheet Number 39 of 54

6 3 3.2 TYP. 3.1 TYP. 3.10 TYP. 32.5 32.12 ROOF +63' - 4" LEVEL 5 +48' - 0" LEVEL 4 +36' - 0" LEVEL 3 +24' - 0" LEVEL 2 +12' - 0" LEVEL 1 +0' - 0"

NORTH ELEVATION PHASE 1A

1/16" = 1'-0"

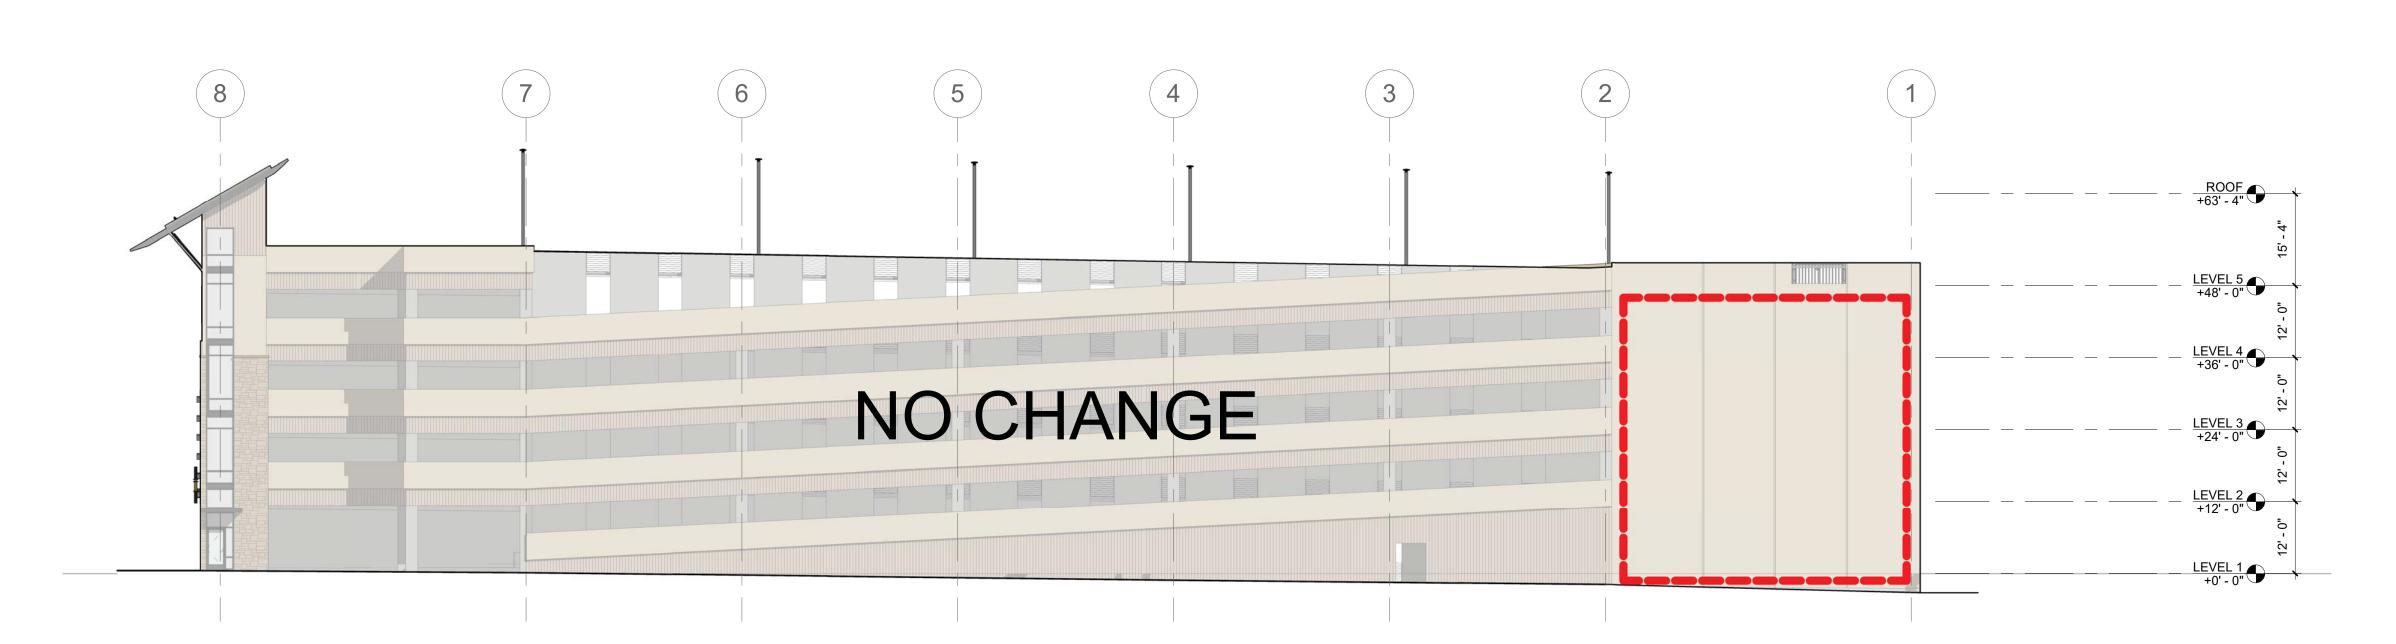

NORTH ELEVATION PHASE 1B

MATERIAL KEY

PRECAST CONCRETE, S.S.D. INTEGRAL COLOR, LIGHT ACID WASH. B.O.D. MSPRECAST MCI-229-AL

PRECAST CONCRETE, S.S.D. INTEGRAL COLOR W/ FORM LINER TEXTURE. B.O.D. SCOTT SYSTEM FORM LINER #193 MICRO FRACTURE. BID ALTERNATE #1: CUSTOM FORM LINER TEXTURE ON PRECAST CONCRETE SPANDRELS TO CREATE TREE BRANCH AESTHETIC, SEE PRECAST CONCRETE SCHEDULE SHEETS (A803, A804, A805) AND DETAIL 2/A303.

3.10 PRECAST CONCRETE LITE WALLS, S.S.D. 7.28 STANDING SEAM METAL ROOF OVER HSS RAFTERS,

32.5 METAL DOUBLE SWING GATE, PAINTED

LEGEND

AREA DESIGNATED FOR MURALS, MURALS TO REMAIN IN PHASE 1B



3.1 - PC1 PRECAST CONCRETE, INTEGRAL COLOR, LIGHT ACID WASH. **BOD: MSPRECAST MCI-229-AL GOLD BUFF**

PRECAST CONCRETE,

TEXTURE. BOD: SCOTT

MICRO FRACTURE;

SAME COLOR AS 1.01

SYSTEM FORM LINER #193

INTEGRAL COLOR, FORM LINER



7.2 - S1 ANCHORED SANDSTONE VENEER COMBINATION HONED AND FLAMED FINISH. **BOD: LYONS SANDSTONE** "PRAIRIE GOLD"

8.1 - WW1 ALUM AND GLASS

"DARK BRONZE"

ALUM AND GLASS STOREFRONT SYSTEM

8.2 - WW2

WINDOW WALL SYSTEM,



6.8 - WD1 **RECLAIMED WOOD SIDING** MFR. TERRAMAI LOST COAST REDWOOD SIDING, **WEATHERED WITH CLEAR COAT FINISH**

7.23 - ST1 STANDING SEAM METAL SIDING,

MFR. WESTERN STATES

METAL ROOFING,



FINISH: "WEATHERED RUSTIC" PVDF (SIMULATED WEATHERED STEEL)



CORRUGATED METAL ROOFING MFR. WESTERN STATES METAL ROOFING, FINISH: "GRAY ZINC MATTE"
(SIMULATED WEATHERED ZINC)

PROFILED METAL SIDING,

7.25 - MTL

MFR. PAC CLAD,

"GRAPHITE"

PROFILE BOX RIB 1,

COLOR: PAC CLAD

10.14 FIXED METAL CANOPY 32.12 PARKING STRUCTURE VEHICULAR SAFETY RAILING, 42" TALL STEEL CABLE RAIL SPACED @ 4"O.C. AT ELEVATION CHANGES BETWEEN DECKS

4.32 ACRES SIP #SP24-0010 8517 PARK MEADOWS CENTER DRIVE



OWNER:

PARK MEADOWS MALL, LLC / PARK MEADOWS ANCHOR ACQUISITION, LLC 8401 PARK MEADOWS CENTER DRIVE LONE TREE, CO 80124


1-A, 8TH AMENDMENT, LOT 4-C-1 OWS - GARAGE AND PLAZA MPROVEMENT PLAN FILING NO. TOWN CENTER PARK MEADO SITE IN PARK MEADOWS

REVISION COMMENTS


03-29-2024 1ST SUBMITTAL 05-10-2024 2ND SUBMITTAL

PROJECT #: 2022-27

EXTERIOR ELEVATIONS

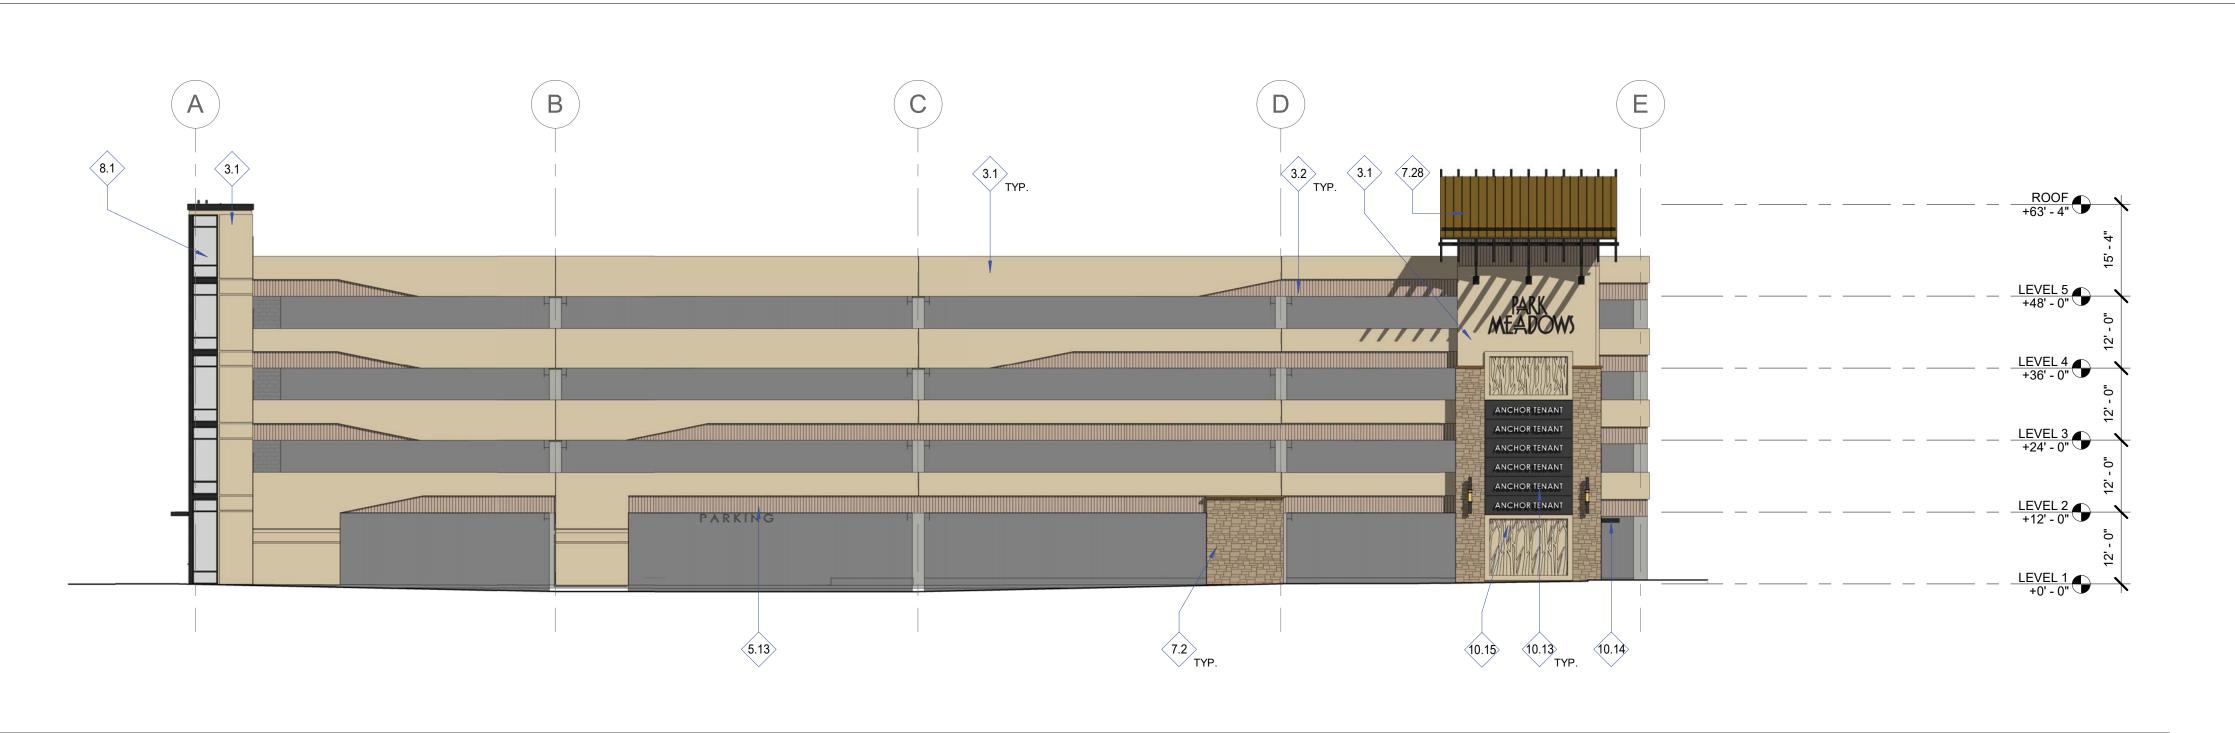

2 EAST ELEVATION PHASE 1A 1/16" = 1'-0"

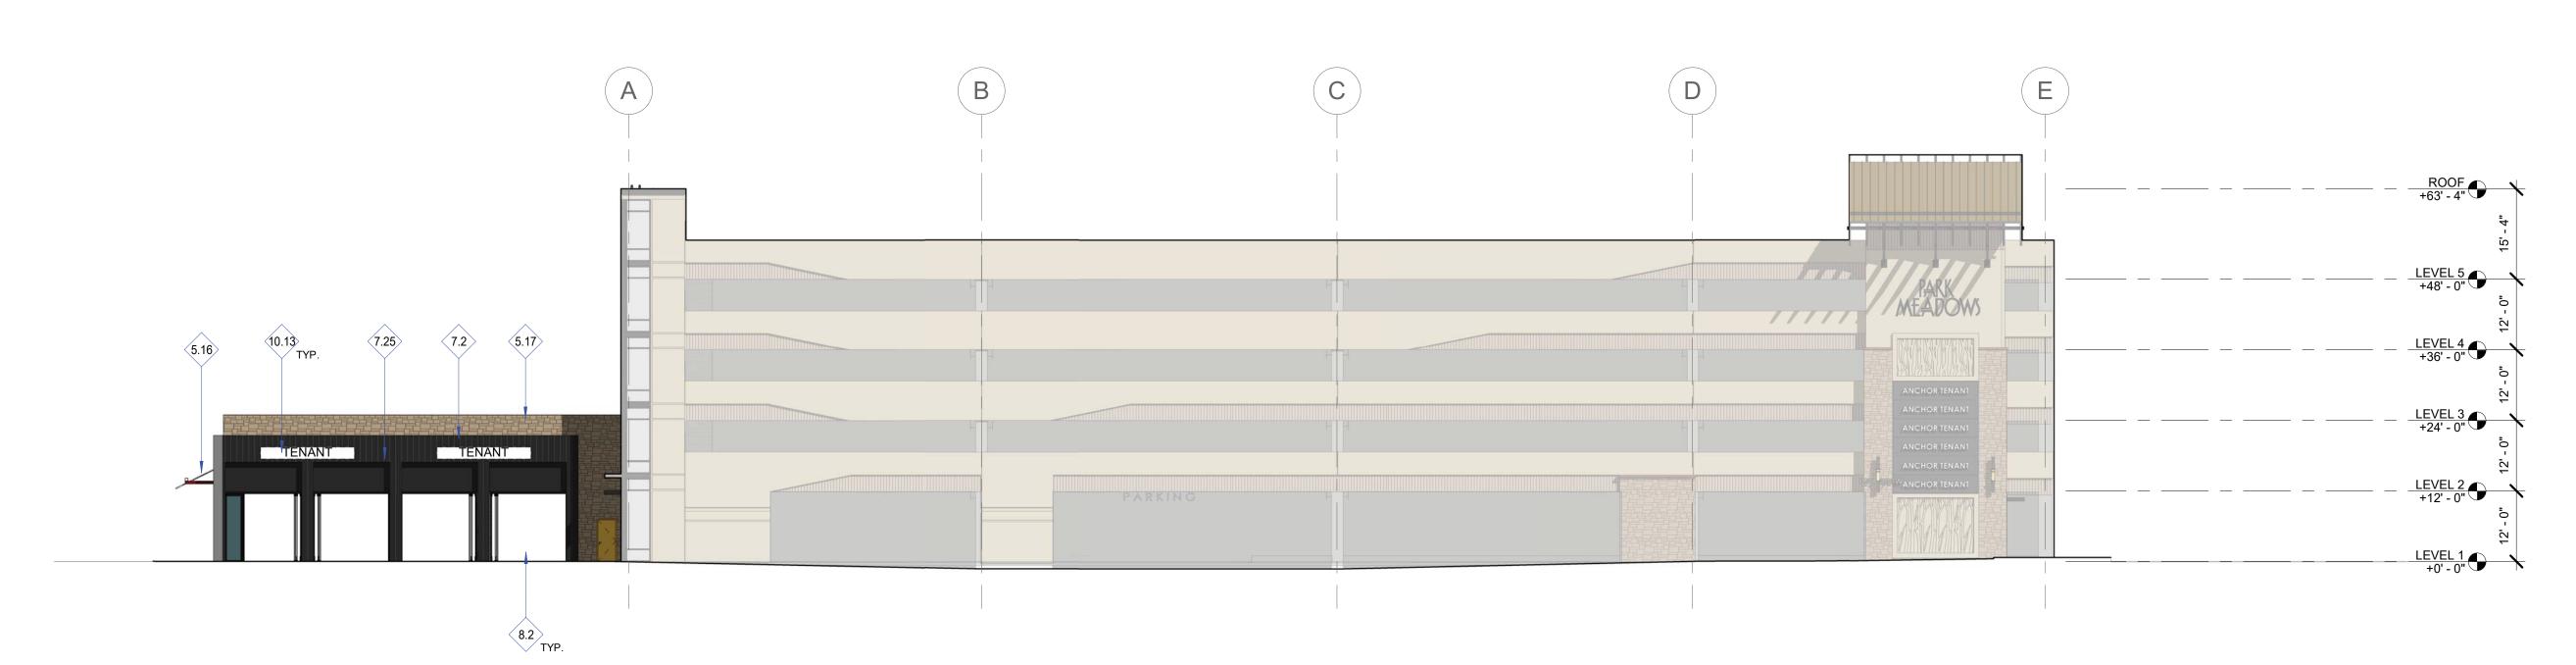

EAST ELEVATION PHASE 1B 1) <u>EAGIL</u>
1/16" = 1'-0"

MATERIAL KEY

PTD.

- 3.1 PRECAST CONCRETE, S.S.D. INTEGRAL COLOR, LIGHT ACID WASH. B.O.D. MSPRECAST MCI-229-AL
- PRECAST CONCRETE, S.S.D. INTEGRAL COLOR W/ FORM LINER TEXTURE. B.O.D. SCOTT SYSTEM FORM LINER #193 MICRO FRACTURE. BID ALTERNATE #1: CUSTOM FORM LINER TEXTURE ON PRECAST CONCRETE SPANDRELS TO CREATE TREE BRANCH AESTHETIC, SEE PRECAST CONCRETE SCHEDULE
- SHEETS (A803, A804, A805) AND DETAIL 2/A303. 5.13 HORIZONTAL TUBE STEEL RAIL FOR PARKING
- SIGNAGE MOUNTING, PTD., TYP. 5.16 METAL PANEL AWNING, PTD.
- 5.17 METAL MECHANICAL EQUIPMENT SCREEN ANCHORED SANDSTONE VENEER; COMBINATION HONED AND FLAMED FINISH. B.O.D.: LYONS SANDSTONE, PRAIRIE GOLD
- 7.25 PROFILED METAL SIDING, MFR. PAC CLAD, PROFILE BOX RIB 1, COLOR: PARC CLAD "GRAPHITE" 7.28 STANDING SEAM METAL ROOF OVER HSS RAFTERS,
- ALUMINUM AND GLASS WINDOW WALL SYSTEM. ALUMINUM AND GLASS STOREFRONT SYSTEM.

GRAPHICS DRAWINGS

B.O.D.: KAWNEER TRIFAB 451T THERMALLY BROKEN 10.13 CONCEPTUAL SIGNAGE UNDER SEPARATE PERMIT 10.14 FIXED METAL CANOPY 10.15 TREE-LIKE AESTHETIC PANEL, SEE SIGNAGE &



3.1 - PC1 PRECAST CONCRETE, INTEGRAL COLOR, LIGHT ACID WASH. **BOD: MSPRECAST MCI-229-AL GOLD BUFF**

PRECAST CONCRETE,

TEXTURE. BOD: SCOTT

MICRO FRACTURE;

SAME COLOR AS 1.01

SYSTEM FORM LINER #193

INTEGRAL COLOR, FORM LINER



7.2 - S1 **ANCHORED SANDSTONE** VENEER COMBINATION HONED AND FLAMED FINISH. **BOD: LYONS SANDSTONE** "PRAIRIE GOLD"

8.1 - WW1 ALUM AND GLASS

"DARK BRONZE"


ALUM AND GLASS

STOREFRONT SYSTEM

8.2 - WW2

WINDOW WALL SYSTEM,



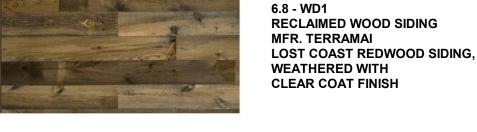







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7.24 - MTL2 **CORRUGATED METAL ROOFING** MFR. WESTERN STATES METAL ROOFING, FINISH: "GRAY ZINC MATTE" (SIMULATED WEATHERED ZINC)

PROFILED METAL SIDING,

7.25 - MTL

MFR. PAC CLAD,

"GRAPHITE"

PROFILE BOX RIB 1,

COLOR: PAC CLAD

Sheet Number 40 of 54

4.32 ACRES SIP #SP24-0010 8517 PARK MEADOWS CENTER DRIVE



OWNER:

PARK MEADOWS MALL, LLC / PARK MEADOWS ANCHOR ACQUISITION, LLC 8401 PARK MEADOWS CENTER DRIVE LONE TREE, CO 80124

1-A, 8TH AMENDMENT, LOT 4-C-1 OWS - GARAGE AND PLAZA MPROVEMENT PLAN FILING NO. PARK MEADOWS TOWN CENTER PARK MEADC SITE IN

REVISION COMMENTS

DATE Sheet

03-29-2024 1ST SUBMITTAL 05-10-2024 2ND SUBMITTAL

PROJECT #: 2022-27

EXTERIOR ELEVATIONS

Sheet Number 41 of 54

LEVEL 5 +48' - 0" 8.2 TYP. 6.8 10.13 LEVEL 4 +36' - 0" 7.2 LEVEL 3 +24' - 0" LEVEL 2 +12' - 0" LEVEL 1 +0' - 0"

WEST ELEVATION - RETAIL COMMERCIAL D2 - PHASE 1B



1 EAST ELEVATION - RETAIL COMMERCIAL D1 - PHASE 1B

MATERIAL KEY

- 5.3 AESS CANOPY, S.S.D., PAINTED RECLAIMED WOOD SIDING, MFR. TERRAMAI LOST COAST REDWOOD SIDING, WEATHERED WITH CLEAR
- COAT FINISH ANCHORED SANDSTONE VENEER; COMBINATION HONED AND FLAMED FINISH. B.O.D.: LYONS SANDSTONE, PRAIRIE GOLD
- 7.23 STANDING SEAM METAL SIDING, MFR. WESTERN STATES METAL ROOFING, FINISH: "WEATHERED RUSTIC" PVDF. SIMULATED WEATHERED STEEL
- 7.24 CORRUGATED METAL ROOF PANEL, PTD. 8.2 ALUMINUM AND GLASS STOREFRONT SYSTEM. B.O.D.: KAWNEER TRIFAB 451T THERMALLY BROKEN
- 8.8 FOLDING / SLIDING GLASS PARTITION
- 10.13 CONCEPTUAL SIGNAGE UNDER SEPARATE PERMIT



3.1 - PC1 PRECAST CONCRETE, INTEGRAL COLOR, LIGHT ACID WASH. **BOD: MSPRECAST MCI-229-AL GOLD BUFF**



7.2 - S1 **ANCHORED SANDSTONE** VENEER COMBINATION HONED AND FLAMED FINISH. **BOD: LYONS SANDSTONE** "PRAIRIE GOLD"

8.1 - WW1

8.2 - WW2

ALUM AND GLASS

"DARK BRONZE"

ALUM AND GLASS STOREFRONT SYSTEM

WINDOW WALL SYSTEM,



6.8 - WD1 RECLAIMED WOOD SIDING MFR. TERRAMAI LOST COAST REDWOOD SIDING, **WEATHERED WITH CLEAR COAT FINISH**



MFR. PAC CLAD,

"GRAPHITE"


PROFILE BOX RIB 1,

COLOR: PAC CLAD

7.25 - MTL


PROFILED METAL SIDING,

CORRUGATED METAL ROOFING MFR. WESTERN STATES METAL ROOFING, FINISH: "GRAY ZINC MATTE" (SIMULATED WEATHERED ZINC)

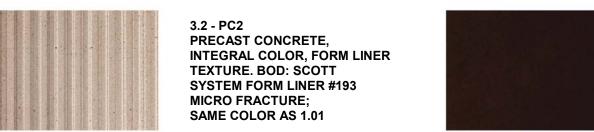





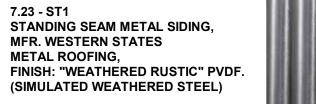

8517 PARK MEADOWS CENTER DRIVE

es architecture+ urban design 2040 Addison St, Berkeley, CA 94704 **510.549.2929 | elsarch.com**

OWNER:

PARK MEADOWS MALL, LLC / PARK MEADOWS ANCHOR ACQUISITION, LLC 8401 PARK MEADOWS CENTER DRIVE LONE TREE, CO 80124

1-A, 8TH AMENDMENT, LOT PARK MEADOWS - GARAGE AND PLAZA SITE IMPROVEMENT PLAN

PARK MEADOWS TOWN CENTER


DATE REVISION COMMENTS
Sheet


03-29-2024 1ST SUBMITTAL
05-10-2024 2ND SUBMITTAL

PROJECT #: 2022-27

AXONOMETRICS


Sheet Number 42 of 54

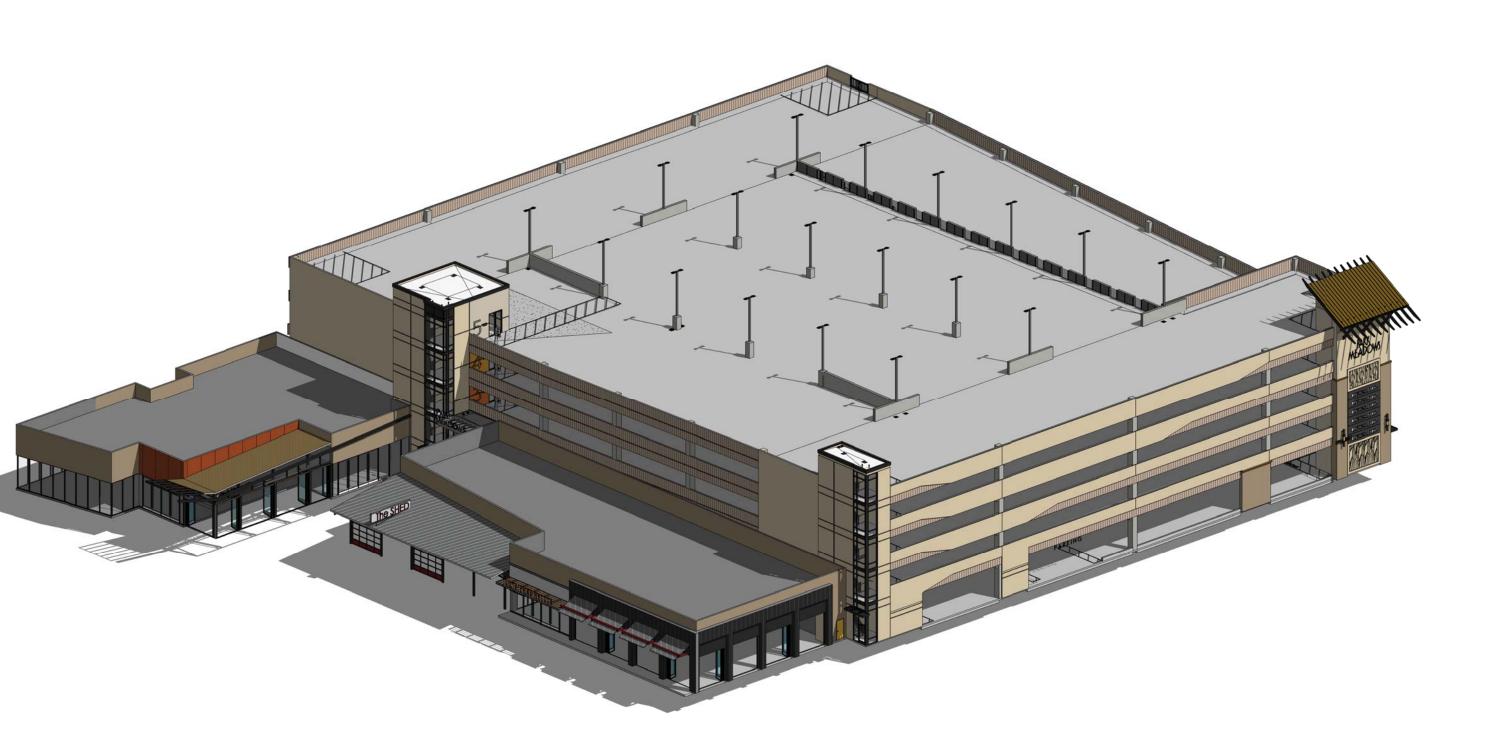

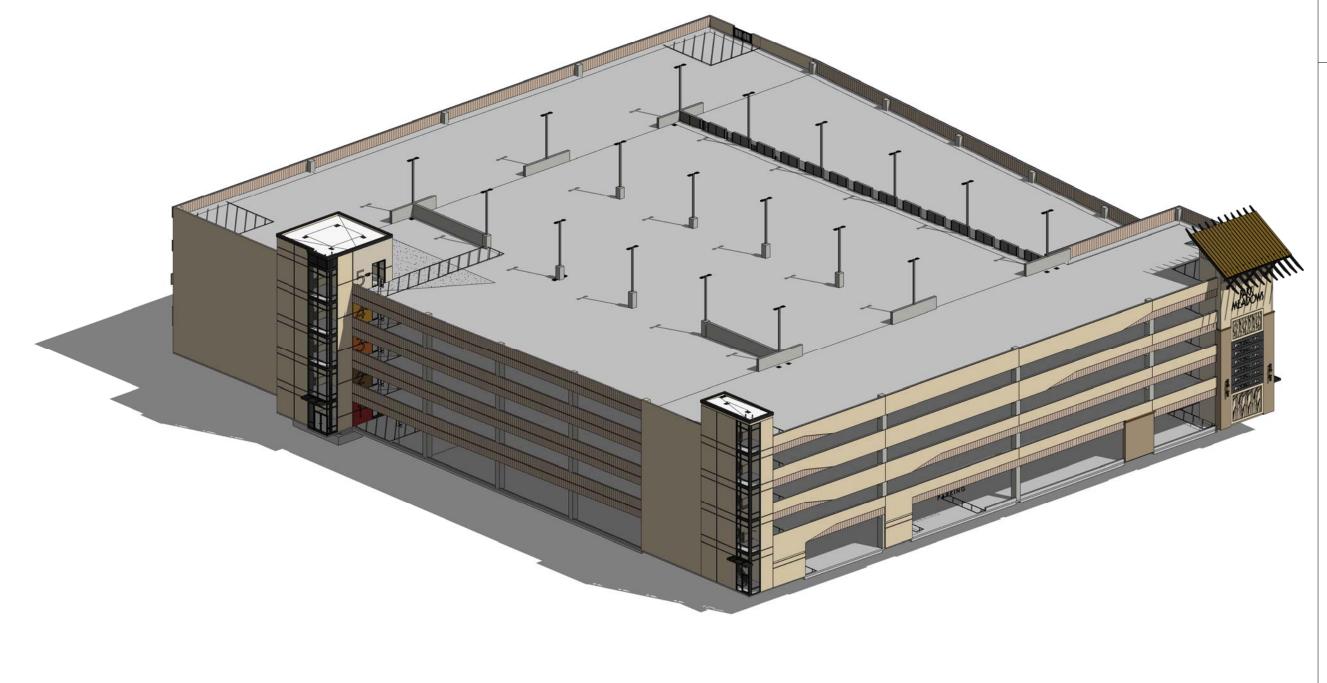

PHASE 1A_VIEW 1 N.T.S.

4 PHASE 1B_VIEW 1 N.T.S.

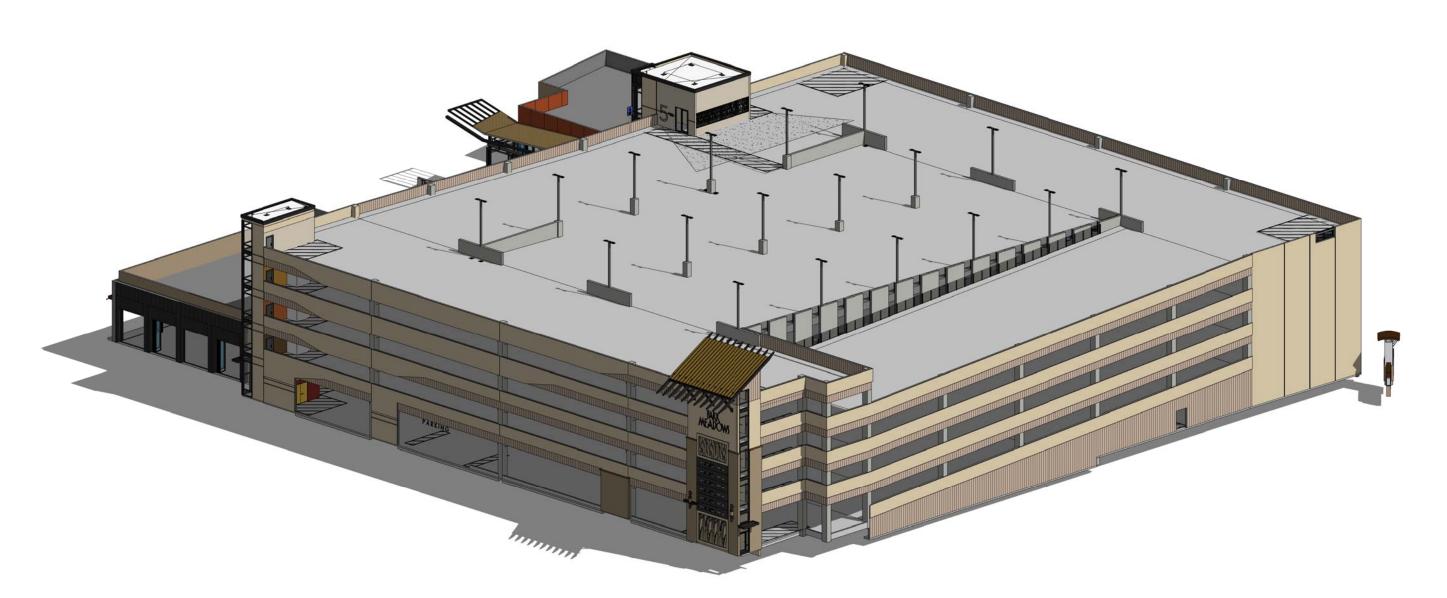

1 PHASE 1A_VIEW 2 N.T.S.

3 PHASE 1B_VIEW 2 N.T.S.

8517 PARK MEADOWS CENTER DRIVE



OWNER:

PARK MEADOWS MALL, LLC / PARK MEADOWS ANCHOR ACQUISITION, LLC 8401 PARK MEADOWS CENTER DRIVE LONE TREE, CO 80124



PARK MEADOWS - GARAGE AND PLAZA SITE IMPROVEMENT PLAN PARK MEADOWS TOWN CENTER

DATE Sheet


03-29-2024 1ST SUBMITTAL

05-10-2024 2ND SUBMITTAL


PROJECT #: 2022-27

AXONOMETRICS

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PHASE 1A_VIEW 4 N.T.S.

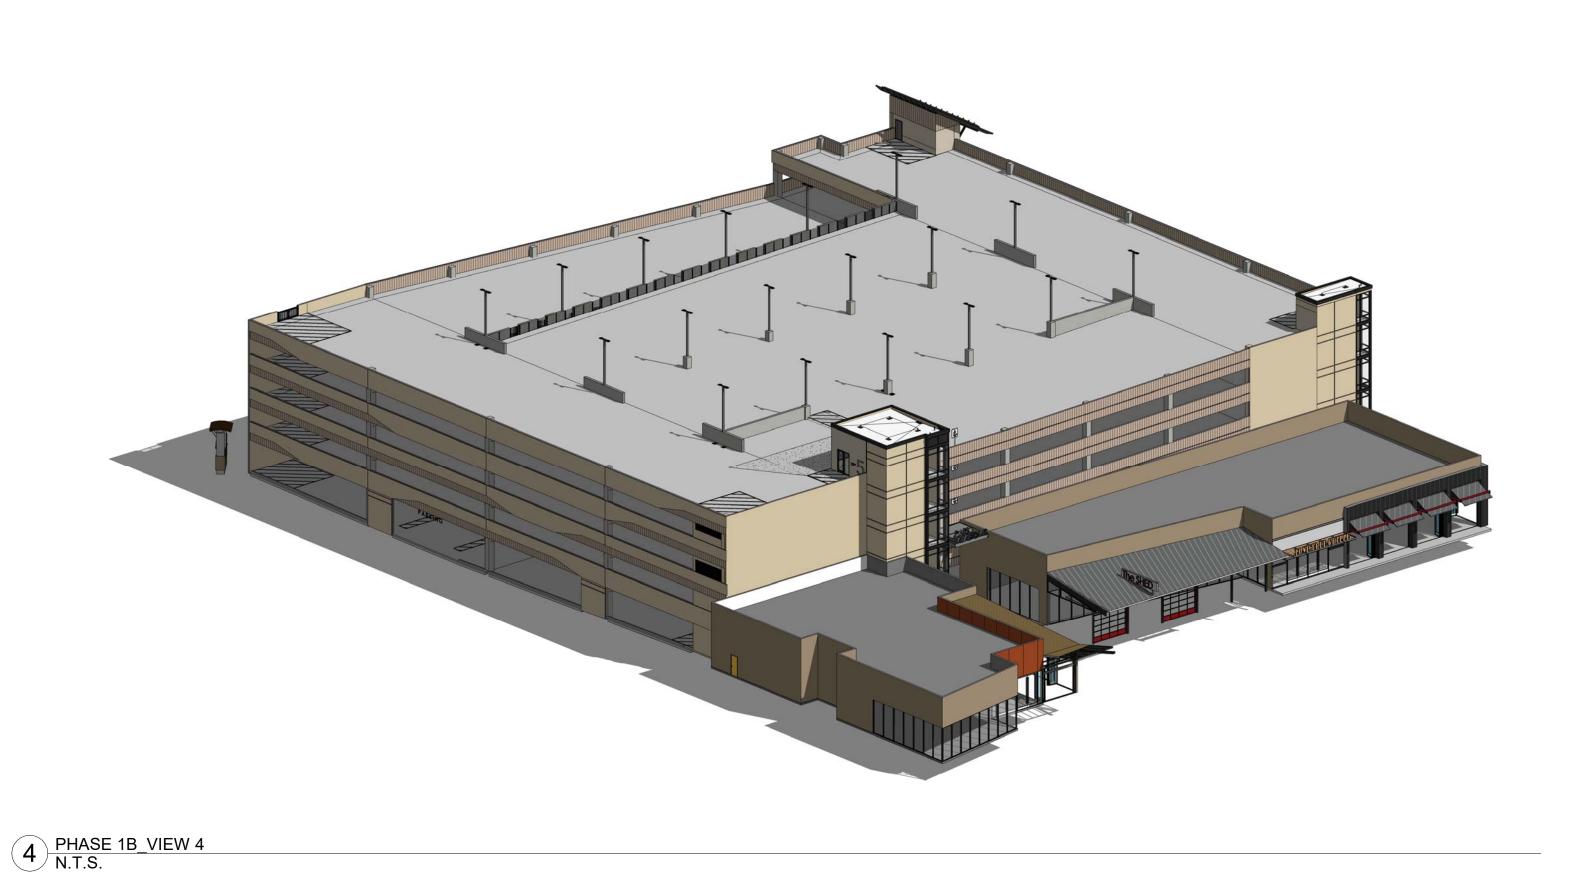

1 PHASE 1A_VIEW 3 N.T.S.

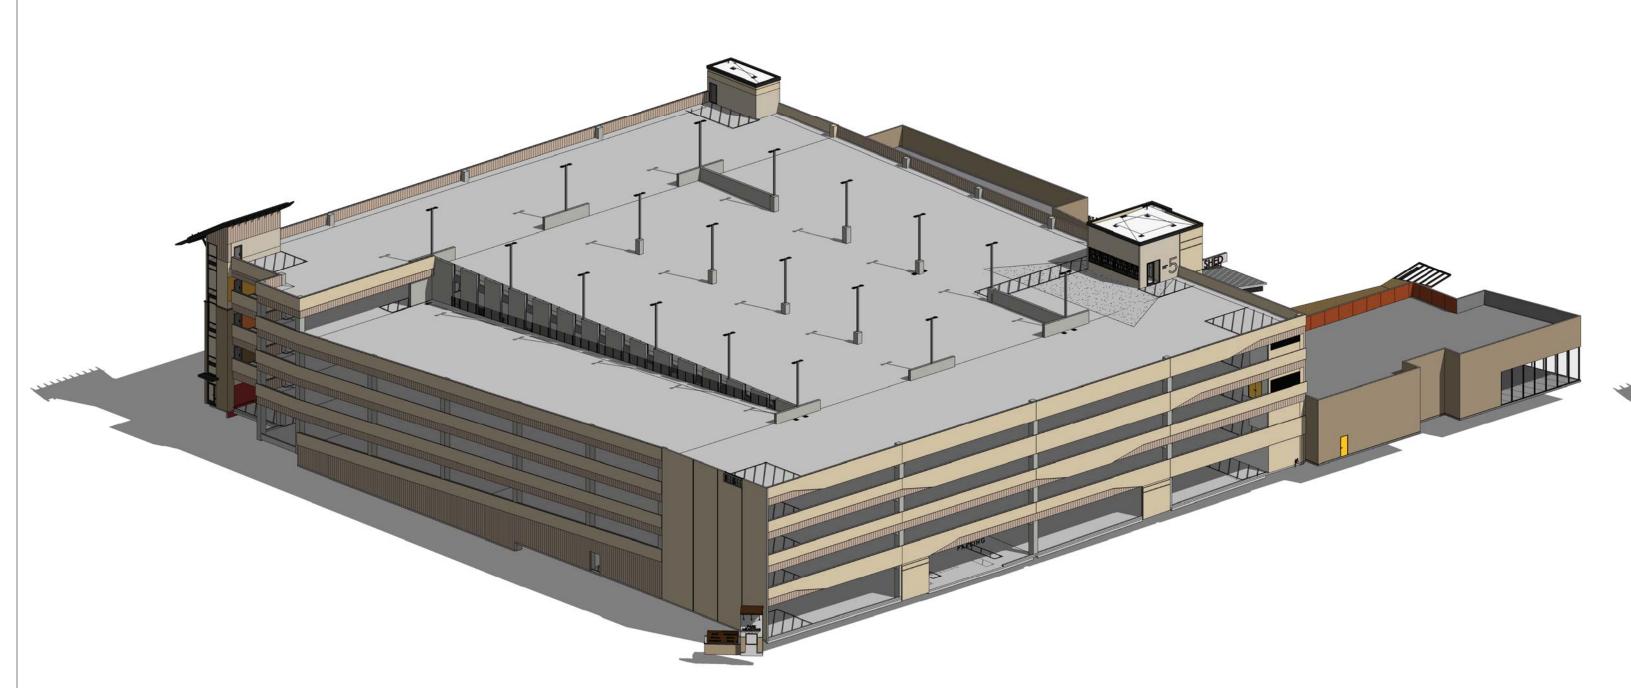3 PHASE 1B VIEW 3 N.T.S.

8517 PARK MEADOWS CENTER DRIVE



OWNER:

PARK MEADOWS MALL, LLC / PARK MEADOWS ANCHOR ACQUISITION, LLC 8401 PARK MEADOWS CENTER DRIVE LONE TREE, CO 80124

PROJECT #: 2022-27

SIP RENDERINGS -PHASE 1A

Sheet Number 44 of 54





OWNER:

PARK MEADOWS MALL, LLC / PARK MEADOWS ANCHOR ACQUISITION, LLC 8401 PARK MEADOWS CENTER DRIVE LONE TREE, CO 80124

PARK MEADOWS TOWN CENTER FILING NO. 1-A, 8TH AMENDMENT, LOT 4-C-1

PARK MEADOWS - GARAGE AND PLAZA SITE IMPROVEMENT PLAN

REVISION COMMENTS
Sheet

03-29-2024 1ST SUBMITTAL

05-10-2024 2ND SUBMITTAL

PROJECT #: 2022-27

SIP RENDERINGS -

Sheet Number 45 of 54

PHASE 1A



8517 PARK MEADOWS CENTER DRIVE



OWNER:

PARK MEADOWS MALL, LLC / PARK MEADOWS ANCHOR ACQUISITION, LLC 8401 PARK MEADOWS CENTER DRIVE LONE TREE, CO 80124

PARK MEADOWS TOWN CENTER FILING NO. 1-A, 8TH AMENDMENT, LOT 4-C-1

PARK MEADOWS - GARAGE AND PLAZA SITE IMPROVEMENT PLAN

> SIP RENDERINGS -PHASE 1A

Sheet Number 46 of 54





OWNER:

PARK MEADOWS MALL, LLC / PARK MEADOWS ANCHOR ACQUISITION, LLC 8401 PARK MEADOWS CENTER DRIVE LONE TREE, CO 80124

TOWN CENTER FILING NO. 1-A, 8TH AMENDMENT, LOT 4-C-1 OWS - GARAGE AND PLAZA MPROVEMENT PLAN

SIP RENDERINGS -PHASE 1B

Sheet Number 47 of 54





OWNER:

PARK MEADOWS MALL, LLC / PARK MEADOWS ANCHOR ACQUISITION, LLC 8401 PARK MEADOWS CENTER DRIVE LONE TREE, CO 80124

PARK MEADOWS TOWN CENTER FILING NO. 1-A, 8TH AMENDMENT, LOT 4-C-1

PARK MEADOWS TOWN CENTER FILING NO. 1-A, 8TH AN PARK MEADOWS - GARAGE AND PLAZA SITE IMPROVEMENT PLAN

DATE Sheet

03-29-2024 1ST SUBMITTAL

05-10-2024 2ND SUBMITTAL

PROJECT #: 2022-27

SIP RENDERINGS -PHASE 1B

Sheet Number 48 of 54





OWNER:

PARK MEADOWS MALL, LLC / PARK MEADOWS ANCHOR ACQUISITION, LLC 8401 PARK MEADOWS CENTER DRIVE LONE TREE, CO 80124

PARK MEADOWS TOWN CENTER FILING NO. 1-A, 8TH AMENDMENT, LOT 4-C-1

OWS - GARAGE AND PLAZA MPROVEMENT PLAN

SIP RENDERINGS -PHASE 1B

Sheet Number 49 of 54





OWNER:

PARK MEADOWS MALL, LLC / PARK MEADOWS ANCHOR ACQUISITION, LLC 8401 PARK MEADOWS CENTER DRIVE LONE TREE, CO 80124

PARK MEADOWS TOWN CENTER FILING NO. 1-A, 8TH AMENDMENT, LOT 4-C-1

OWS - GARAGE AND PLAZA MPROVEMENT PLAN



REVISION COMMENTS

DATE Sheet

29-2024 1ST SUBMITTAL

03-29-2024 | 1ST SUBMITTAL 05-10-2024 | 2ND SUBMITTAL

PROJECT #: 2022-27

SIP RENDERINGS -PHASE 1B

Sheet Number 50 of 54

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OWNER:

PARK MEADOWS MALL, LLC / PARK MEADOWS ANCHOR ACQUISITION, LLC 8401 PARK MEADOWS CENTER DRIVE LONE TREE, CO 80124

PARK MEADOWS - GARAGE AND PLAZA SITE IMPROVEMENT PLAN

DATE Sheet

03-29-2024 1ST SUBMITTAL

05-10-2024 2ND SUBMITTAL

PROJECT #: 2022-27

SIP RENDERINGS -PHASE 1B

Sheet Number 51 of 54



8517 PARK MEADOWS CENTER DRIVE



OWNER:

PARK MEADOWS MALL, LLC / PARK MEADOWS ANCHOR ACQUISITION, LLC 8401 PARK MEADOWS CENTER DRIVE LONE TREE, CO 80124

DATE REVISION COMMENTS
Sheet
03-29-2024 1ST SUBMITTAL
05-10-2024 2ND SUBMITTAL

SIP RENDERINGS -PHASE 1B

Sheet Number 52 of 54



8517 PARK MEADOWS CENTER DRIVE



OWNER:

PARK MEADOWS MALL, LLC / PARK MEADOWS ANCHOR ACQUISITION, LLC 8401 PARK MEADOWS CENTER DRIVE LONE TREE, CO 80124

8TH AMENDMENT, LOT OWS - GARAGE AND PLAZA MPROVEMENT PLAN FILING NO. TOWN CENTER PARK MEADOWS



REVISION COMMENTS DATE Sheet 03-29-2024 1ST SUBMITTAL

05-10-2024 2ND SUBMITTAL

MATERIAL KEY

- 6.7 RECLAIMED WOOD SOFFIT CLADDING 7.2 ANCHORED SANDSTONE VENEER; COMBINATION HONED AND FLAMED FINISH. B.O.D.: LYONS SANDSTONE, PRAIRIE GOLD
- 7.24 CORRUGATED METAL ROOF PANEL, PTD. 7.25 PROFILED METAL SIDING, MFR. PAC CLAD, PROFILE BOX RIB 1, COLOR: PARC CLAD "GRAPHITE"
- 8.12 PAINTED METAL ROLL-UP DOORS WITH CLEAR GLASS INSERTS

PROJECT #: 2022-27 7.23 STANDING SEAM METAL SIDING, MFR. WESTERN STATES METAL ROOFING, FINISH: "WEATHERED MATERIALS RUSTIC" PVDF. SIMULATED WEATHERED STEEL

> **Sheet Number** 53 of 54

BOARD




7.2 - S1 ANCHORED SANDSTONE VENEER COMBINATION


HONED AND FLAMED FINISH.
BOD: LYONS SANDSTONE
"PRAIRIE GOLD"









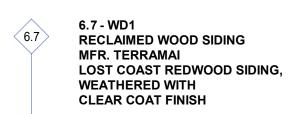

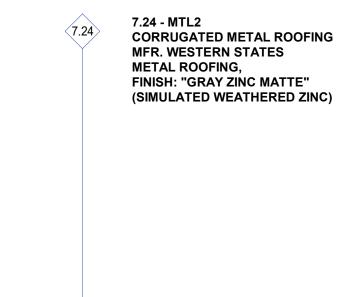

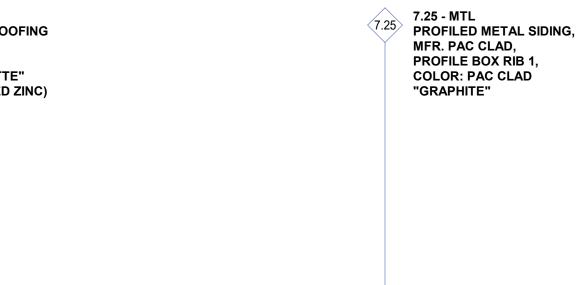

1 EAST ELEVATION - RETAIL 1" = 10'-0"

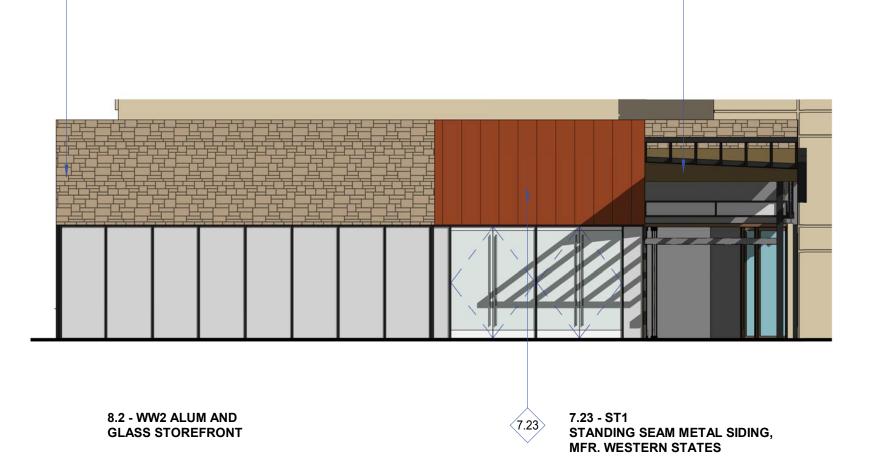


7.23


METAL ROOFING,

FINISH: "WEATHERED RUSTIC" PVDF.

(SIMULATED WEATHERED STEEL)

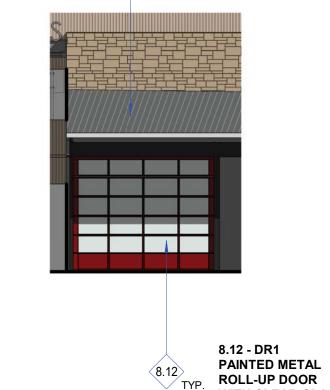



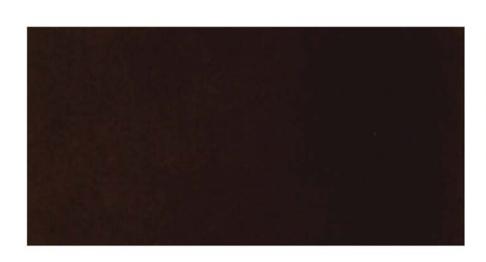





WITH CLEAR GLASS

INSERTS


2 SOUTH ELEVATION - SECTIONAL DOOR 1" = 10'-0"


3 SOUTH ELEVATION - RETAIL
1" = 10'-0"

GLASS STOREFRONT

8517 PARK MEADOWS CENTER DRIVE



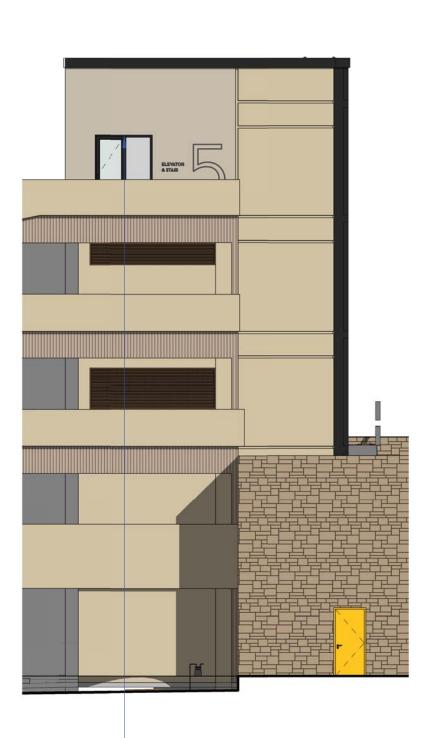

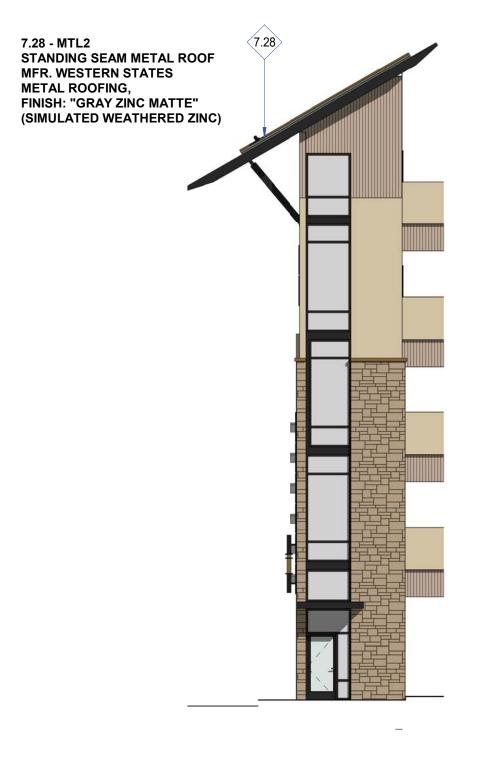











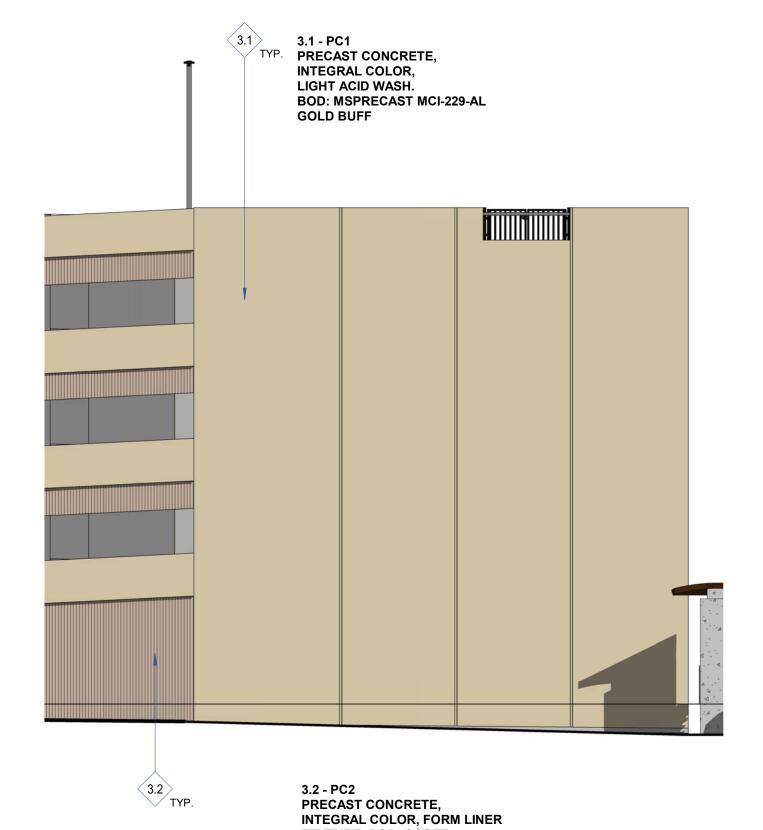

TEXTURE. BOD: SCOTT SYSTEM FORM LINER #193

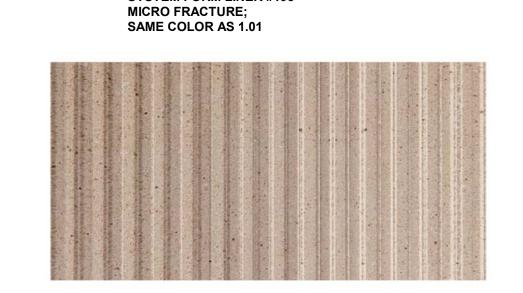

1 NORTH ELEVATION - GARAGE 1" = 10'-0"

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OWNER:

PARK MEADOWS MALL, LLC / PARK MEADOWS ANCHOR ACQUISITION, LLC 8401 PARK MEADOWS CENTER DRIVE LONE TREE, CO 80124

1-A, 8TH AMENDMENT, LOT 4-C-PARK MEADOWS - GARAGE AND PLAZA SITE IMPROVEMENT PLAN FILING NO. PARK MEADOWS TOWN CENTER

REVISION COMMENTS
DATE Sheet 03-29-2024 1ST SUBMITTAL 05-10-2024 2ND SUBMITTAL

PROJECT #: 2022-27

MATERIALS BOARD

Sheet Number 54 of 54

MATERIAL KEY

3.1 PRECAST CONCRETE, S.S.D. INTEGRAL COLOR, LIGHT AVID WASH. B.O.D. MSPRECAST MCI-229-AL

PRECAST CONCRETE, S.S.D. INTEGRAL COLOR W/FORM LINER TEXTURE. B.O.D. SCOTT SYSTEM FORM LINER #193 MICRO FRACTURE. BID ALTERNATE #1: CUSTOM FORM LINER TEXTURE ON PRECAST CONCRETE SPANDRELS TO CREATE TREE BRANCH AESTHETIC, SEE PRECAST CONCRETE SCHEDULE SHEETS (A803, A804, A805) AND DETAIL 2/A303.

7.28 STANDING SEAM METAL ROOF OVER HSS RAFTERS,

ALUMINUM AND GLASS STOREFRONT SYSTEM. B.O.D.: KAWNEER TRIFAB 451T THERMALLY BROKEN

