DEPARTMENT OF TRANSPORTATION STATE OF COLORADO


HIGHWAY CONSTRUCTION BID PLANS OF PROPOSED FEDERAL AID PROJECT NO. 267 0252-499 I-25 MOBILITY HUB (LONE TREE)

DOUGLAS COUNTY CONSTRUCTION PROJECT CODE NO. 24278

SHEET NO.	
1	TITLE SHEET
2-8	SITE PLAN
9-15	GRADING PLAN
16	LANDSCAPE/IRRIGATION PLAN
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CONCEPTUAL RENDERING



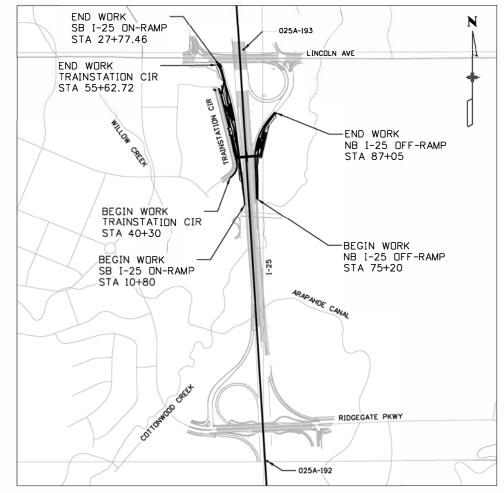

- 1. THE PROPERTY DESCRIBED HEREIN IS SUBJECT TO ALL APPLICABLE REQUIREMENTS OF THE LONE TREE ZONING CODE AND DESIGN STANDARDS, INCLUDING BUT NOT LIMITED TO, PROPERTY MAINTENANCE, LIGHTING, PARKING, SIGNAGE, LANDSCAPING AND OUTDOOR STORAGE, EXCEPT AS MAY OTHERWISE BE ADDRESSED IN AN APPROVED PLANNED DEVELOPMENT PLAN, SUBAREA PLAN, OR OTHER APPLICABLE PLAN OR AGREEMENT APPROVED BY THE CITY.
- 2. THE APPLICANT ASSUMES RESPONSIBILITY TO ENSURE THE PROJECT IS COMPLETED IN ACCORDANCE WITH THE APPROVED SIP AND ANY ASSOCIATED MATERIALS SAMPLE BOARDS AND FURTHER ASSUMES THE RISK ASSOCIATED WITH ANY CHANGES OR OMISSIONS MADE WITHOUT PRIOR CITY APPROVAL. MODIFICATIONS TO STRUCTURES OR SITES MAY REQUIRE AN AMENDMENT TO THE SIP AS DETERMINED BY THE CITY'S COMMUNITY DEVELOPMENT DIRECTOR, PER SEC. 16-27-180. UNAUTHORIZED CHANGES OR OMISSIONS MADE WITHOUT PRIOR CITY APPROVAL CORRECTIVE ACTIONS, DELAY OF PERMITS OR CITATIONS FOR ZONING VIOLATIONS WITH ASSOCIATED FINES AND LEGAL MEASURES. BUILDING PLANS SHALL CONFORM TO THE APPROVED SIP. 3. WITHIN SITE TRIANGLES, AS SHOWN, LIMITED LANDSCAPING SHALL BE ALLOWED WITH NO SOLID STRUCTURES PERMITTED AS STATED IN THE CITY OF LONE TREE'S LANDSCAPE DESIGN GUIDELINES AND STANDARDS FOR LANDSCAPING. LANDSCAPING WITHIN THE SIGHT TRIANGLE SHALL BE MAINTAINED BY THE PROPERTY OWNER OR APPROPRIATE ASSOCIATION OR DISTRICT, AS MAY BE IDENTIFIED IN MAINTENANCE AGREEMENTS RECORDED WITH THE DOUGLAS COUNTY CLERK AND RECORDER'S
- 4. THE OWNER IS RESPONSIBLE FOR THE INSTALLATION OF ALL ROADWAY SIGNAGE, INCLUDING "NO PARKING/FIRE LANE" SIGNAGE, AS REQUIRED BY THE CITY PUBLIC WORKS DEPARTMENT AND/OR THE FIRE DISTRICT. SUCH SIGNAGE SHALL BE MAINTAINED BY THE PROPERTY OWNER OR APPROPRIATE ASSOCIATION OR DISTRICT, AS MAY BE IDENTIFIED IN MAINTENANCE AGREEMENTS RECORDED WITH THE DOUGLAS COUNTY CLERK AND RECORDER'S OFFICE.
- 5. SITE LANDSCAPING, SITE AMENITIES AND FURNISHINGS, AND ALL SITE IMPROVEMENTS INCLUDING, BUT NOT LIMITED TO, SIDEWALKS AND PARKING AREAS SHALL BE MAINTAINED IN A STATE OF GOOD REPAIR CONSISTENT WITH THE APPROVED SIP AND THE LONE TREE MUNICIPAL CODE AND DESIGN GUIDELINES AND STANDARDS. SUCH MAINTENANCE SHALL INCLUDE THE REGULAR MAINTENANCE OF PET WASTE STATIONS (WHEN PRESENT), TO INCLUDE WASTE COLLECTION AND WASTE BAG REPLACEMENT. LANDSCAPE PLANTINGS MUST BE ALIVE AND ALL IRRIGATION MUST BE FUNCTIONAL. ALL MAINTENANCE OBLIGATIONS SHALL BE COMPLETED BY THE PROPERTY OWNER OR APPROPRIATE ASSOCIATION OR DISTRICT, AS MAY BE IDENTIFIED IN MAINTENANCE AGREEMENTS RECORDED WITH THE DOUGLAS COUNTY CLERK AND RECORDER'S OFFICE.
- 6. THE CITY OF LONE TREE REQUIRES THAT MAINTENANCE ACCESS BE PROVIDED TO ALL STORM DRAINAGE FACILITIES TO ASSURE CONTINUOUS OPERATIONAL CAPABILITY OF THE SYSTEM. THE PROPERTY OWNER SHALL BE RESPONSIBLE FOR THE MAINTENANCE OF ALL DRAINAGE FACILITIES, INCLUDING INLETS, PIPES, CULVERTS, CHANNELS, DITCHES, HYDRAULIC STRUCTURES AND DETENTION BASINS LOCATED ON THEIR LAND UNLESS MODIFIED BY THE SITE IMPROVEMENT PLAN IMPROVEMENTS AGREEMENT. SHOULD THE OWNER FAIL TO ADEQUATELY MAINTAIN SAID FACILITIES, THE CITY OF LONE TREE SHALL HAVE THE RIGHT TO ENTER SAID LAND FOR THE PURPOSES OF OPERATIONS AND MAINTENANCE. ALL SUCH MAINTENANCE COSTS WILL BE ASSESSED TO THE PROPERTY OWNER OR THE RESPONSIBLE MAINTENANCE AUTHORITY.
- 7. ALL PLANTS INSTALLED SHALL FOLLOW THE PLANT SCHEDULE, INSTALLATION INSTRUCTIONS AND THE LANDSCAPE DRAWINGS ON THE APPROVED LANDSCAPE PLAN INCLUDED IN THIS SITE IMPROVEMENT PLAN. ANY CHANGES TO THE APPROVED LANDSCAPE PLAN, TO INCLUDE PLANT SUBSTITUTIONS, MUST BE APPROVED BY THE CITY IN ADVANCE OF INSTALLATION.
- 8. ACCORDING TO THE FEDERAL EMERGENCY MANAGEMENT AGENCY, NATIONAL FLOOD INSURANCE PROGRAM, FLOOD INSURANCE RATE MAP FOR THE CITY OF LONE TREE, DOUGLAS COUNTY, COLORADO COMMUNITY PANEL 08035C0061H, DATED 02/17/2017, THE SUBJECT PROPERTY LIES WITHIN ZONE AE, "AREAS DETERMINED TO BE INSIDE/OUTSIDE OF THE 0.2% ANNUAL CHANCE FLOOD.
- 9. UTILITY PLANS WILL BE SHOWN ONLY IN FULL CONSTRUCTION DOCUMENT PLAN SETS ASSOCIATED WITH THIS SITE IMPROVEMENT PLAN PROJECT.

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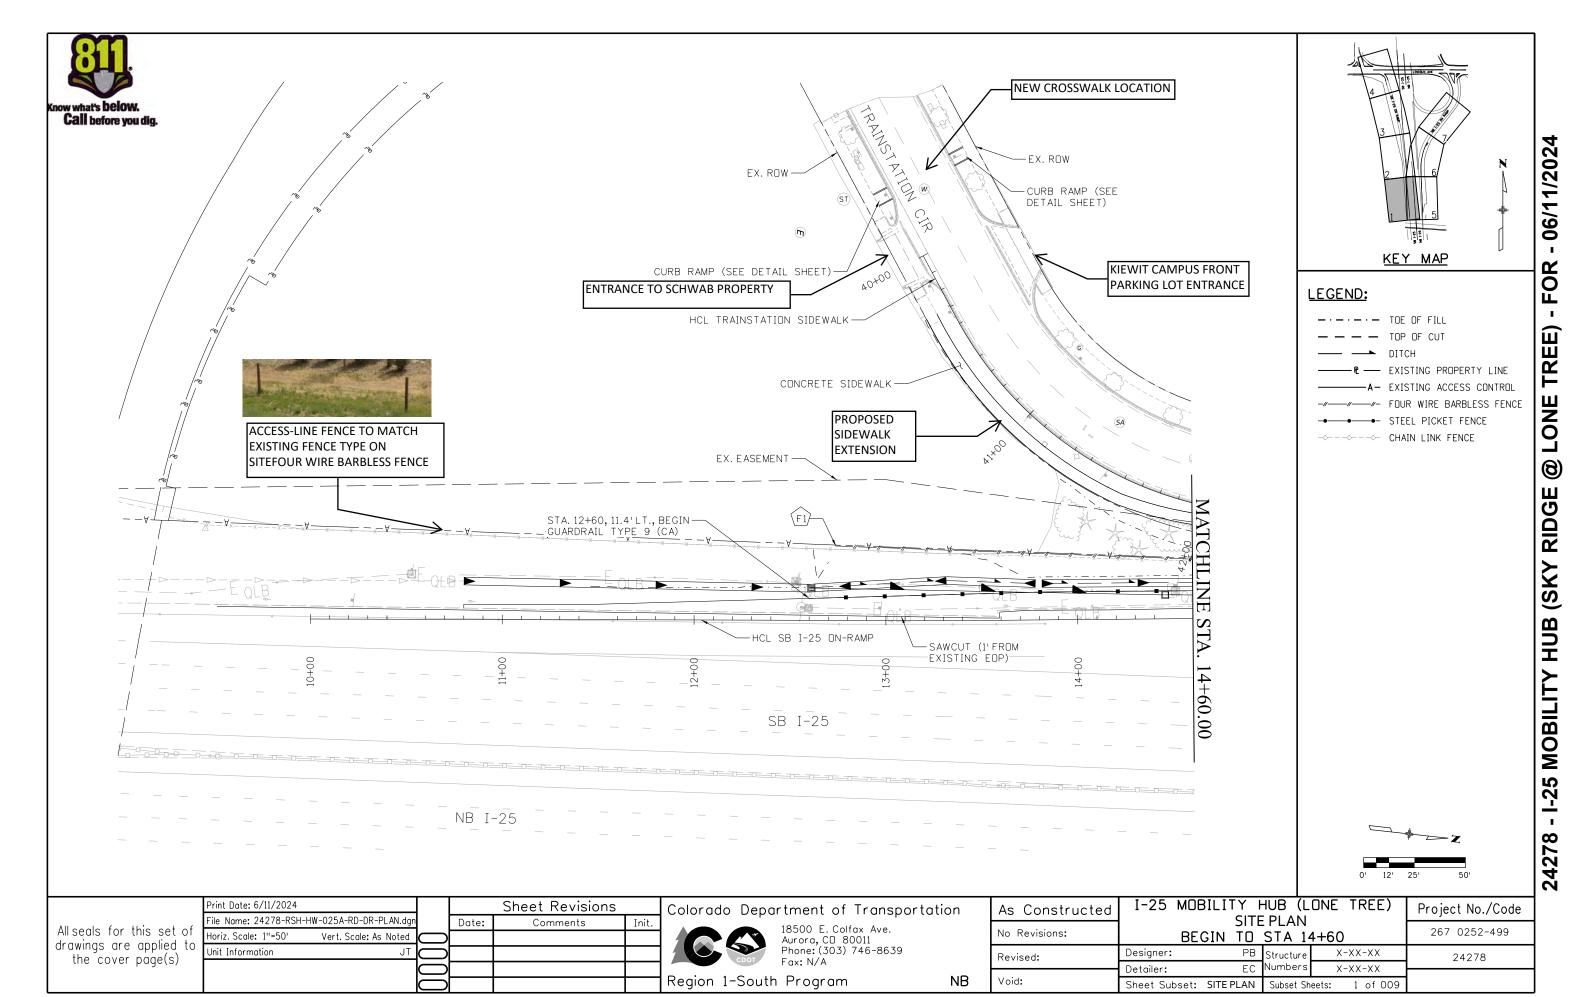
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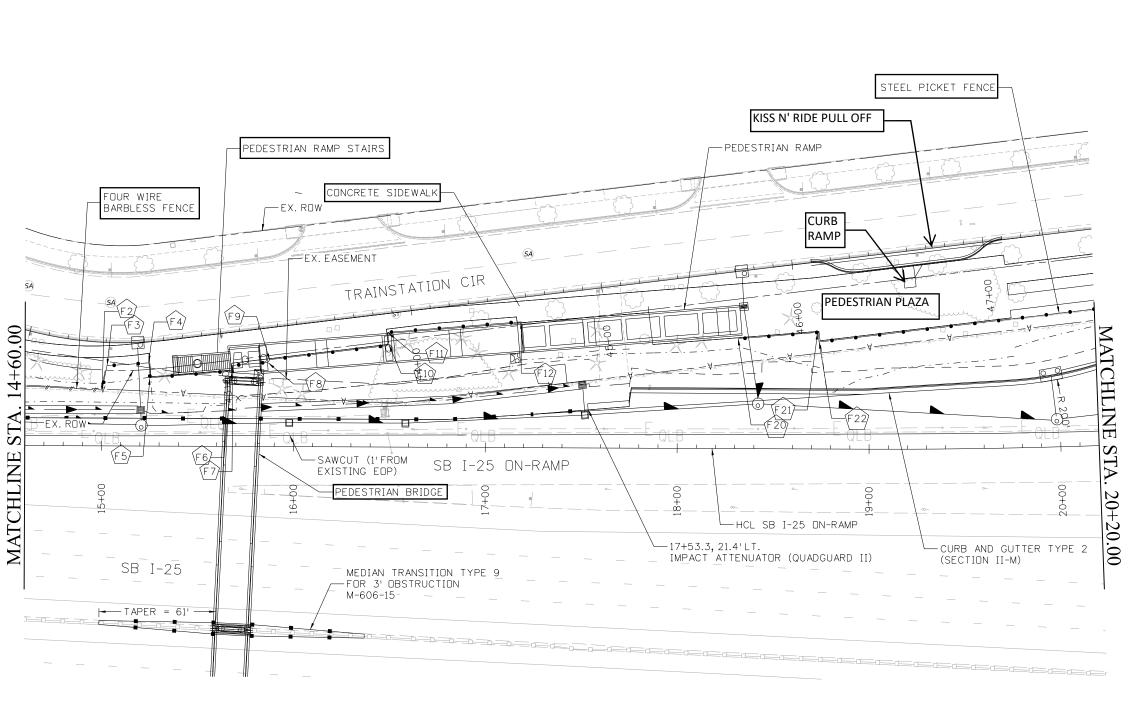
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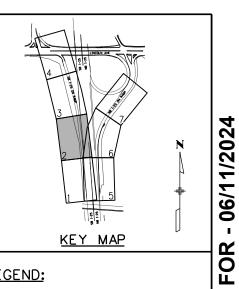
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LEGEND:

-·- TOE OF FILL DITCH EXISTING PROPERTY LINE -A- EXISTING ACCESS CONTROL -/- FOUR WIRE BARBLESS FENCE --- STEEL PICKET FENCE

→-
CHAIN LINK FENCE

TREE)

LONE

(B)

- I-25 MOBILITY HUB (SKY RIDGE

24278 ·

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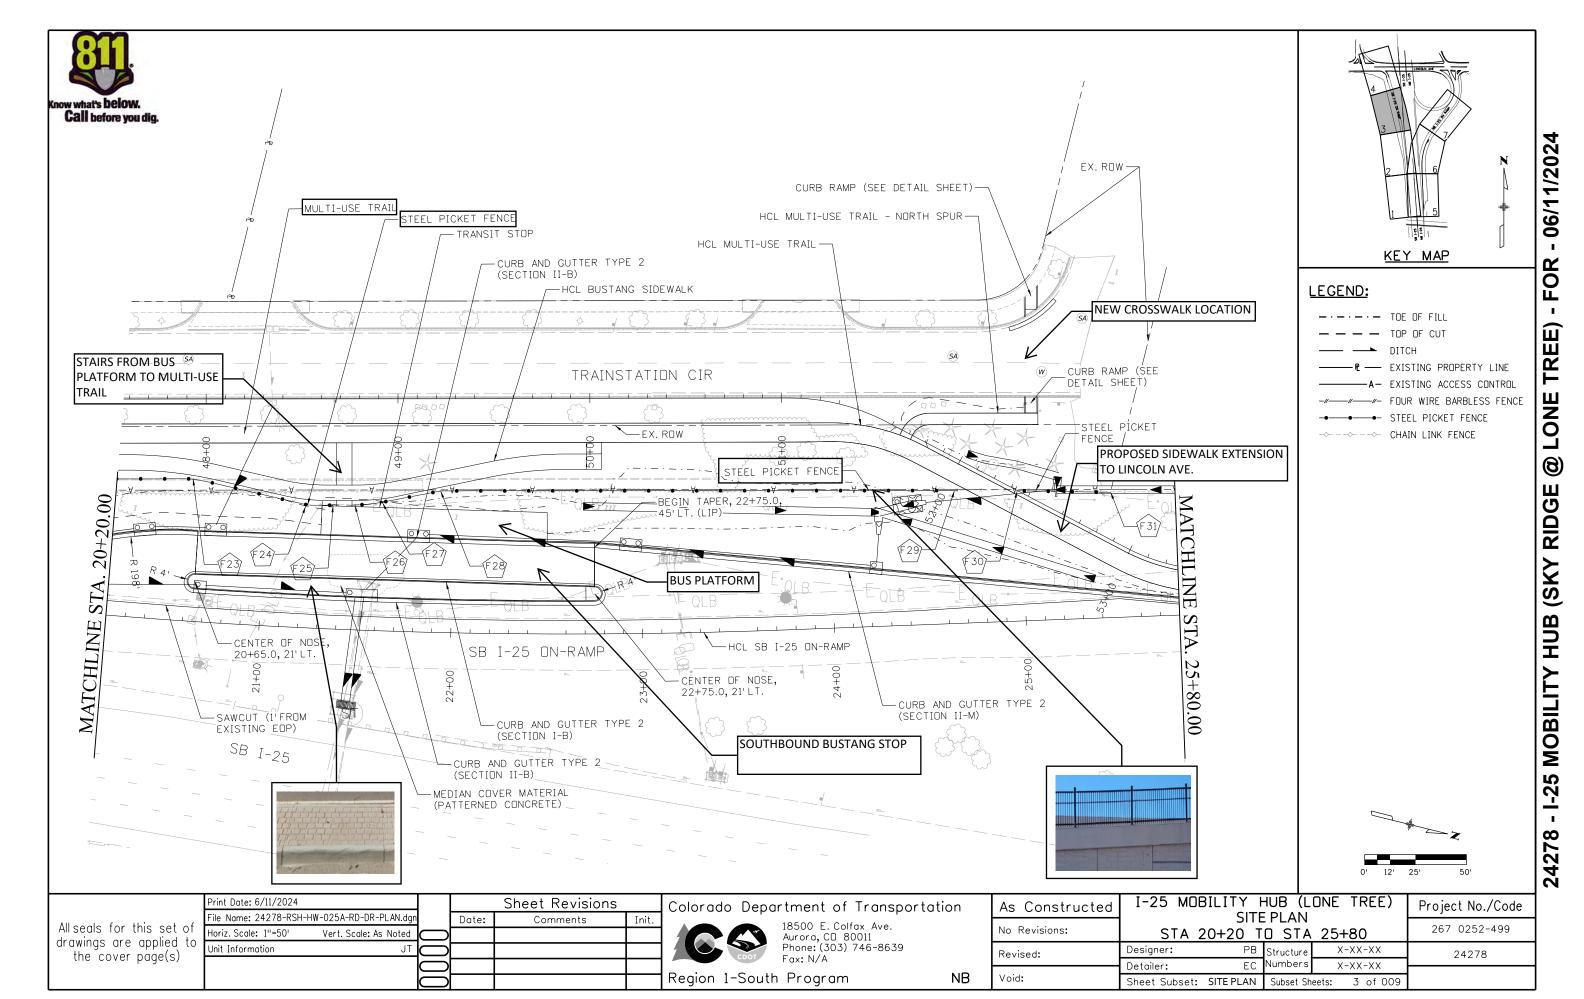
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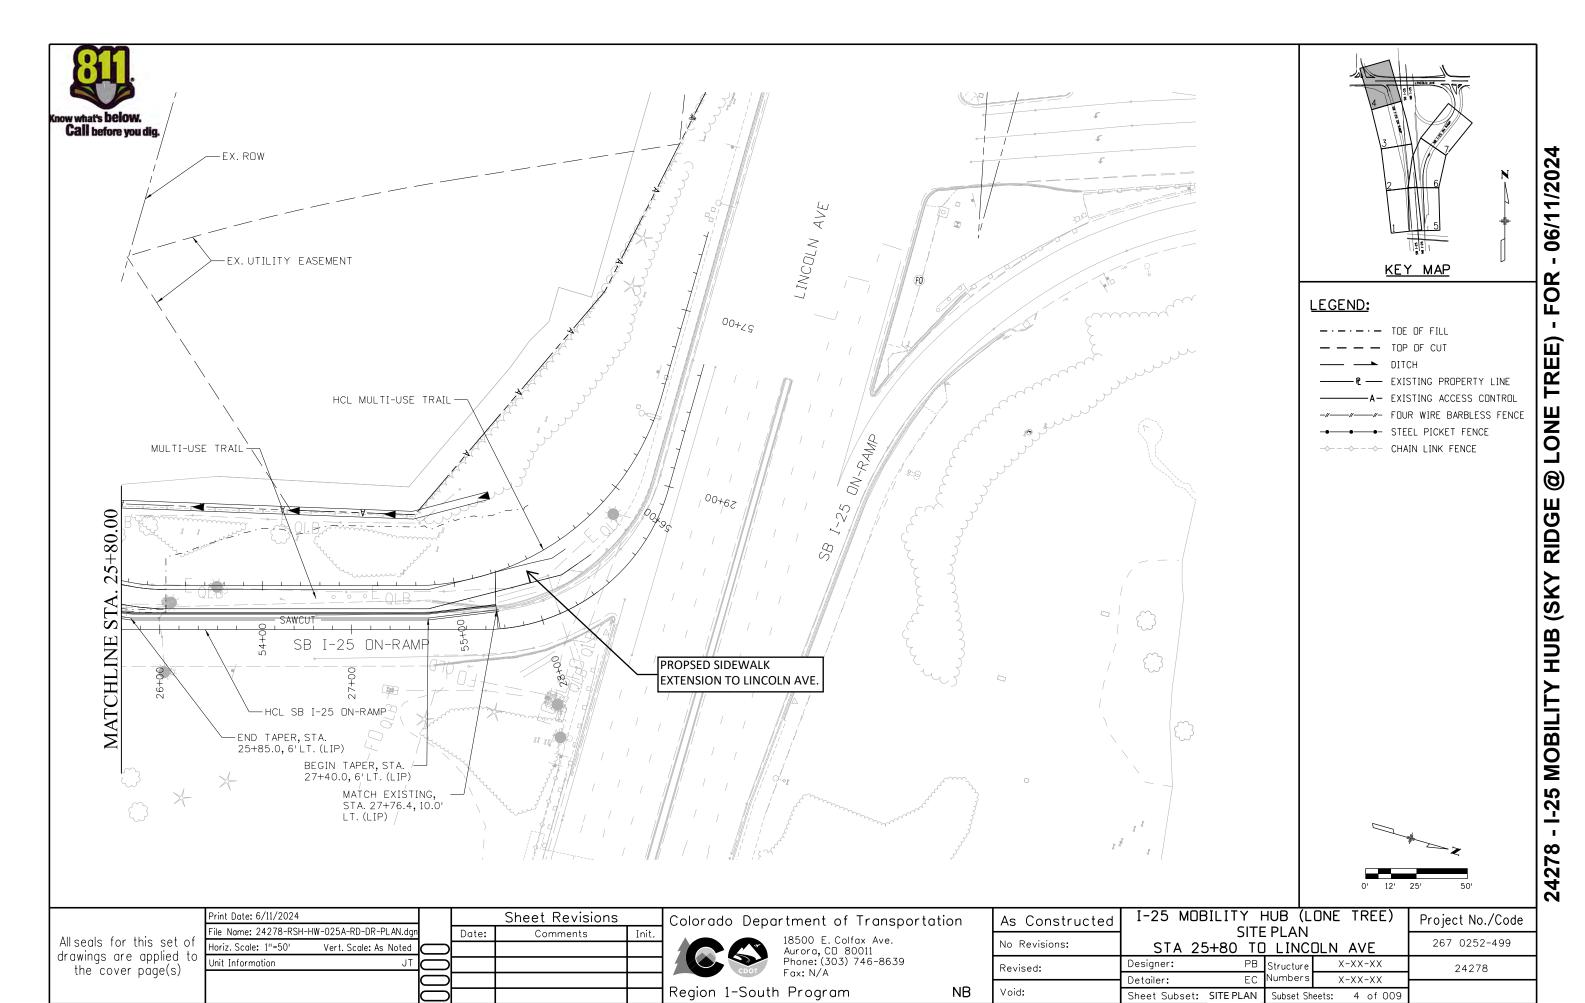
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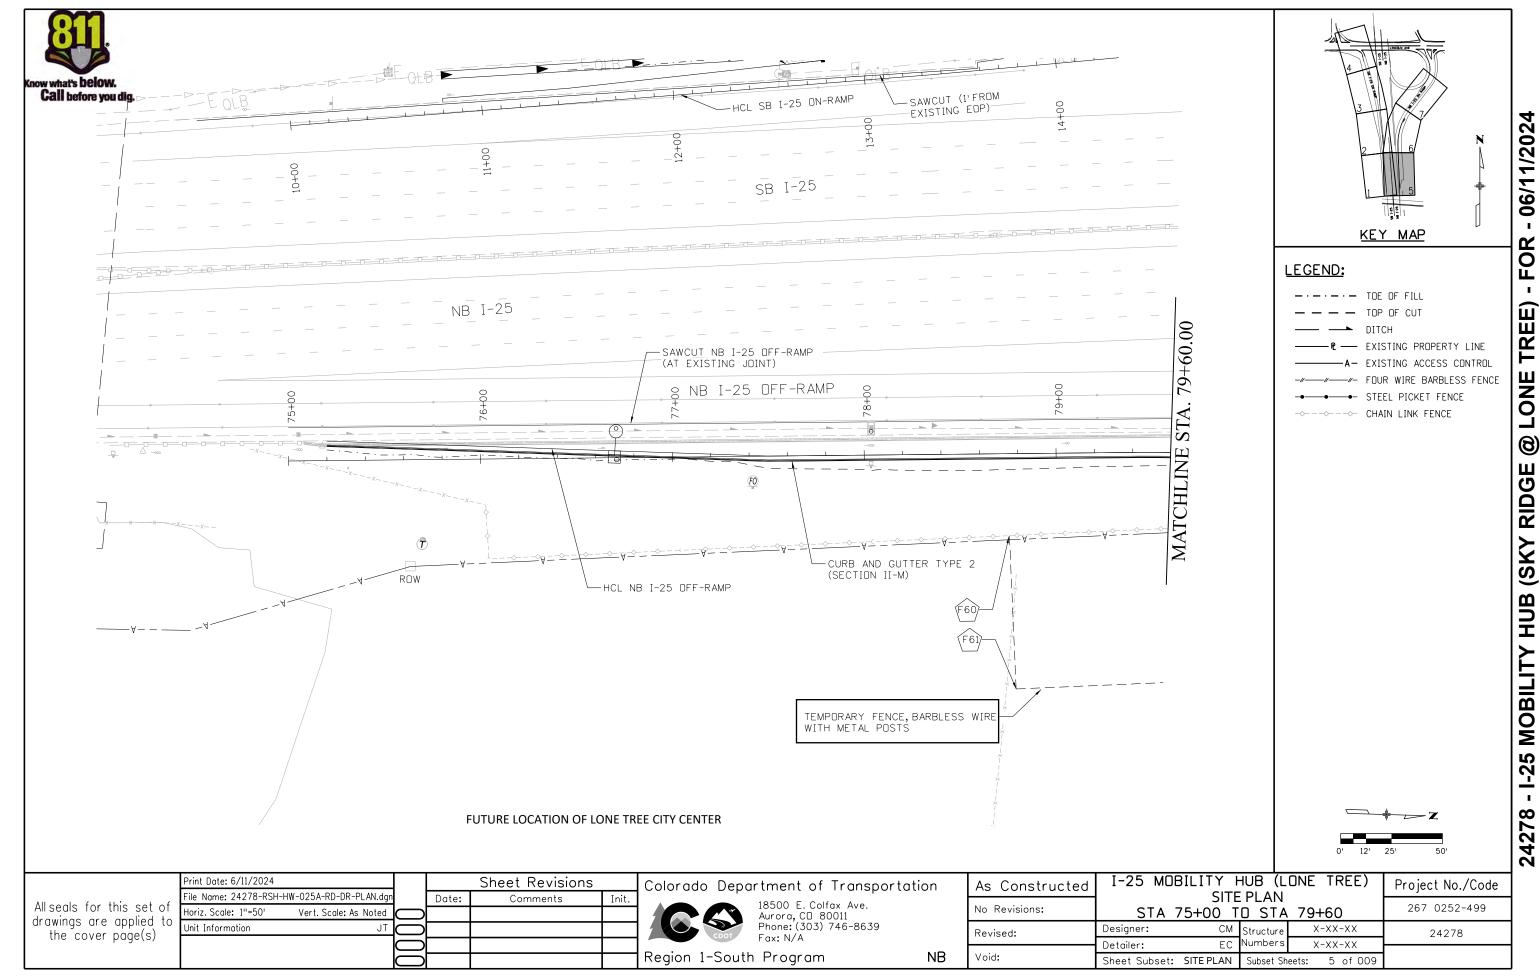
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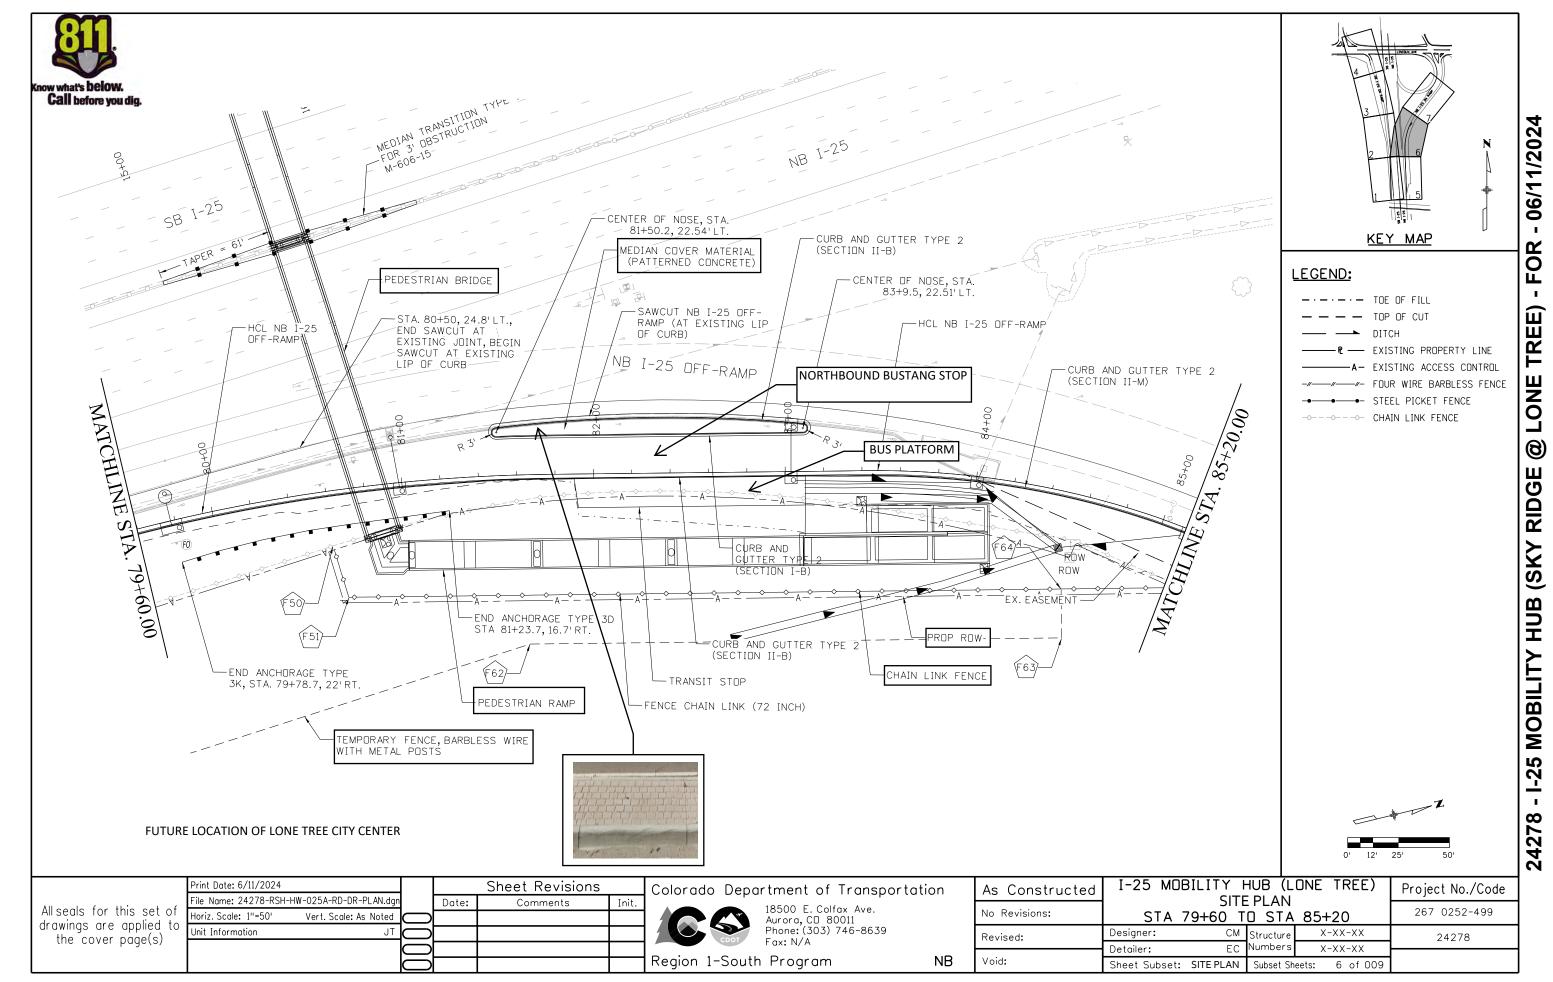
Project No./Code 267 0252-499 24278


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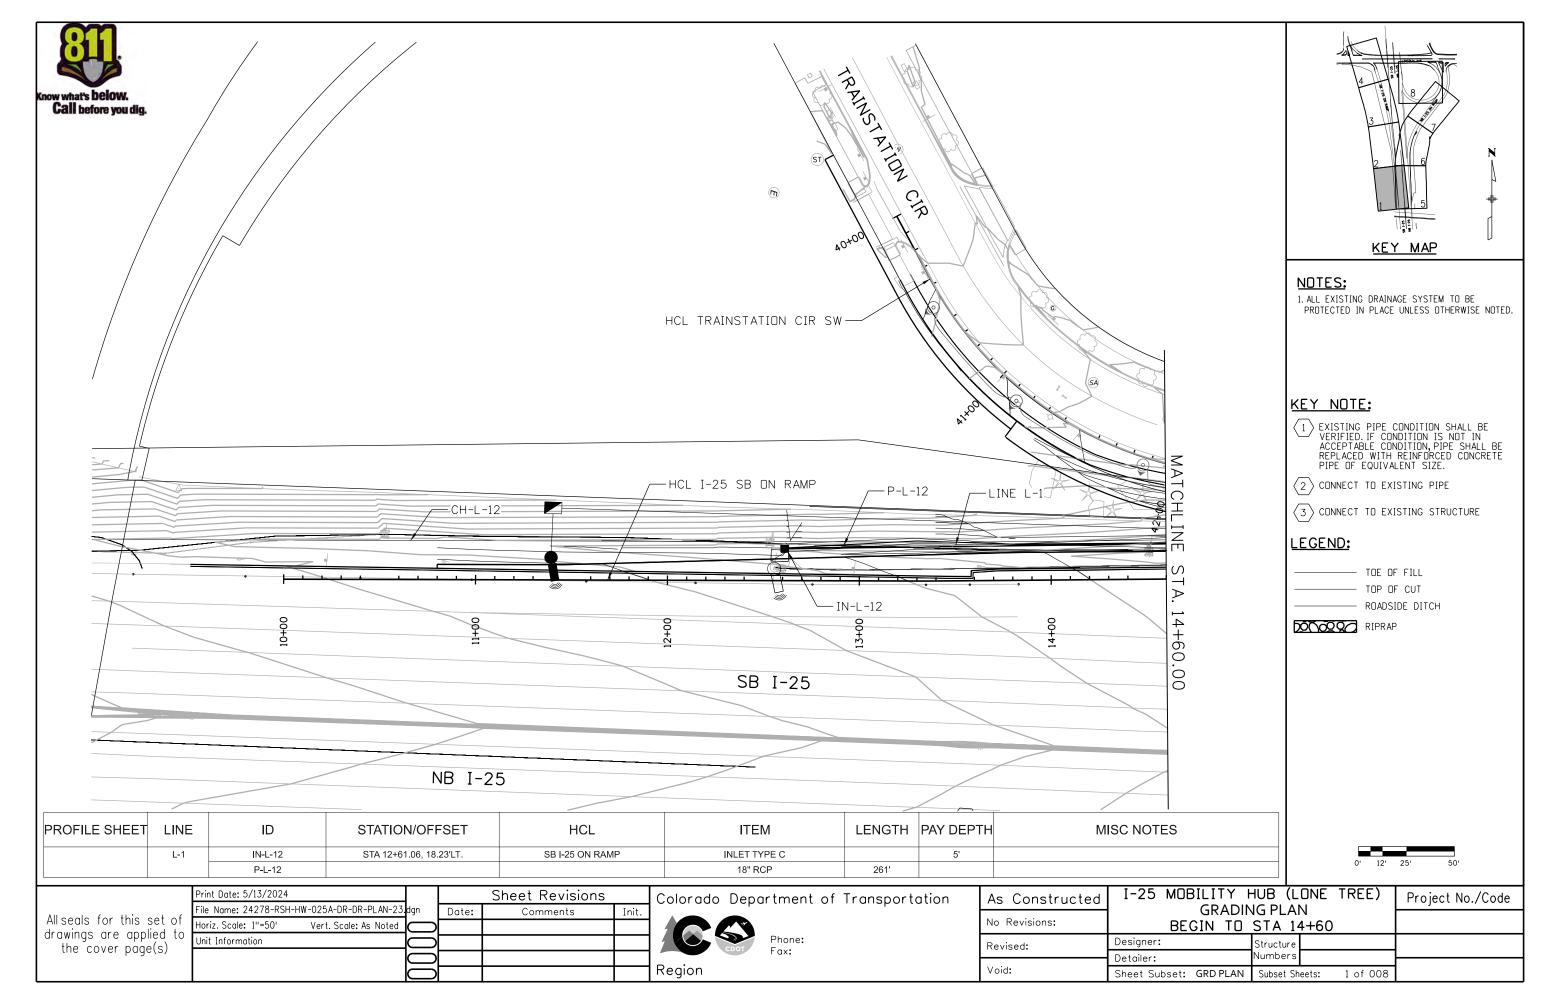












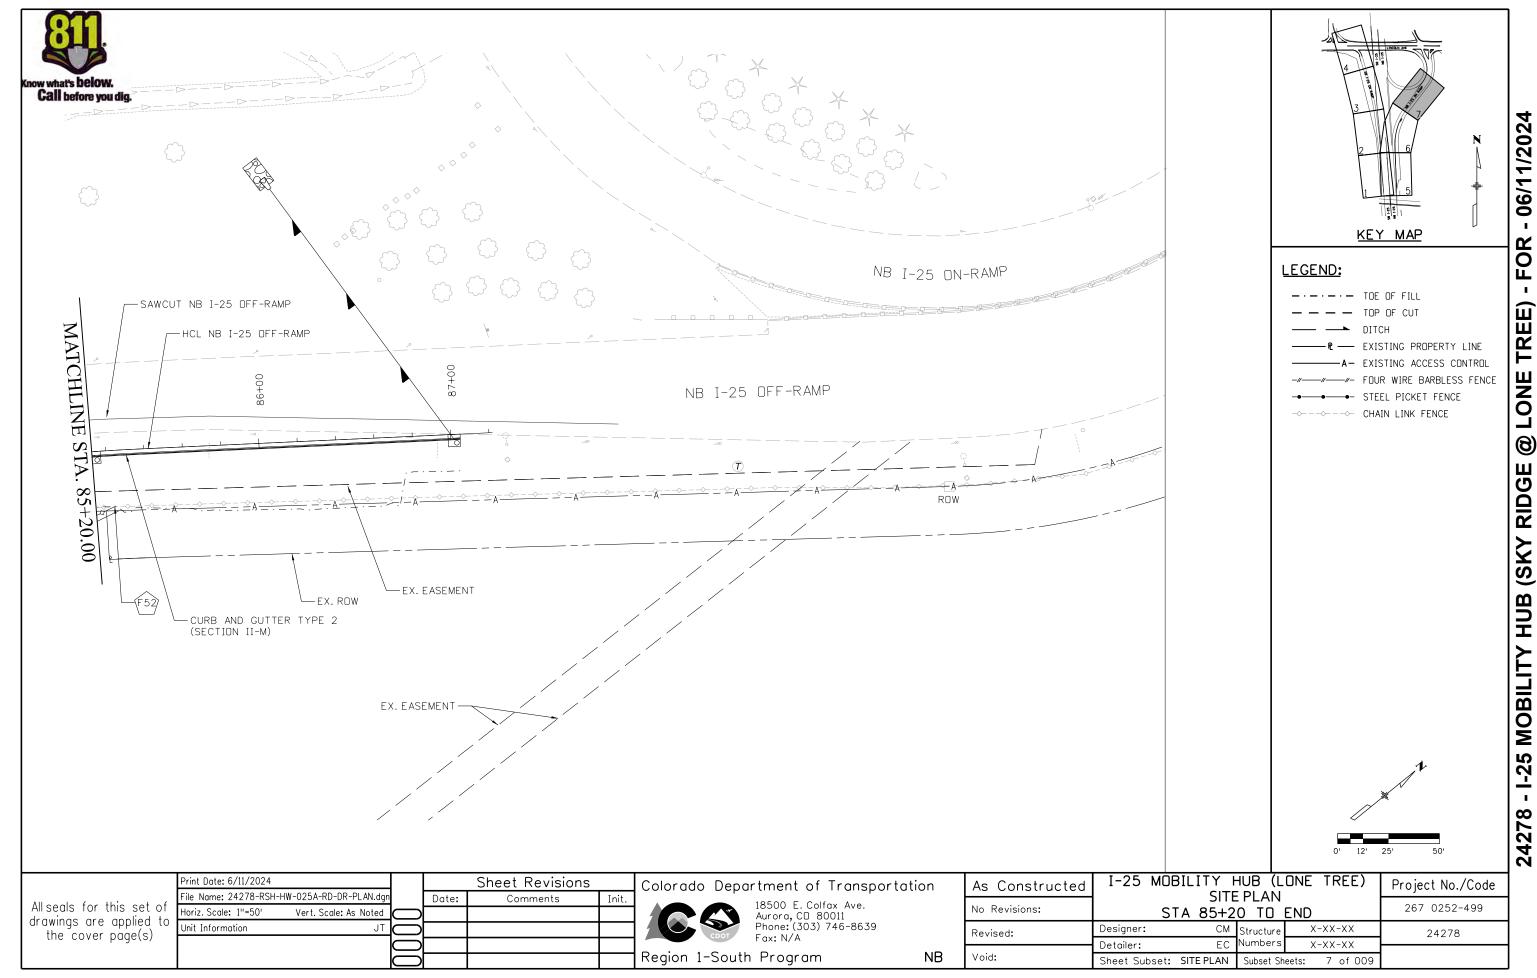



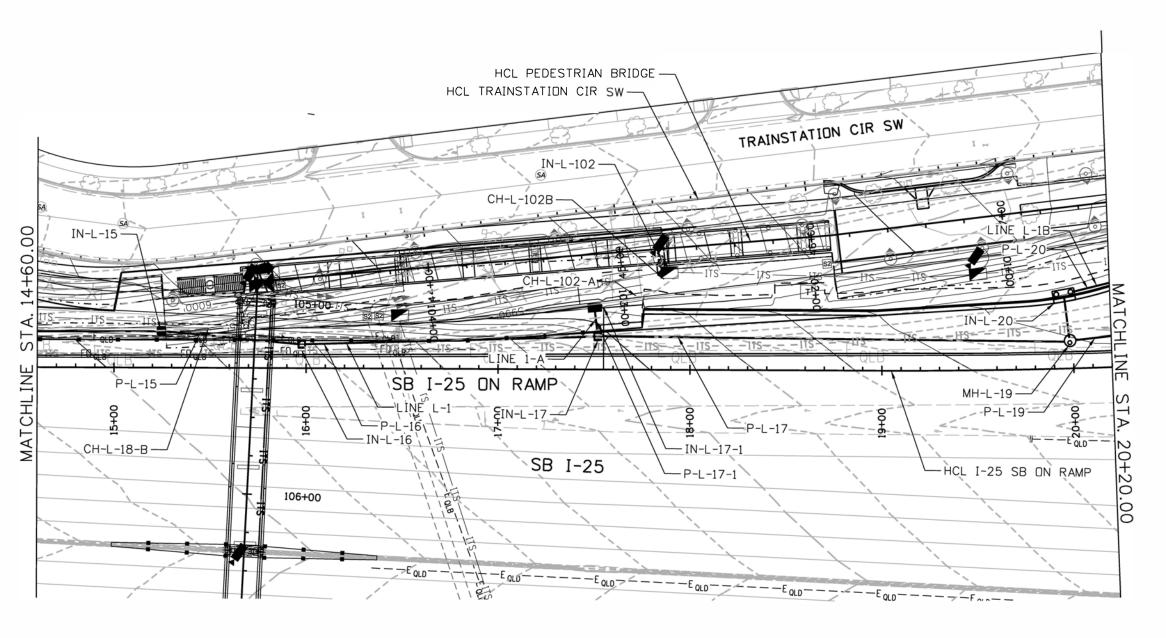

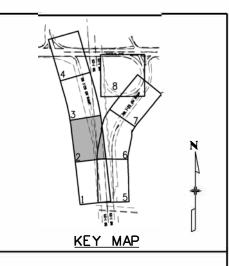

NOTES:

1. ALL EXISTING DRAINAGE SYSTEM TO BE PROTECTED IN PLACE UNLESS OTHERWISE NOTED.

KEY NOTE:

- EXISTING PIPE CONDITION SHALL BE VERIFIED. IF CONDITION IS NOT IN ACCEPTABLE CONDITION, PIPE SHALL BE REPLACED WITH REINFORCED CONCRETE PIPE OF EQUIVALENT SIZE.
- 2 CONNECT TO EXISTING PIPE
- 3 CONNECT TO EXISTING STRUCTURE

LEGEND:

-·-·- TOE OF FILL - TOP OF CUT ROADSIDE DITCH

DOCOO QC RIPRAP

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Print Date: 5/13/2024 ile Name: 24278-RSH-HW-025A-DR-DR-PLAN-2 Horiz. Scale: 1"=50' Vert. Scale: As Noted Unit Information

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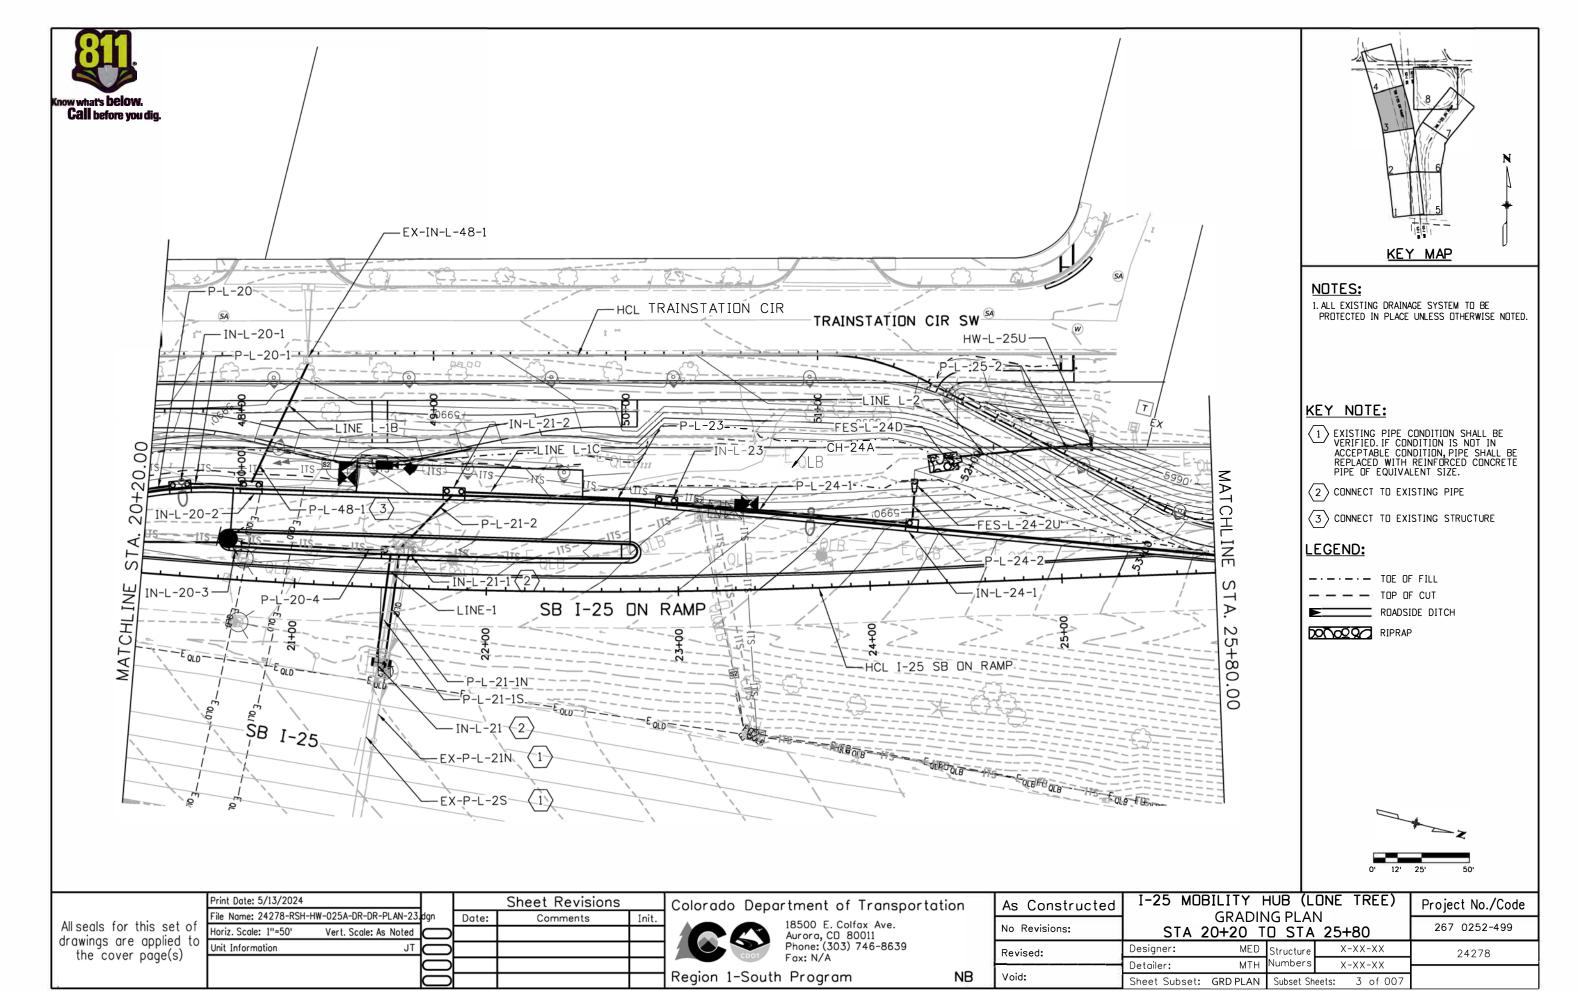
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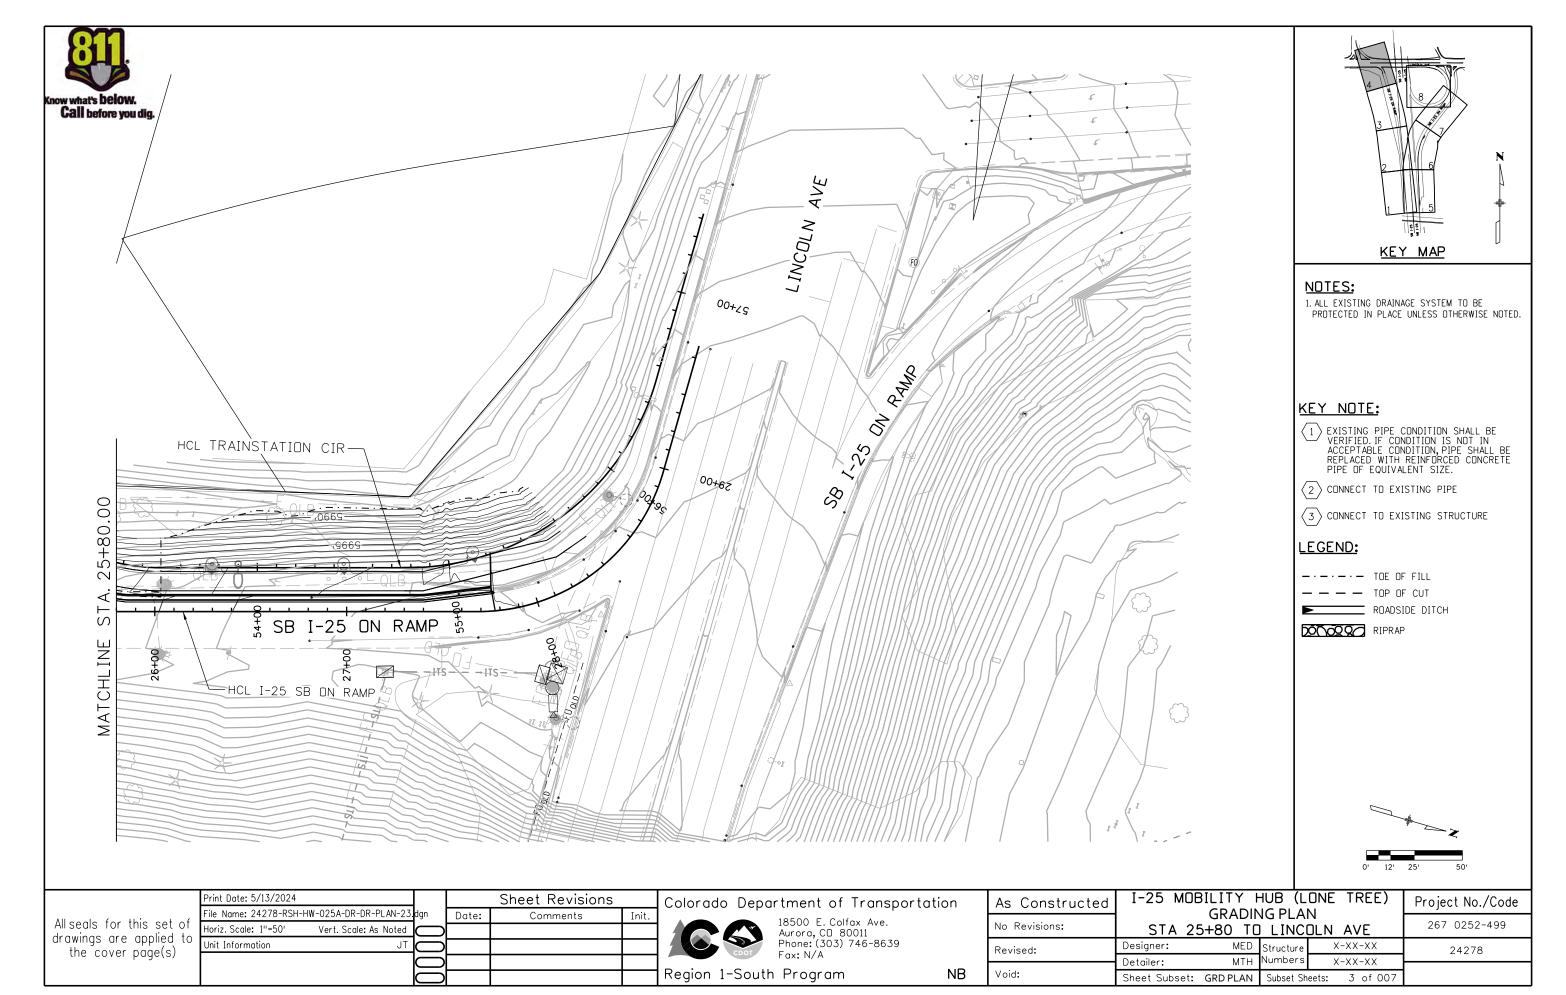
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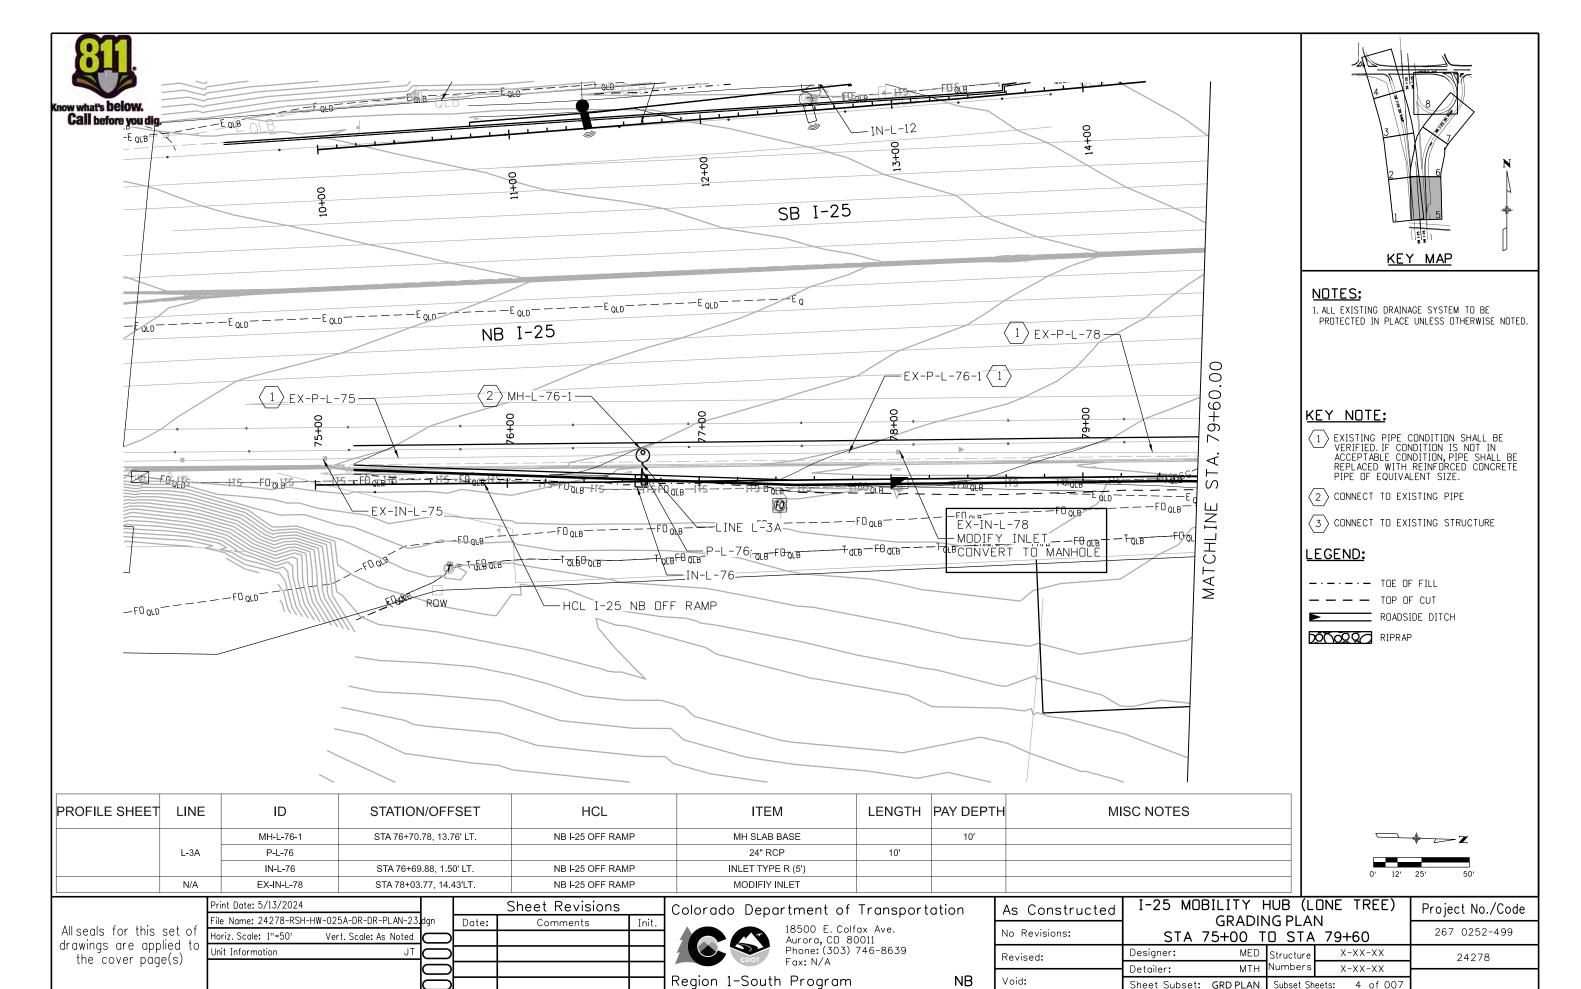
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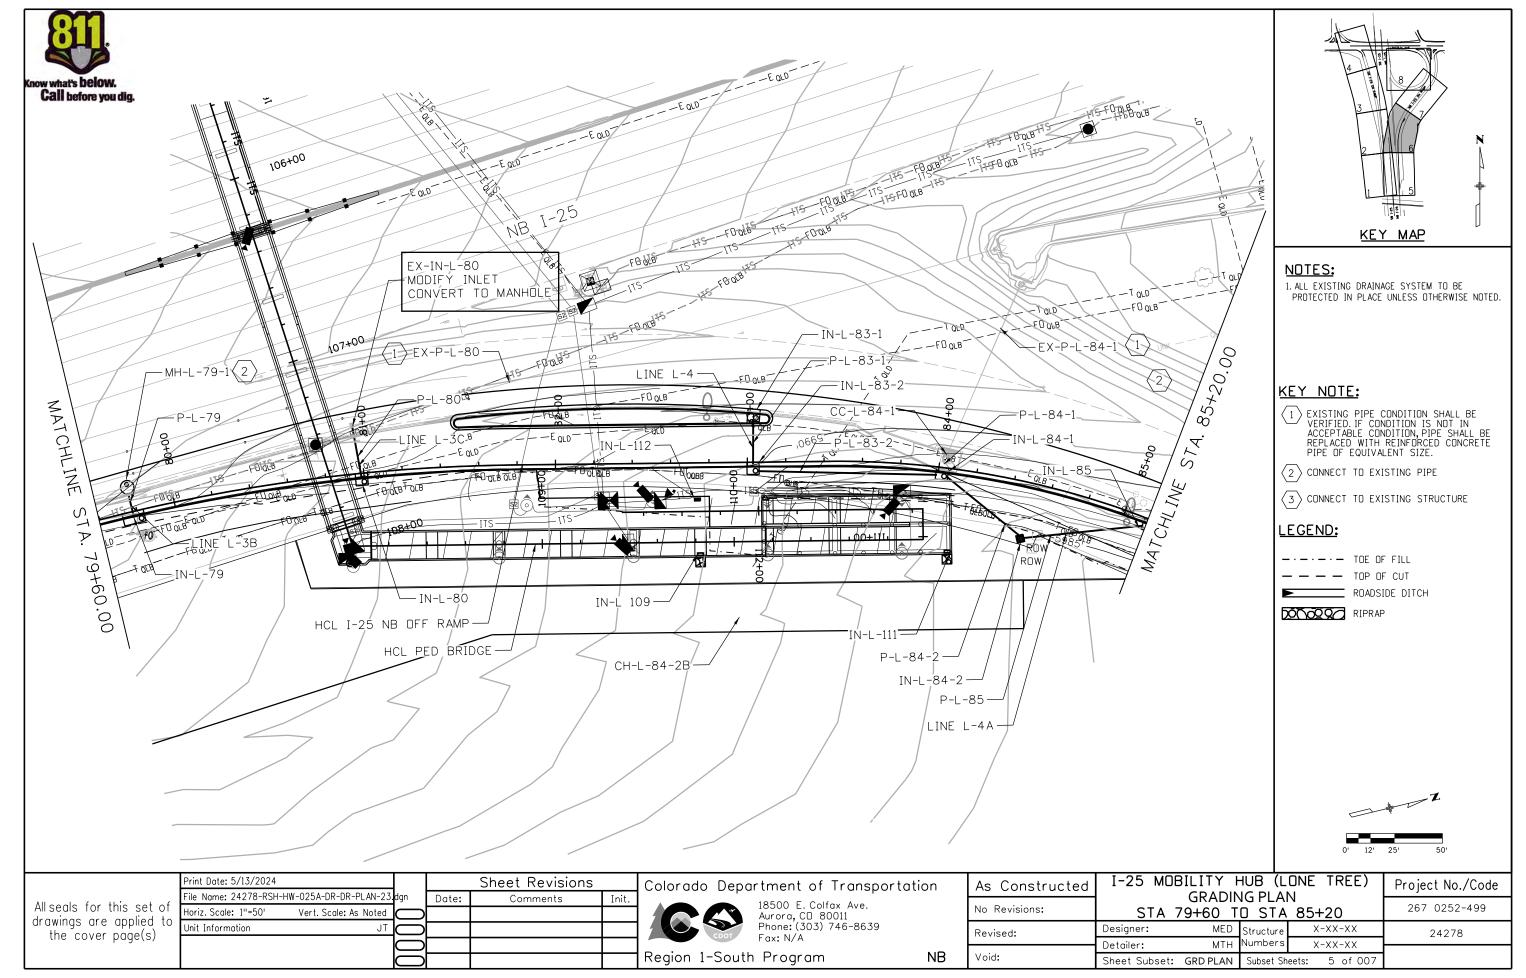
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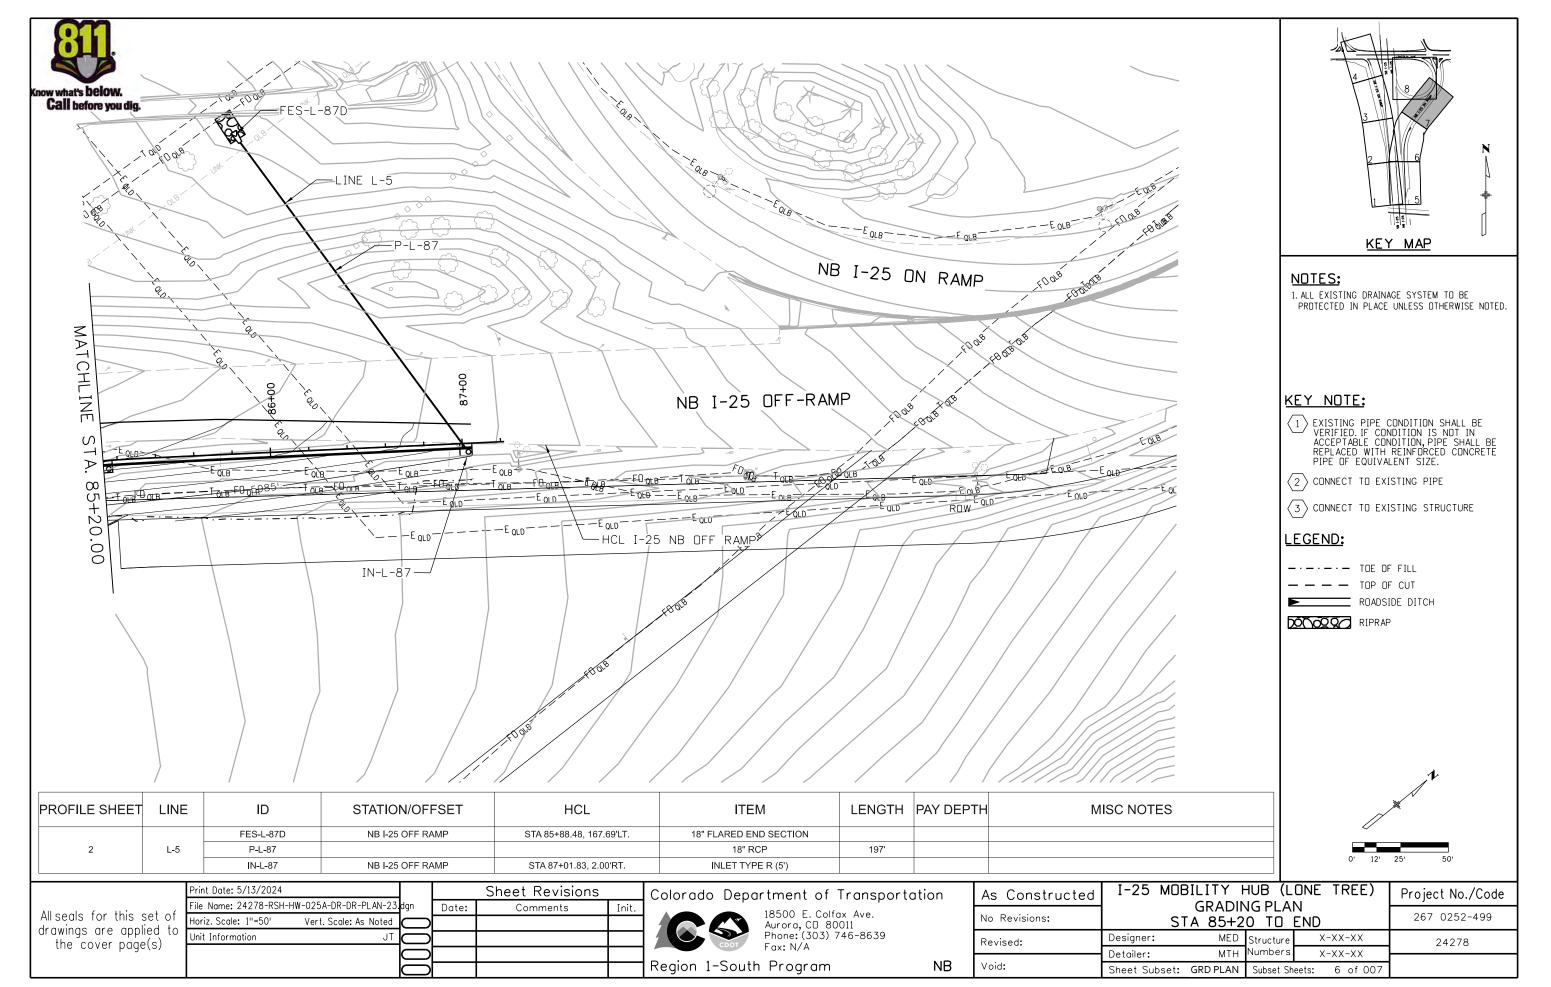
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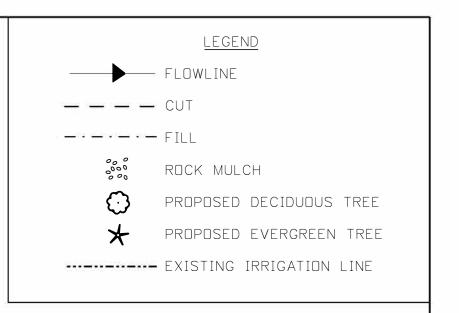













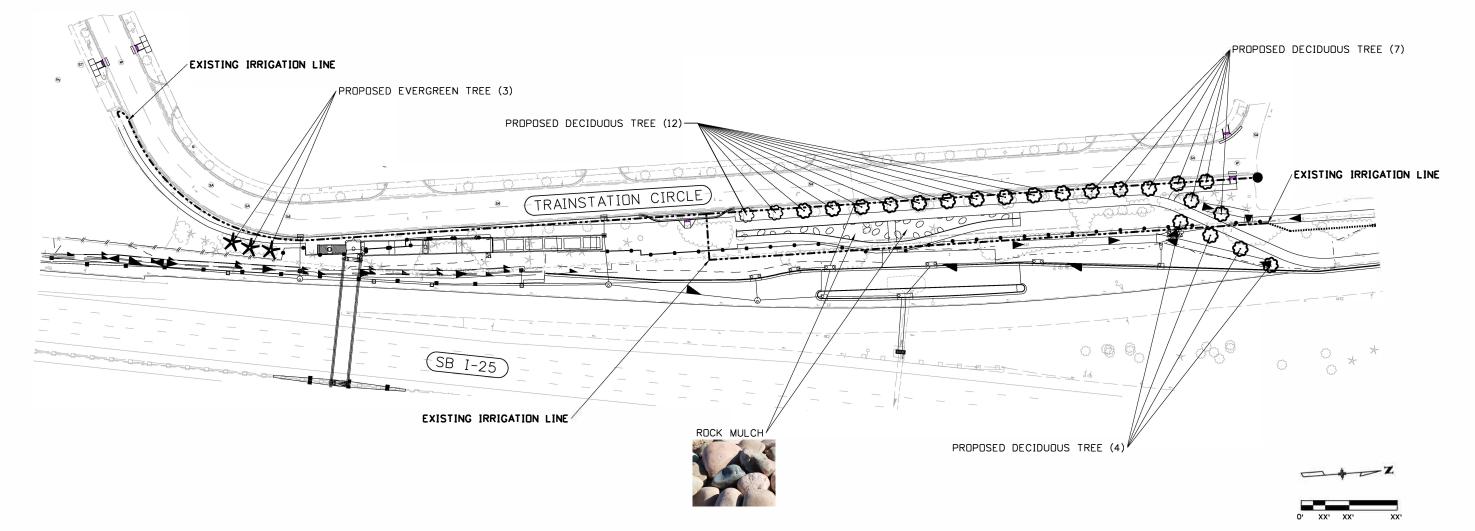

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Project No./Code LANDSCAPE/IRRIGATION PLAN 267 0252-499 JET Structure Designer: 24278 Numbers Detailer:

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LANDSCAPE NOTES:

- 1. ANY PROPOSED SUBSTITUTIONS OF PLANT SPECIES SHALL BE APPROVED BY THE LANDSCAPE ARCHITECT PRIOR TO DELIVERY TO THE SITE.
- 2. CONTRACTOR SHALL BE RESPONSIBLE FOR BECOMING AWARE OF ALL UNDERGROUND UTILITIES, PIPES AND STRUCTURES. THE CONTRACTOR SHALL BE HELD RESPONSIBLE FOR CONTACTING ALL UTILITY COMPANIES FOR FIELD LOCATION OF UNDERGROUND UTILITY LINES PRIOR TO ANY EXCAVATION. LANDSCAPE CONTRACTOR SHALL TAKE SOLE RESPONSIBILITY FOR ANY COST OF UTILITY REPAIR DUE TO DAMAGE CAUSED BY THEIR OPERATIONS.
- 3. DO NOT WILLFULLY PROCEED WITH CONSTRUCTION AS DESIGNED WHEN IT IS OBVIOUS THAT UNKNOWN OBSTRUCTIONS AND/OR GRADE DIFFERENCES EXIST THAT MAY OR MAY NOT HAVE BEEN KNOWN DURING DESIGN.
- 4. SEE SPECIFICATIONS FOR PLANTING REQUIREMENTS, SOIL PREPARATION TESTING, MATERIALS AND EXECUTIONS. ARRANGE FOR VISIT OF LANDSCAPE ARCHITECT FOR REVIEW AND APPROVAL A MINIMUM OF 48 HOURS PRIOR TO INSTALLATION.
- 5. MAINTENANCE STATEMENT: ALL LANDSCAPING SHOWN ON THIS PLAN SHALL BE MAINTAINED IN A NEAT AND ADEQUATE MANNER. REQUIRED MAINTENANCE ACTIVITIES SHALL INCLUDE, BUT NOT LIMITED TO, ADEQUATE IRRIGATION, REPLACEMENT OF DEAD OR DISEASED OR UNSIGHTLY LANDSCAPING, REMOVAL OF WEEDS FROM PLANTED AREAS, AND APPROPRIATE PRUNING PLANT MATERIALS

IRRIGATION NOTES:

- IRRIGATION LINE LOCATIONS SHOWN IN THESE PLANS ARE APPROXIMATE. REFER TO SUPPLEMENTAL RAMPART RANGE METRO DISTRICT (RRMD) PLANS FOR EXACT LOCATIONS.
- 2. A FIELD VISIT SHALL TAKE PLACE PRIOR TO THE START OF CONSTRUCTION TO LOCATE IRRIGATION LINES AND IDENTIFY AREAS TO CUT AND RECONNECT TO.

MULCHING NOTES:

- 1. LANDSCAPE WEED BARRIER FABRIC: INSTALL FABRIC IN ROCK MULCH AREAS ONLY. SPUNBOND TYPE LANDSCAPE FABRIC/WEED BARRIER SIMILAR AND EQUAL TO MIRAFI 140N, TYPAR, OR STABILENKA T-
- 2. MULCHING (WOOD CHIP): WOOD MULCH SHALL BE DOUBLE-SHREDDED CEDAR MULCH HAVING MULCH RINGS AROUND ALL TREES SET IN NATIVE AREAS.

PLANT LIST:

BOTANICAL NAME	COMMON NAME	SIZE	QUANTITY
FRAXINUS NIGRA 'FALLGOLD'	FALLGOLD ASH	2-1/2" CAL.	23
PINUS NIGRA	AUSTRIAN PINE	6'	3

LANDSCAPE SUMMARY OF QUANTITIES:

ITEM#	DESCRIPTION	UNIT	QTY.
213-00008	MULCHING (WOOD CHIP)	CF	243
213-00070	LANDSCAPE WEED BARRIER FABRIC	SY	323
213-00462	METAL LANDSCAPE BORDER (3/16x5-1/2-INCH)	LF	600
214-00005	LANDSCAPE MAINTENANCE (24 MONTH)	LS	1
214-00220	DECIDUOUS TREE (2-INCH CALIPER)	EACH	23
214-00506	EVERGREEN TREE (6 FOOT)(B&B)	EACH	3
700-70380	F/A EROSION CONTROL	F/A	1
700-70310	F/A LANDSCAPING	F/A	1

NOTE: REFERENCE SWMP FOR SEEDING (NATIVE) QUANTITIES AND PAVING PLAN FOR ROCK MULCH QUANTITIES.


CITY OF LONE TREE LANDSCAPING NOTES:


- 1. ALL PLANTS INSTALLED SHALL FOLLOW THE PLANT SCHEDULE, INSTALLATION INSTRUCTIONS AND THE LANDSCAPE DRAWINGS ON THE APPROVED LANDSCAPE PLAN INCLUDED IN THIS SITE IMPROVEMENT PLAN. ANY CHANGES TO THE APPROVED LANDSCAPE PLAN, TO INCLUDE PLANT SUBSTITUTIONS, MUST BE APPROVED BY THE CITY IN ADVANCE OF INSTALLATION.
- ALL MULCH AND/OR ROCK COBBLE SHALL BE INSTALLED AND MAINTAINED TO THE DEPTH(S)
 PROVIDED ON THE APPROVED LANDSCAPE PLAN INCLUDED IN THIS SITE IMPROVEMENT PLAN.
- 3. ORGANIC MULCH SHALL NOT BE PLACED WITHIN SIX (6) FEET OF STORM INLETS.
- 4. THE USE OF IMPERMEABLE SHEET PLASTIC AS A WEED BARRIER IS PROHIBITED.

CITY OF LONE TREE IRRIGATION NOTES:

- 1. IRRIGATION SHALL OCCUR BETWEEN THE HOURS OF 8:00 P.M. AND 6:00 A.M.
- 2. ANY IRRIGATION EQUIPMENT MOUNTED TO THE BUILDING SHALL BE PAINTED TO MATCH THE BUILDING.

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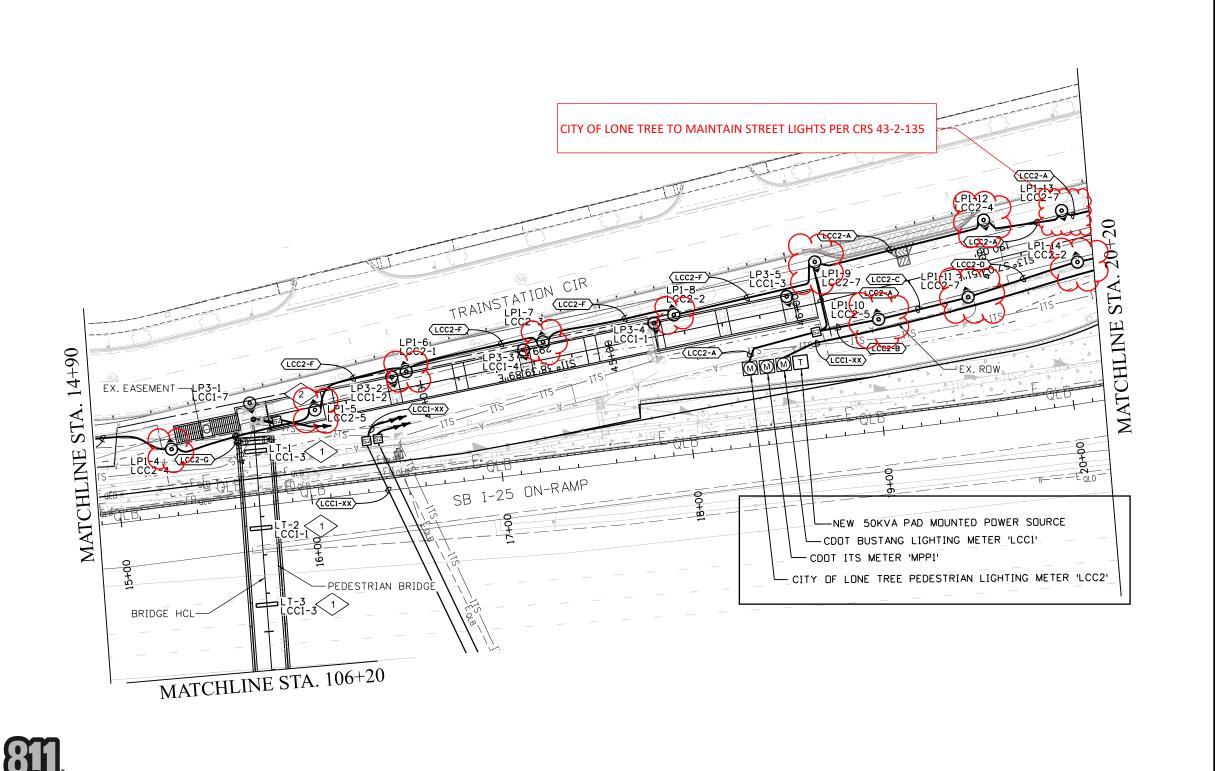


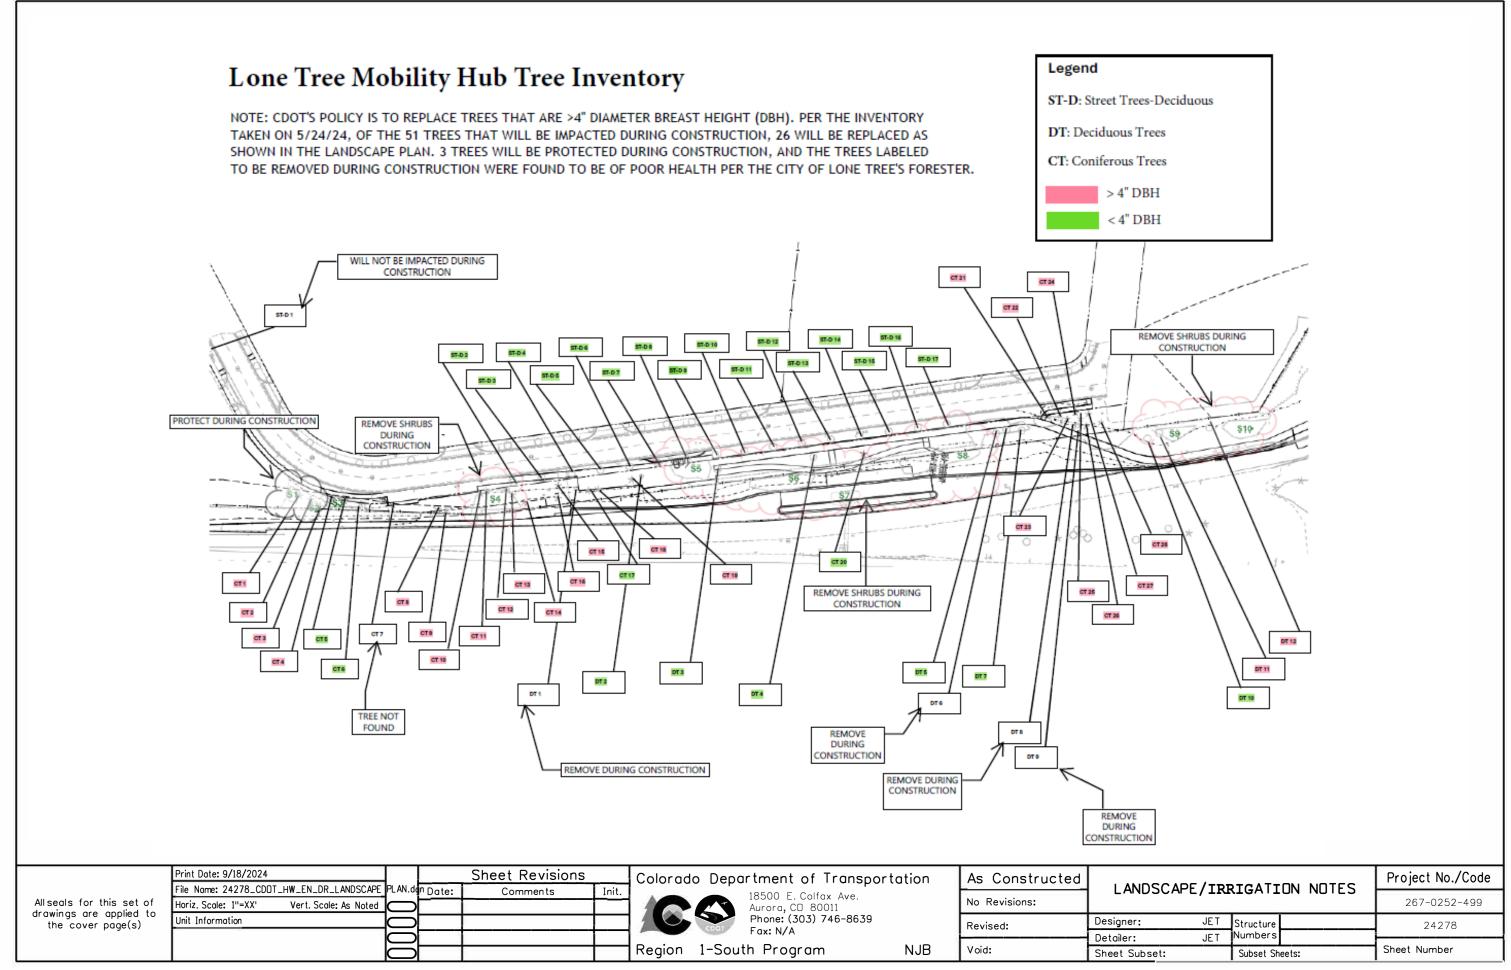
BRANCHES 6" SAUCER AROUND PLANT ON STEEP SLOPES PLANT ROOTBALL 2' ABOVE FINAL GRADE, REMOVE PLASTIC DR METAL CONTAINER AND PLANT IMMEDIATELY. PLANT SHRUB WITH SAUCER ON DOWNHILL SIDE ONLY -4" DEPTH WOOD MULCH FINAL GRADE -COMPACTED SUBGRADE BACKFILL IN ACCORDANCE WITH SECTION 214 ROUGHEN SIDES OF PIT. TO REMOVE GLAZING FOR ROOTBOUND CONTAINER STOCK, MAKE VERTICAL SCORES (1/4" - 1/2" DEEP) SATURATE (DEEP WATER) BACKFILL AT TIME OF PLANTING TO REMOVE 1/2 AIR POCKETS. REPEAT WITH ADDED ROOTBALL— BACKFILL AND WATERING AS NEEDED. DIA. ALONG THE SIDES OF ROOTBALL ROOTBALL WHITE PVC AROUND AT LEAST 50% OF THE STANDARD NURSERY STOCK CONTAINERS (#5, #10 AND #20) PLANTING DETAIL WIRE TO MARK AND PREVENT PEOPLE FROM NOT TO SCALE PRUNE ONLY DEAD OR DAMAGED BRANCHES IF DIRECTED ADD WOOD SURVEY LATH (APPROXMATELY 1"x2"X48" LONG) _PLANT RODTBALL 2-4" DEPRESSED FROM SURROUNDING GRADES. 4" DEPTH WOOD MULCH 4" SAUCER AROUND PLANT. ON STEEP SLOPES, PLANT SHRUB WITH SAUCER ON DOWNHILL SIDE DNLY _REMOVE PLASTIC CONTAINER AND PLANT IMMEDIATELY. FINAL GRADE 国 -BACKFILL IN ACCORDANCE WITH SECTION 214 BOTTOM OF PLANTING PIT ELEVATION IN RELATIONSHIP TO THE LOWEST ELEVATION -OF THE GROUND WATER DURING THE GROWING SEASON SHOULD BE CONFIRMED WITH REGIONAL ENVIRONMENTAL STAFF. ROUGHEN SIDES OF PIT TREE PLANTING AND GUYING DETAIL TD REMOVE GLAZING SATURATE (DEEP WATER) BACKFILL AT TIME OF PLANTING TO REMOVE AIR POCKETS. REPEAT WITH ADDED BACKFILL AND WATERING AS NEEDED. (GUY AND STAKE DECIDUOUS TREES 2" AND LARGER CALIPER AND EVERGREEN TREES OVER 4'HEIGHT.) NOT TO SCALE 1/2 RB (RDOTBALL)— DIA. 1/2 RB —(RODTBALL) DIA. DEEP ROOTED UPLAND NURSERY CONTAINERS (DRC #10, #40, #60 AND #180) PLANTING DETAIL NOT TD SCALE 120° 120° PLANT AT LEAST 4" ABOVE SOURROUNDING GRADES WITH AT LEAST 2 LIVE BUDS ABOVE GROUND. PREVAILING WIND PREVAILING WIND DIRECTION DIRECTION STRAIGHT CUT TOP END OF STAKES WHEN HARVESTING NOTE: FOR TREES ON 4:1 OR STEEPER SLOPES. 2"-4" DEPRESSION TO CAPTURE WATER PLACE TWO GUYS UPSLOPE AND ONE DOWN SLOPE. OTHERWISE, PLACE FOR PREVAILING WIND. 4" MIN GUYING PATTERN FOR EVERGREEN TREE FINAL GRADE-BALLED AND BURLAPPED TREE PLANTINGS LIVE UNROOTED CUTTING STAKES SHALL BE PLANTED A MINIMUM DEPTH OF 18 INCHES AND UP TO 32 -INCHES WHERE NECESSARY TO MAINTAIN CONTACT WITHTHE LOWEST WATER TABLE ELEVATION OF THE GROWING SEASON. BACKFILL WITH CLEAN NATIVE TOPSOIL LOWEST WATER TABLE ELEVATION _OF THE GROWING SEASON. CONFIRM ELEVATION WITH REGIONAL ENVIRONMENTAL STAFF. 180° 180° PILOT HOLE MUST BE DEEP ENOUGH TO REACH THE LOWEST WATER TABLE OF THE GROWING SEASON PREVAILING WIND PREVAILING WIND ANGLE CUT BOTTON OF STAKES WHEN HARVESTING DIRECTION DIRECTION UNRODTED CUTTING STAKES PLANTING DETAIL GUYING PATTERN FOR DECIDUOUS TREE SATURATE (DEEP WATER) BACKFILL AT TIME OF PLANTING TO REMOVE AIR POCKETS. REPEAT WITH ADDED BACKFILL AND WATERING AS NEEDED. BALLED AND BURLAPPED TREE PLANTINGS NOT TO SCALE

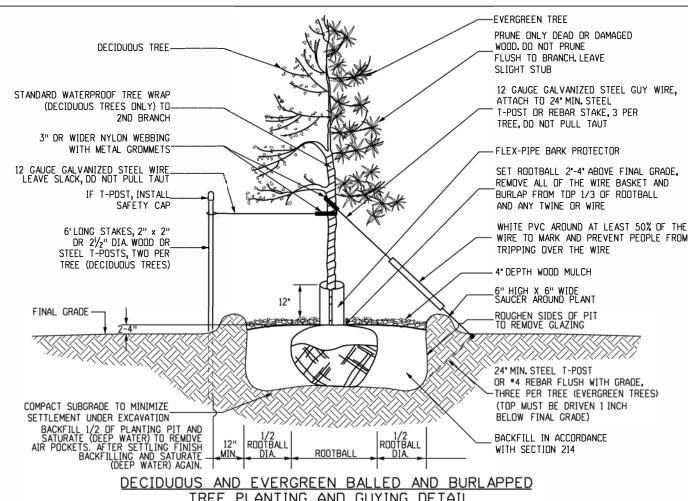IF DIRECTED ADD WOOD SURVEY LATH (APPROXMATELY 1"x2"X48" LONG)

Computer File Information			Sheet Revisions	Colorado Department of Transportation	NURSERY STOCK	STANDARD PLAN NO.
Creation Date: 07/31/19		Date:	Comments	2829 West Howard Place	NUNSERI STUCK	M-214-1
Designer Initials: MP	<u>(R-X)</u>			CDOT HQ,	DETAILO	IVI-214-1
Last Modification Date: 07/31/19	<u>(R-X)</u>		<u></u>	Denver, CD 80204 Phone: 303-757-9542	DETAILS	Standard Sheet No. 1 of 1
Detailer Initials: LTA	(R-X)					
CAD Ver.: MicroStation V8 Scale: Not to Scale Units: English	<u>(R-X)</u>			Project Development Branch JBK	Issued by the Project Development Branch: July 31, 2019	


PRUNE ONLY DEAD OR DAMAGED



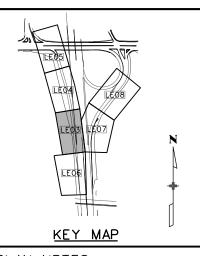

PLAN NOTES:

- 1 TYPE 'LT'LINEAR LED LUMINAIRE INSTALLED ON BRIDGE CANOPY. REFER LIGHTING DETAIL ON SHEET LE10 FOR MORE INFORMATION.
- 2 LINEAR LED LUMINAIRE INSTALLED UNDER BRIDGE.

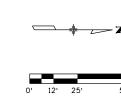

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Know what's **below. Call** before you dig.

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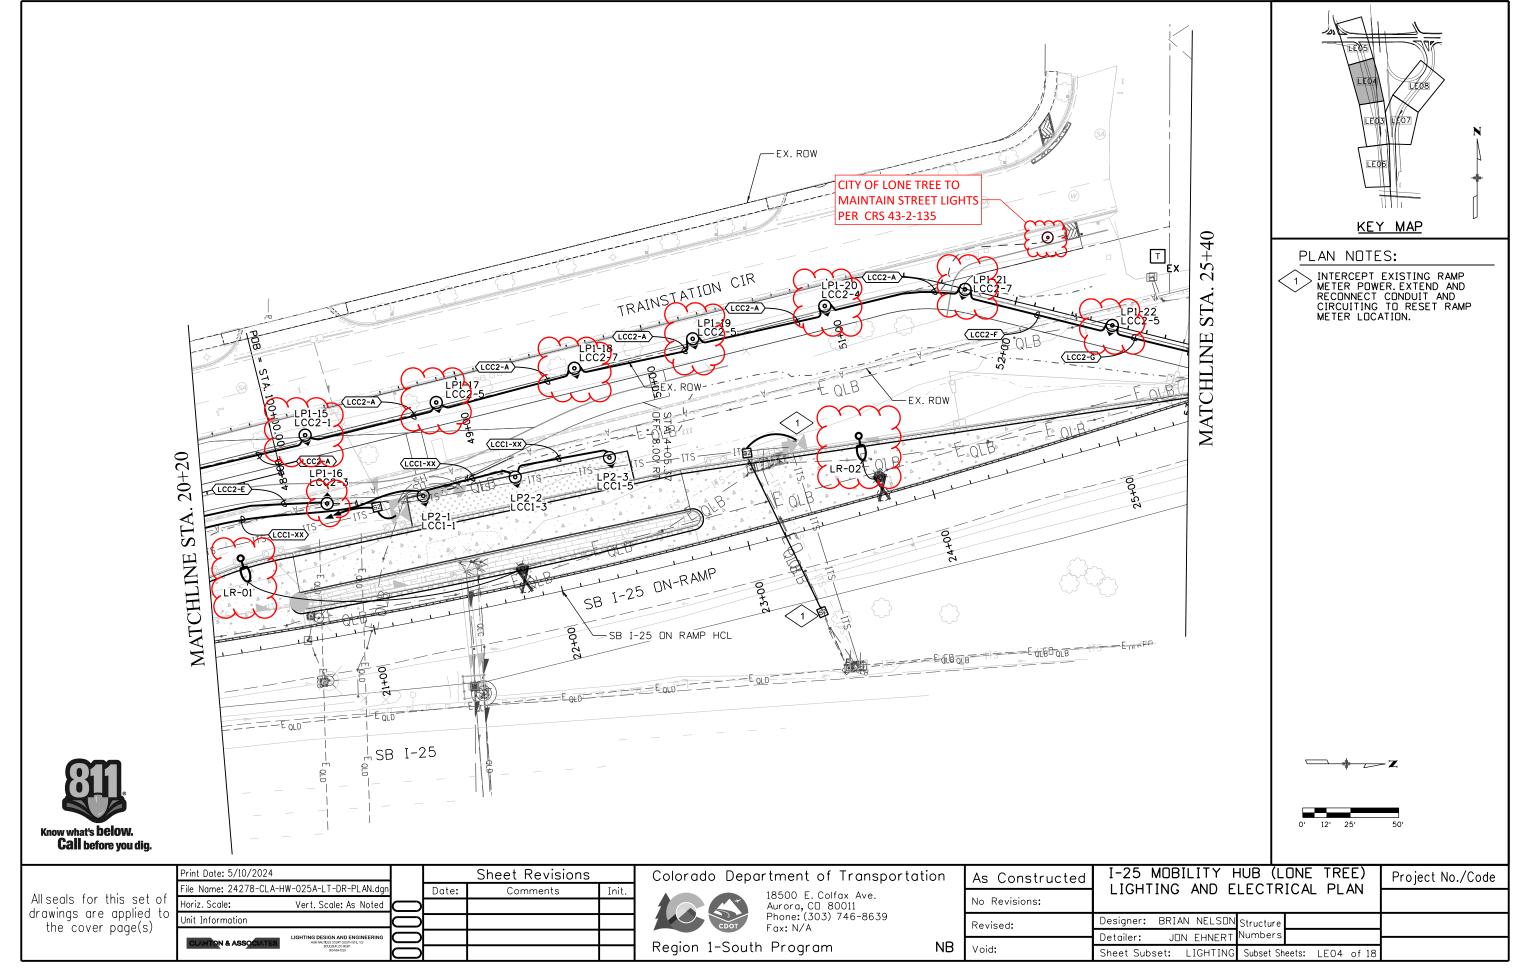
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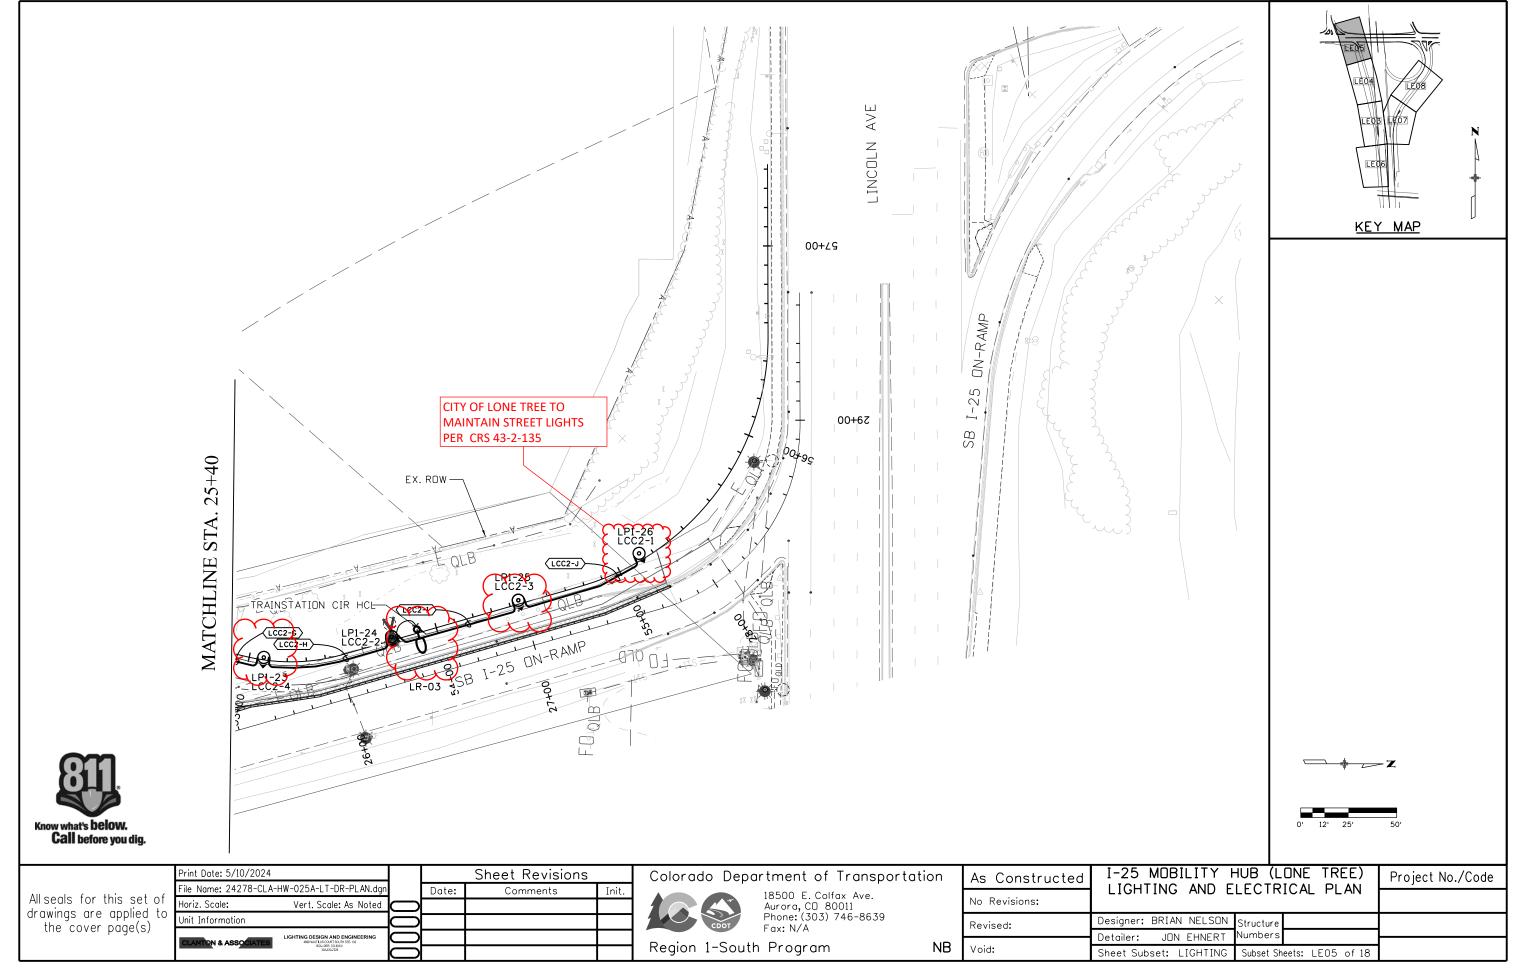



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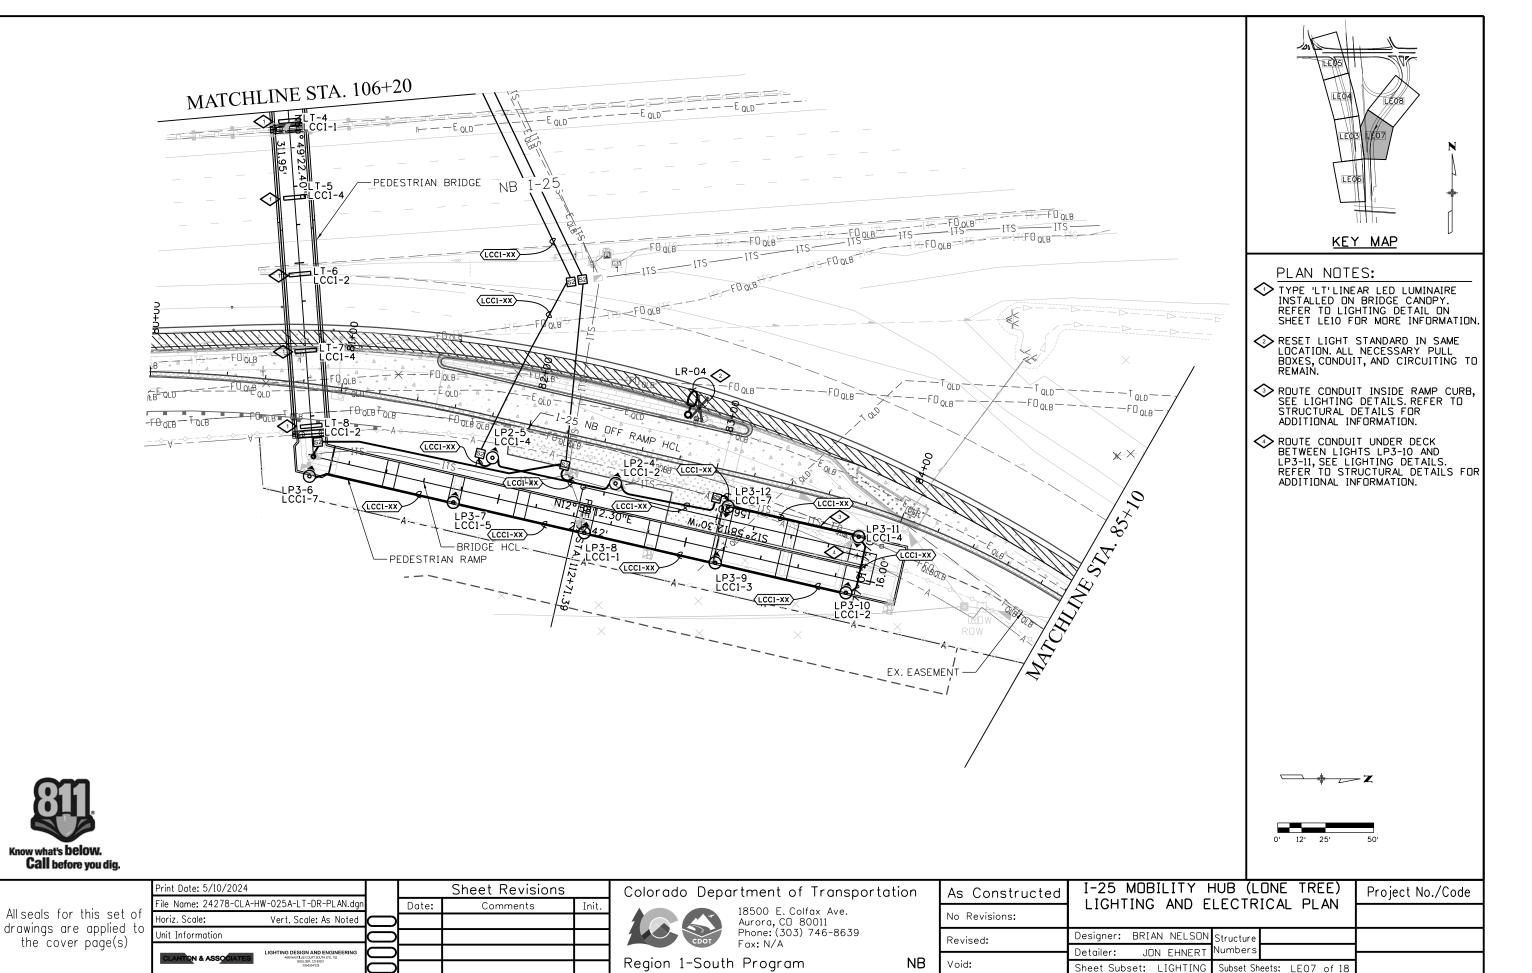
Region 1-South Program NB


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	No Revisions:	LIGHTING AND ELECTRICAL PLAN	
	Revised:	Designer: BRIAN NELSON Structure	
В	Void:	Detailer: JDN EHNERT Numbers Sheet Subset: LIGHTING Subset Sheets: LE03 of 18	







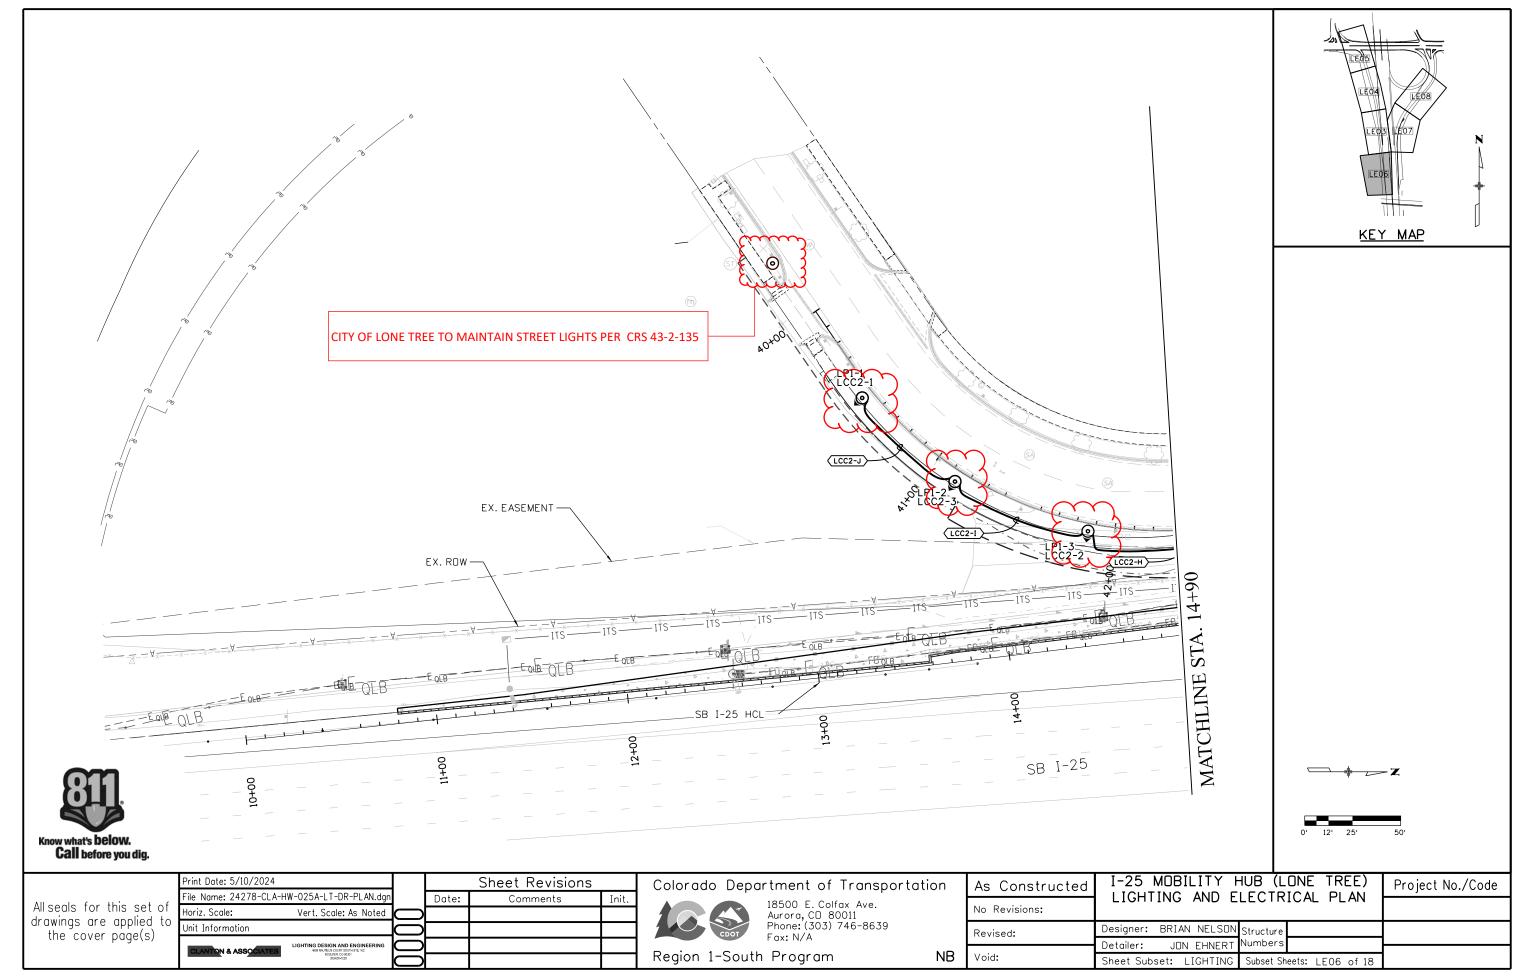


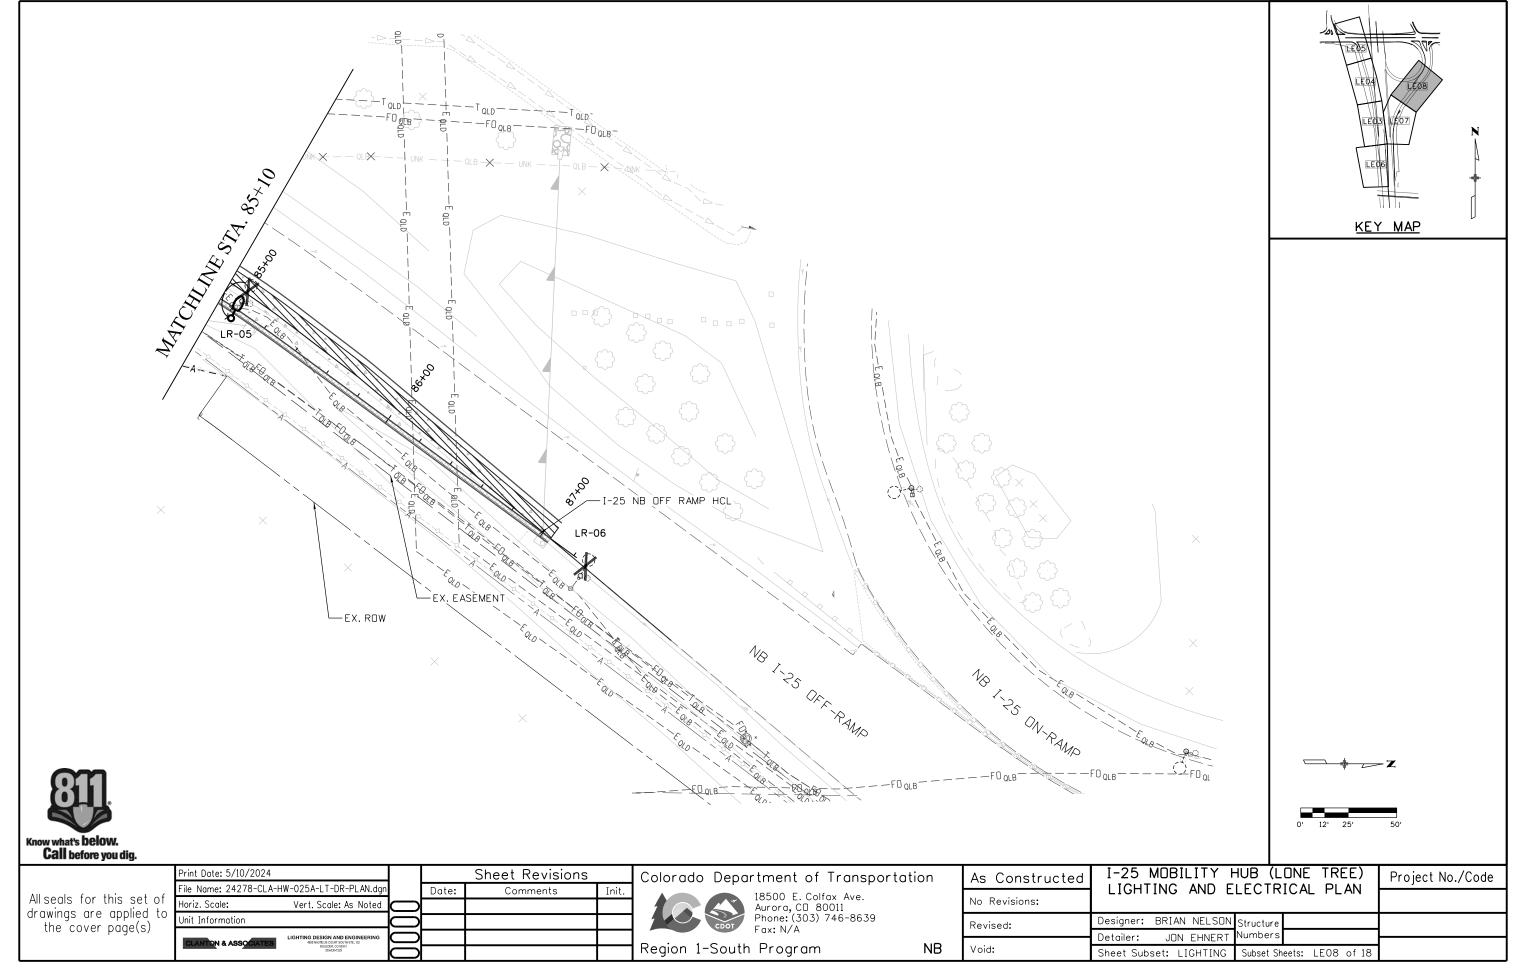



SCHEDULE OF LIGHTING DEVICES

LONG DESCRIPT	TION				RESET OF LIGHT STANDARD	LUMINAIRE (LED) (2,000 LUMENS) TYPE'LT'	LIGHT STANDARD AND LUMINAIRE (PEDESTRIAN) TYPE 'LP1'	LUMINAIRE (LED) (4,000 LUMENS) TYPE 'LP2'	LUMINAIRE (LED) (8,000 LUMENS) TYPE 'LP3'	LIGHT STANDARD ALUMINUM (12 FOOT)	LIGHT STANDARD FOUNDATION	METER POWER PEDESTAL	LIGHTING CONTROL CENTER (SPECIAL)	CONCRETE FOUNDATION PAD	NOTE
UNITS					EACH	EACH	EACH	EACH	EACH	EACH	EACH	EACH	EACH	EACH	
SHEET No.	I.D. No.	BASELINE	STATION	OFFSET											
LE06	LP1-01						1				1				2
LE06	LP1-02						1				1				2
LE06	LP1-03						1				1				2
LE03	LP1-04						1				1				2
LE03 LE03	LP1-05 LP1-06						1 1				1				2
LE03	LP1-07						1				1				2
LE03	LP1-08						1				1				2
LE03	LP1-09						1				1				2
LE03	LP1-10						1				1				2
LE03	LP1-11						1				1				2
LE03	LP1-12 LP1-13						1				1				2
LE03	LP1-13						1				1				2
LE04	LP1-15						1				1				2
LE04	LP1-16						1				1				2
LE04	LP1-17						1				1				2
LE04	LP1-18						1				1				2
LE04	LP1-19						1				1				2
LE04 LE04	LP1-20 LP1-21						1 1				1				2
LE04	LP1-21						1				1				2
LE05	LP1-23						1				1				2
LE05	LP1-24						1				1				
LE05	LP1-25						1				1				
LE05	LP1-26						1				1				
LE04	LP1-27						1				1				
LE06	LP1-28						1				1				
LE04	LP2-01							1		1	1				1
LE04	LP2-02							1		1	1				1
LE04	LP2-03							1		1	1				1
LE07	LP2-04							1		1	1				1
LE07	LP2-05							1		1	1				1
LE03	LP3-01									4					4.0
LE03	LP3-01								1 1	1					1,3 1,3
LE03	LP3-03								1	1					1,3
LE03	LP3-04								1	1					1,3
LE03	LP3-05								1	1					1,3
LE07	LP3-06								1	1					1,3
LE07	LP3-07								1	1					1,3
LE07 LE07	LP3-08 LP3-09								1	1					1,3 1,3
LE07	LP3-09								1	1					1,3
LE07	LP3-11								1	1					1,3
LE07	LP3-12								1	1					1,3
LE03	LT-01		BRIDGE			1									1,4
LE03	LT-02		BRIDGE			1									1,4
LE03 LE07	LT-03 LT-04		BRIDGE BRIDGE			1									1,4
LE07	LT-04		BRIDGE			1									1,4
LE07	LT-06		BRIDGE			1									1,4
LE07	LT-07		BRIDGE			1									1,4
LE07	LT-08		BRIDGE			1									1,4
LE04	LR-01				1						1				
LE04	LR-02				1						1				
LE05 LE07	LR-03 LR-04	-			1						1			1	-
LE08	LR-05				1						1				
LE03	MPP1											1		1	
	L														
LE03	LCC1												1 1	1	
LE03	LCC2	-											1	1	
	1	1			1		1			1	I.			1	
TOTALS					5	8	28	5	12	17	38	1	2	3	1

- 1) TYPE 'LP2', 'LP3' AND 'LT' PEDESTRIAN LIGHT STANDARDS OWNED AND MAINTAINED BY CDOT.
 2) TYPE 'LP1' PEDESTRIAN LIGHT STANDARDS OWNED AND MAINTAINED BY THE CITY OF LONETREE.
 3) TYPE 'LP3' PEDESTRIAN LIGHT STANDARDS NSTALLED ON BRIDGE RAMP.
 4) TYPE 'LT' LINEAR LUMINAIRES INSTALLED ON BRIDGE CANOPY STRUCTURE.

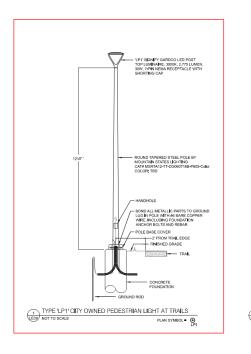

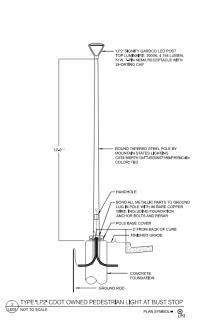

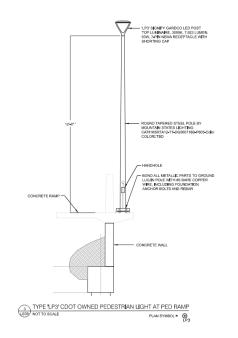

- AD - 09/20/2024

TREE)

- I-25 MOBILITY HUB (SKY RIDGE AT LONE

24278

LUMINAIRE SCHEDULE

TYPE	MANUFACTURER	DESCRIPTION / NOTES	FINISH	LIGHT SOURCE	POWER SOURCE	LUMINAIRE INPUT WATTS	VOLTAGE
LP1	Signify Gardco PPT-196L-650-WW-G2-T3-2-UNV-FAWS- TLRD7-F1-BK Mountain States Lighting MSRTA12-TT-DG060718C-P805-BLACK	New LED Pedestrian Luminaire New LED pedestrian luminaire on 12*-0" round aluminum pole. Type II distribution, maximum B1-U0-G1 rating, field adjustable wattage selector, twist lock 7-pin receptacle, 10kA surge protection, UL listed suitable for wet location.	TBD	Integral LED Initial Luminaire Lumens: 2,775 CCT: 3000K CRI: 80	Integral LED Driver Non-Dimming	30	120-277
LP2	Signify Gardco PPT-196L-1150-WW-G2-T3-2-UNV-FAWS- TLRD7-F1-BK Mountain States Lighting MSRTA12-TT-DG060718C-P805-BLACK	New LED Pedestrian Luminaire at Bus Stop New LED pedestrian luminaire on 12-0" round aluminum pole at bus stop. Type II distribution, maximum B1-U0-G1 rating, field adjustable wattage selector, twist lock 7- pin receptacle, 10kA surge protection, UL listed suitable for wet location.	TBD	Integral LED Initial Luminaire Lumens: 4,744 CCT: 3000K CRI: 80	Integral LED Driver Non-Dimming	51	120-277
LP3	Signify Gardco PPT-198L-2100-WW-G2-T3-2-UNV-FAWS- TLRD7-F1-BK Mountain States Lighting MSRTA12-TT-DG060718C-P805-BLACK	New LED Pedestrian Luminaire at Pedestrian Ramp New LED pedestrian luminaire on 12-0" round aluminum pole at pedestrian ramp. Type Il distribution, maximum 81-U0-61 rating, field adjustable wattage selector, twist lock 7-pin receptacle, 10kA surge protection, UL listed suitable for wet location.	TBD	Integral LED Initial Luminaire Lumens: 7,923 CCT: 3000K CRI: 80	Integral LED Driver Non-Dimming	93	120-277
LT	Cooper Metalux 4SNX-20SL-FDL-UNV-L830-CD-1-[FINISH]-U- [MOUNTING ACCESSORIES]	New Pendant Mounted LED Luminaire New pendant mounted LED luminaire at pedestrian bridge. Die-former cold rolled steel channel, tool-less channel/wireway cover, flat acrylic lens. UL listed for damp locations.	TBD	Integral LED Initial Luminaire Lumens: 1,786 CCT: 3000K CRI: 80	Integral LED Driver Electronic 0-10V Dimming	12	120-277

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ile Name: 24278-CLA-HW-025A-LT-DR-PLAN.dgn		Date:	Comments	Init.
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Jnit Information				
LIGHTING DESIGN AND ENGINEERING WAS MURILUS COURT SOLIT STEE VIZ.				
BOULDER, CO 93331 308-334-7299	0			

Colorado Department of Transportation





18500 E. Colfax Ave. Aurora, CD 80011 Phone: (303) 746–8639 Fax: N/A


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As Constructed	I-25 MOBILITY HUB (LONE TREE) LIGHTING AND ELECTRICAL PLAN	Project No./Code
No Revisions:		
Revised:	Designer: BRIAN NELSON Structure	
	Detailer: JON EHNERT Numbers	
Void:	Sheet Subset: LIGHTING Subset Sheets: LEO2 of 18	Sheet Number


Region 1-South Program



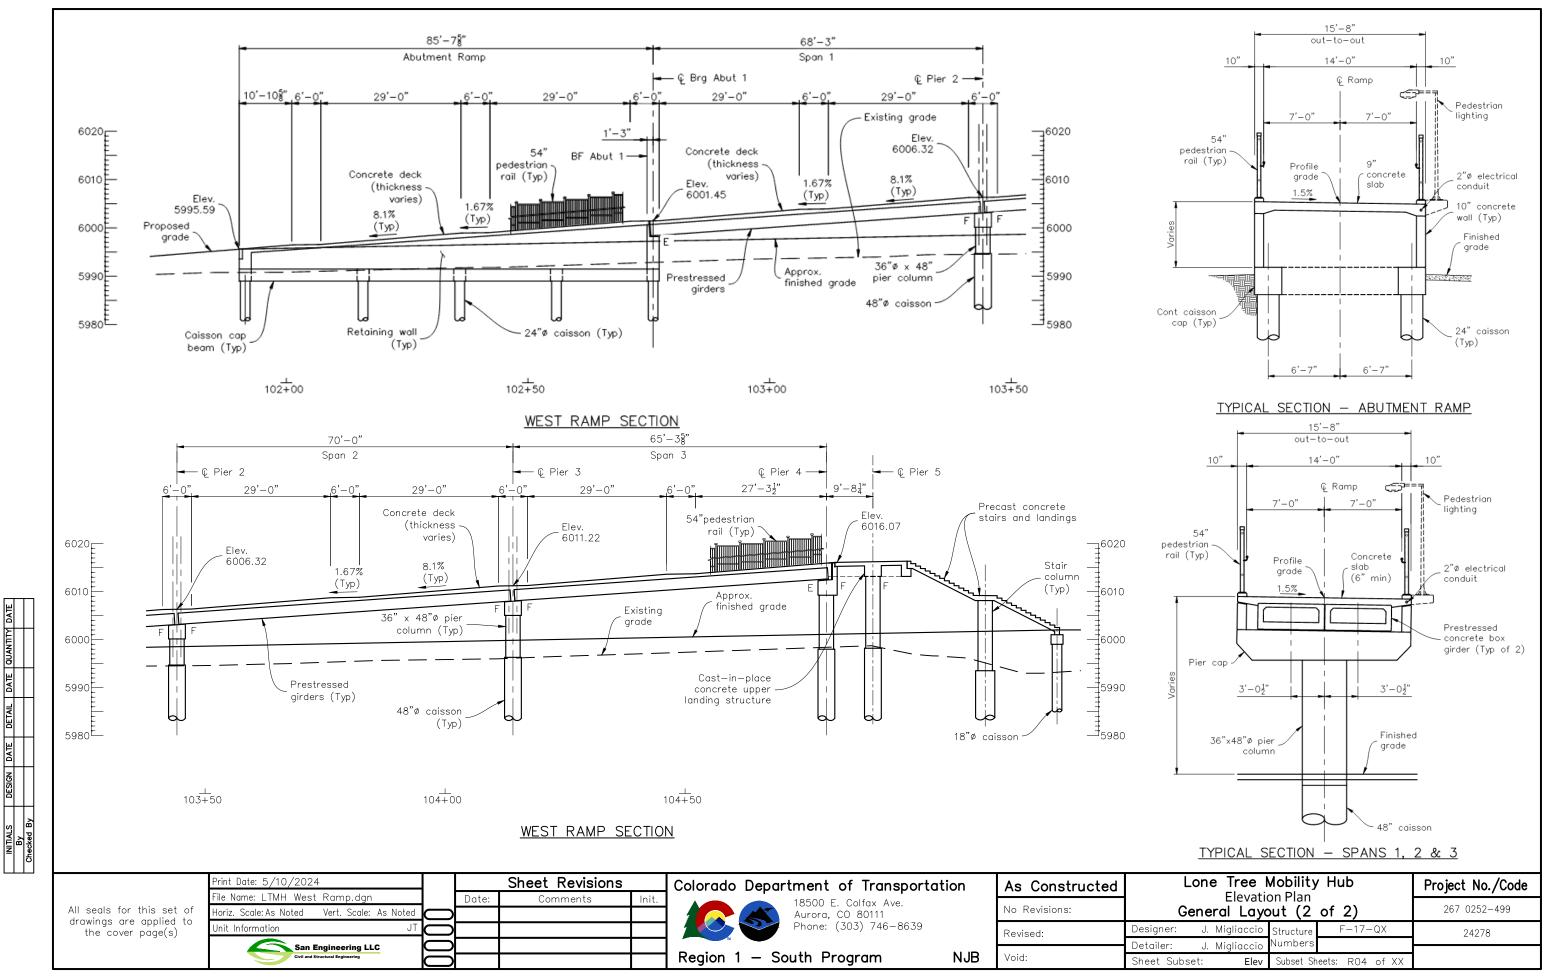


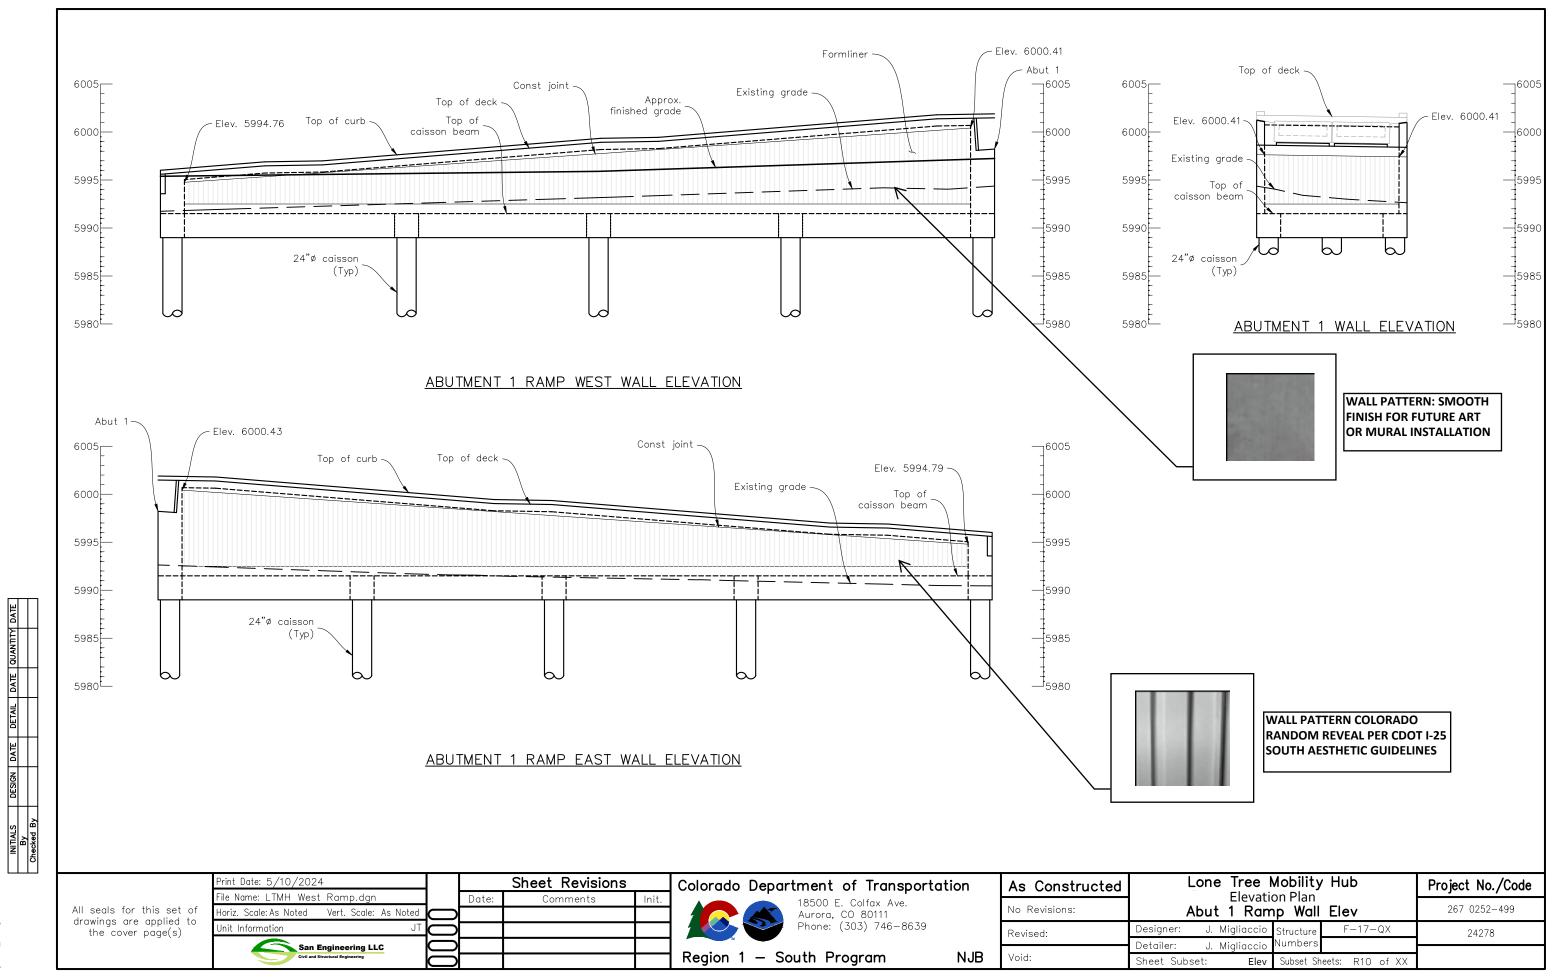

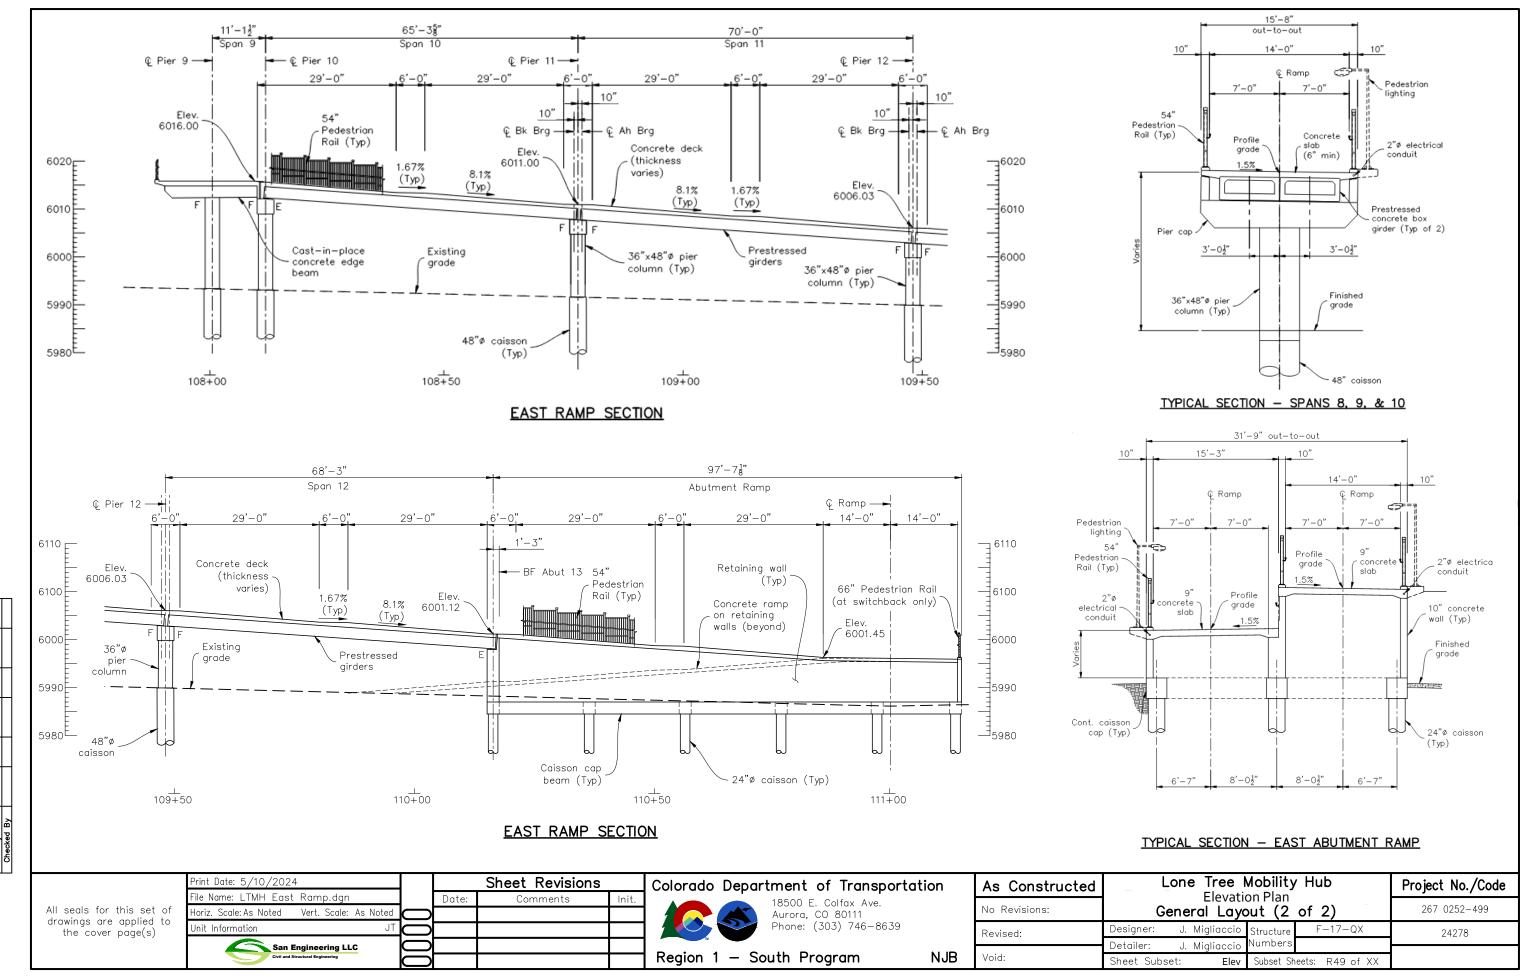
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Vert. Scale: As Note

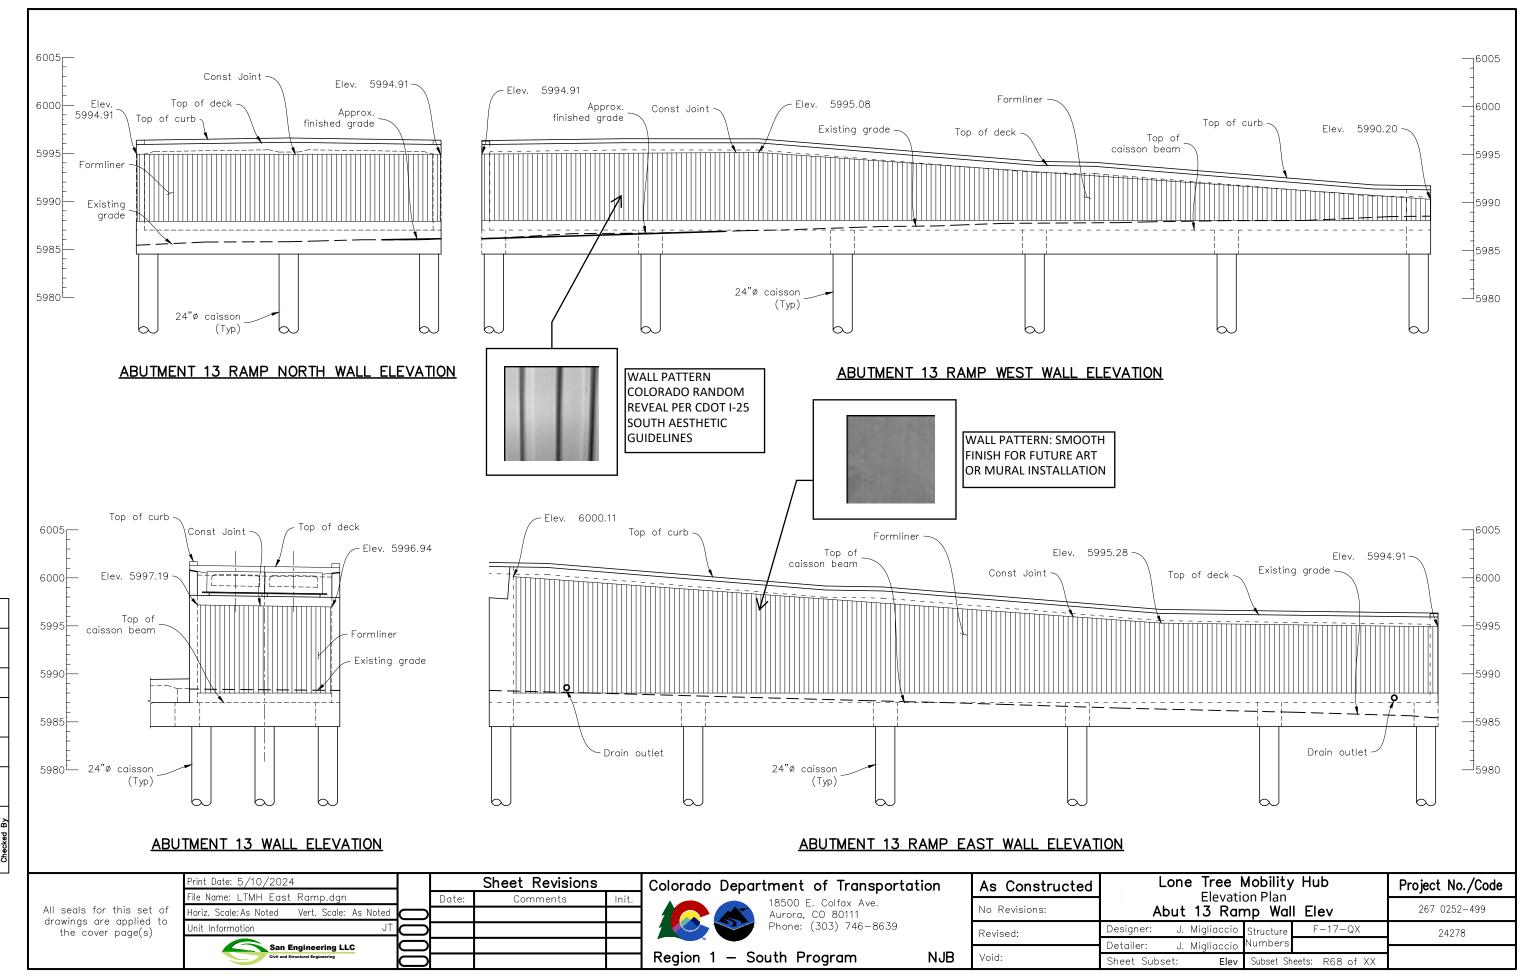San Engineering LLC

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Region 1 — South Program
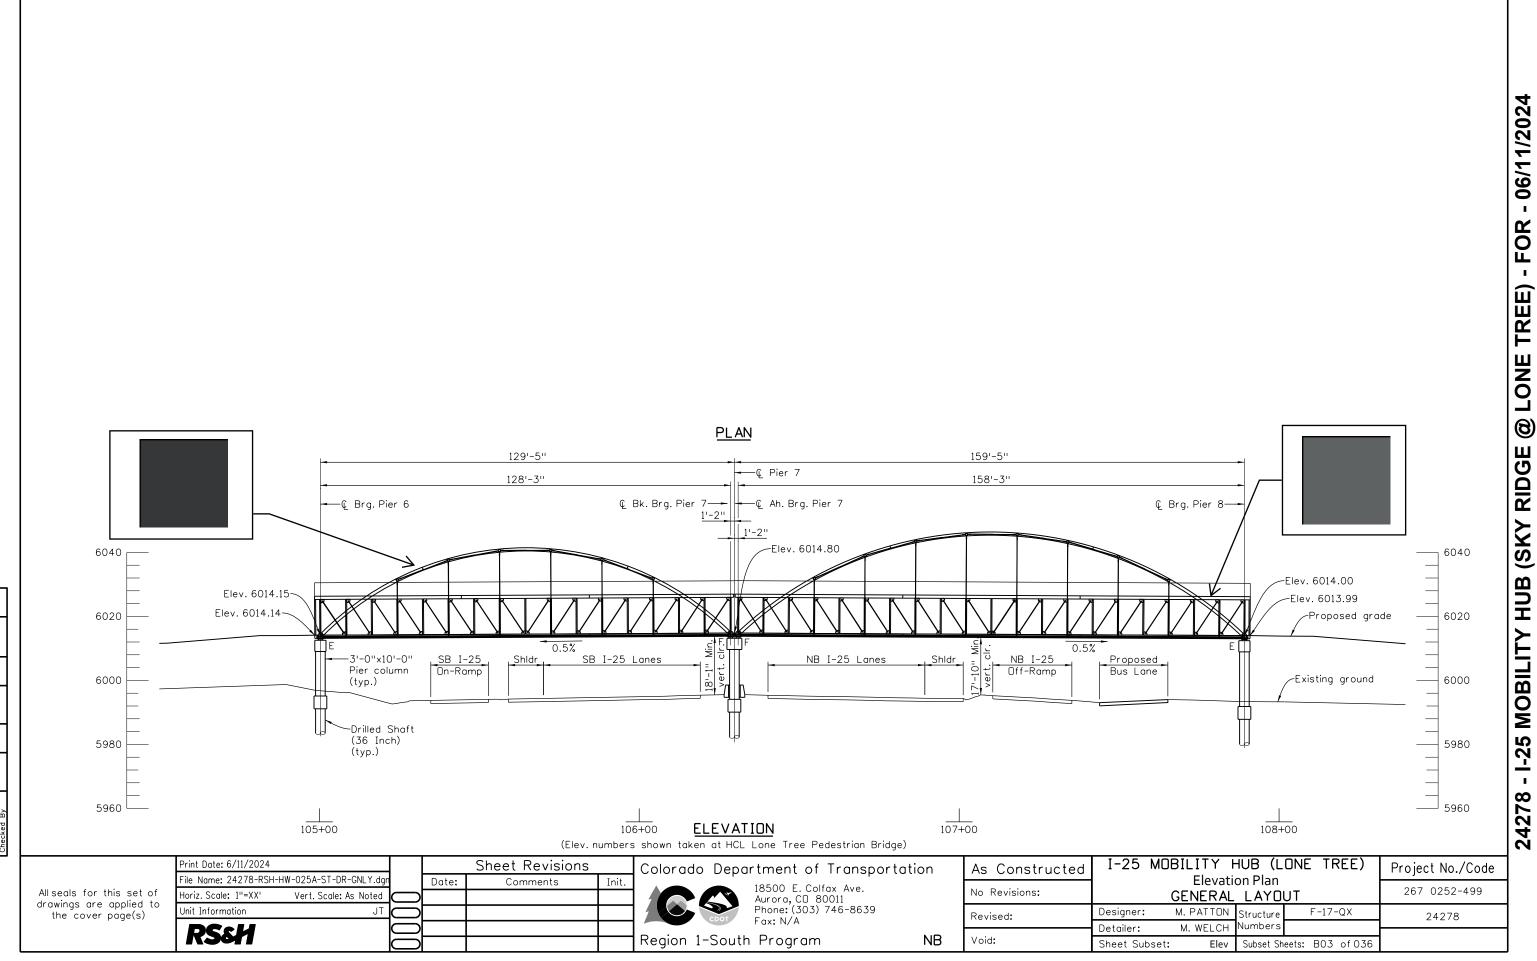
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Void:

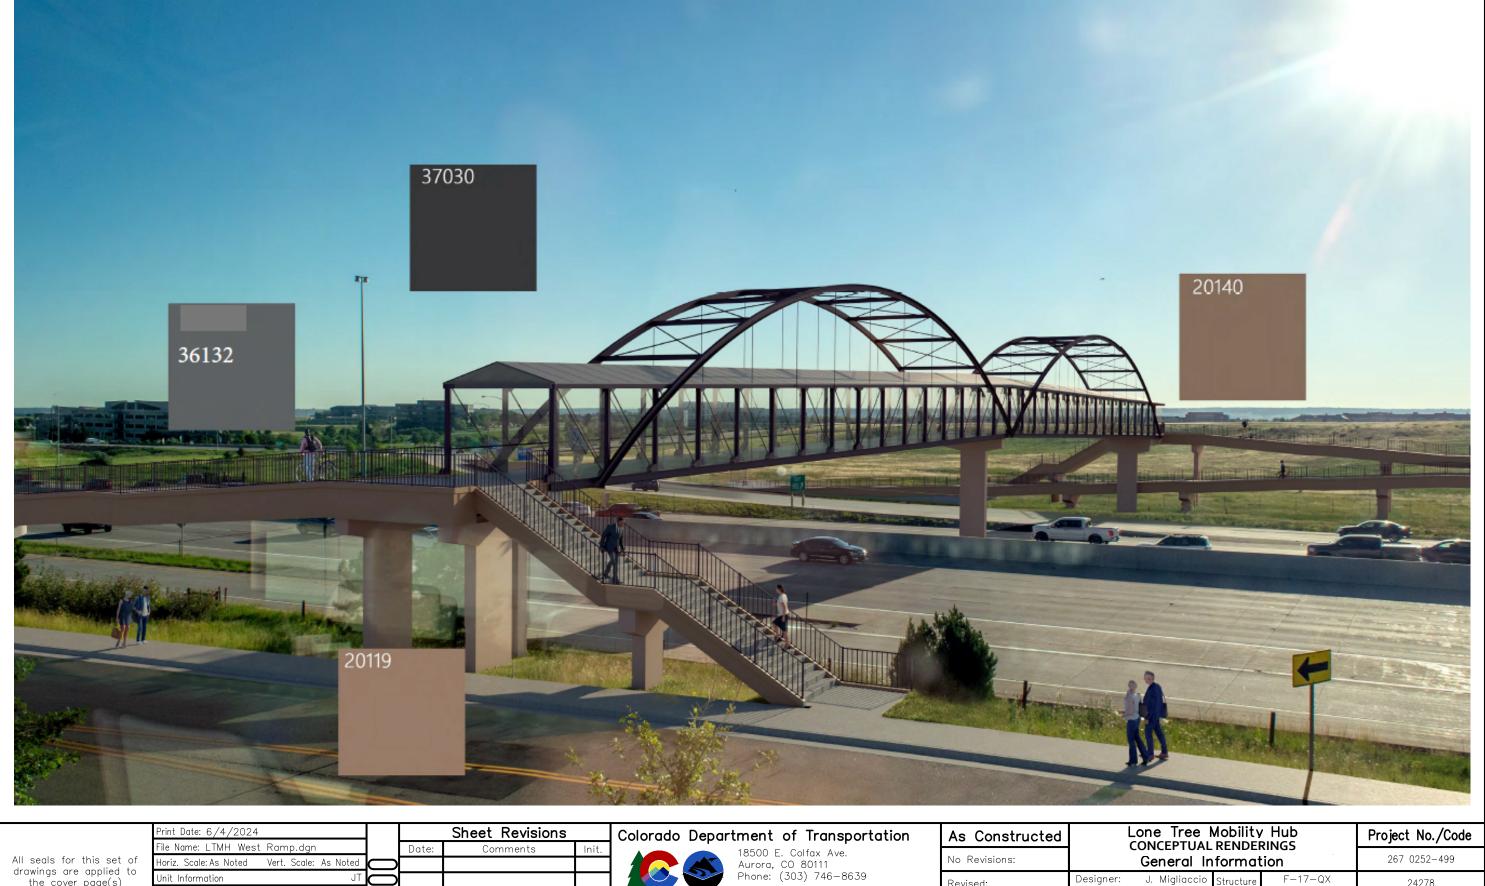NJB

Subset Sheets: RW01 of 50

General Information

REND

Designer:

Detailer:

Sheet Subset:


267 0252-499

24278

VIEW OF PEDESTRIAN BRIDGE ON SOUTHBOUND I-25



VIEW OF PEDESTRIAN BRIDGE ON NORTHBOUND I-25

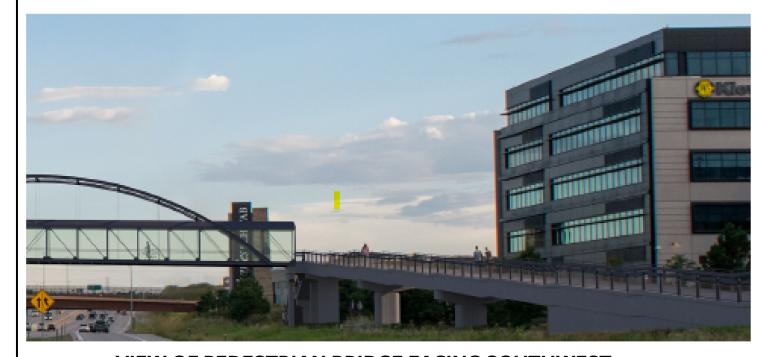

VIEW OF PEDESTRIAN BRIDGE FACING NORTHWEST



VIEW OF PEDESTRIAN BRIDGE FACING NORTHEAST

VIEW OF PEDESTRIAN BRIDGE FACING SOUTHWEST

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San Engineering LLC	U

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San Engineering LLC				
Civil and Structural Engineering	$\overline{}$			

	Colorado	Depart	tment	of 1	Transportation
			18500 E	. Colf	ax Ave.
ı			Aurora,		
1			Phone:	(303)	746-8639


	Phone: (303) 746-8639	
Region 1 - So	outh Program	NJB

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Revised:	Designer:	J. Migliaccio	Structure	F-17-QX	24278
	Detailer:	J. Migliaccio	Numbers		
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AESTHETIC DETAILS OF THE NEW MOBILITY HUB STRUCTURE WILL MATCH SKY RIDGE AVE AS SHOWN BELOW

PROJECT SITE AND REFERENCE ASSTHETICS VICINITY



SKY RIDGE AVE OVER I-25 AESTHETIC DETAILS

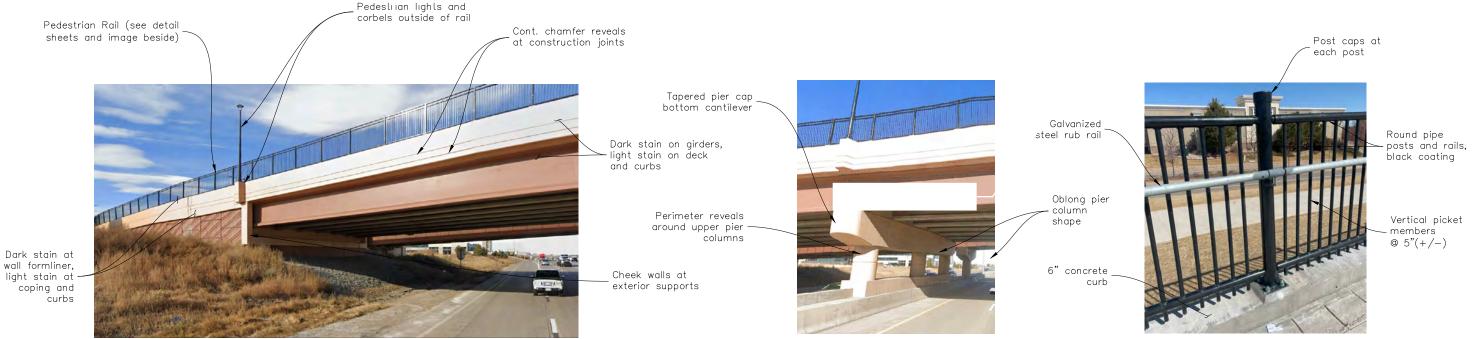SKY RIDGE AVE OVER I-25 AESTHETIC DETAILS

RAMP Pedestrian Rail STYLE




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Unit Information JT					
San Engineering LLC					
Civil and Structural Engineering					


Colorado	Depart	tment	of	Transportation
		18500 E	E. Co	olfax Ave.
		Aurora.	CO	80111

	18500 E. Colfax Ave. Aurora, CO 80111 Phone: (303) 746-8639	
Region 1 - So	outh Program	NJB

As Constructed				Mobility RENDER		Project No./Code
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Revised:	Designer:			Structure		24278
	Detailer:	J. Mi	gliaccio	Numbers		
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Region 1-South Program

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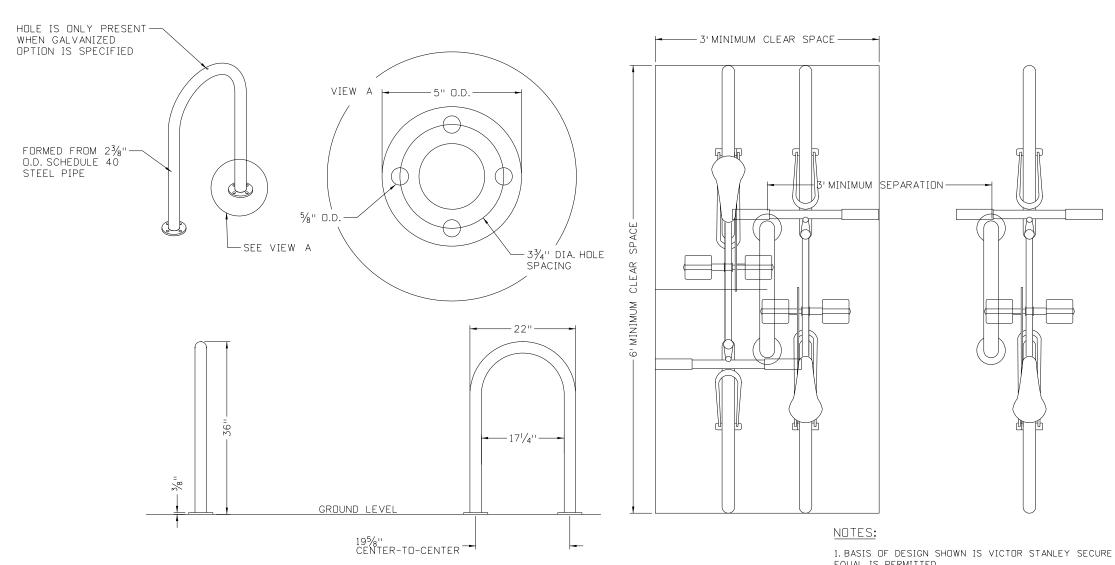
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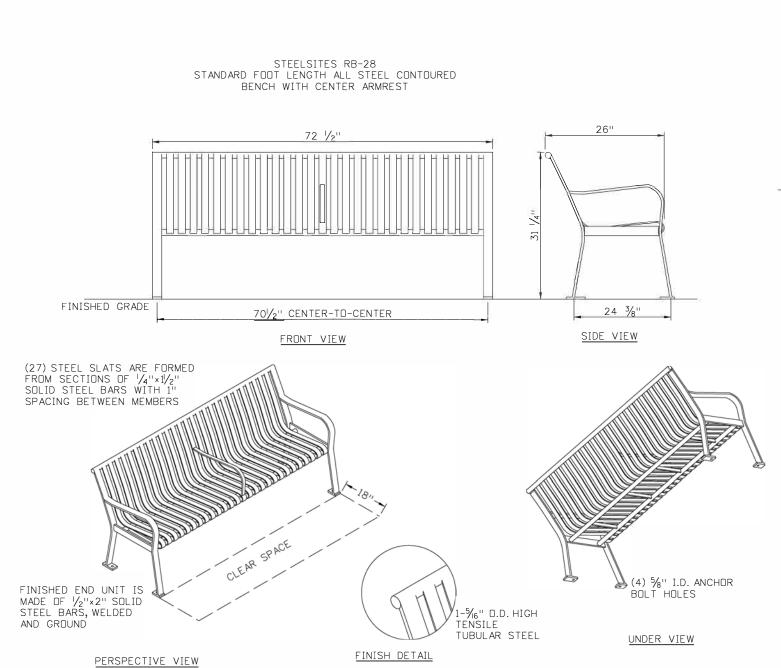
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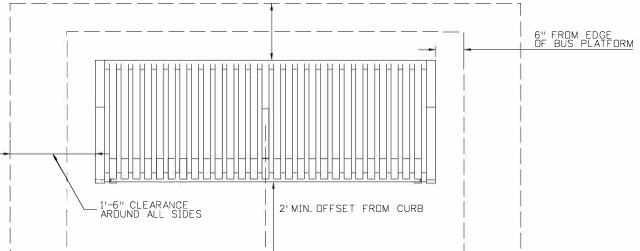
BIKE RACK INSTALLATION DETAIL

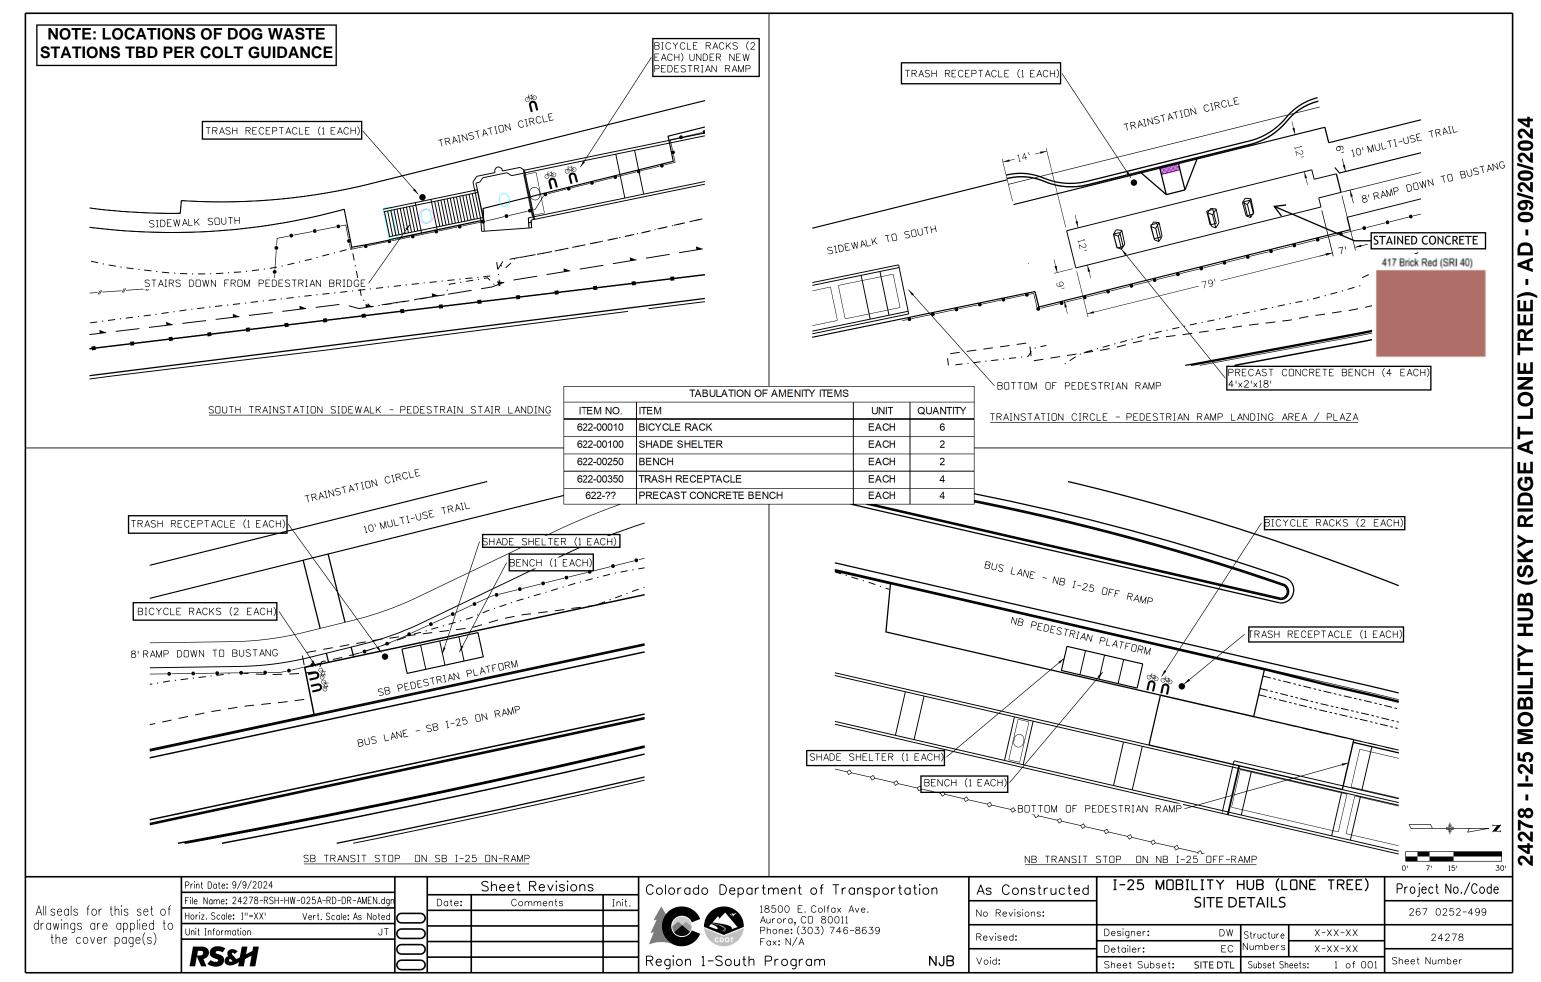- 1. BASIS OF DESIGN SHOWN IS VICTOR STANLEY SECURE SITE DESIGN COLLECTION. THIS DESIGN OR APPROVED EQUAL IS PERMITTED.
- 2. MINIMUM PAD THICKNESS FOR SURFACE MOUNTING IS 6".
- 3. MOUNTING: STANDARD SURFACE MOUNTING (AS SHOWN) AND IN-GROUND OPTIONS ARE AVAILABLE.
- 4. ANCHOR BOLTS SHALL NOT BE INSTALLED WITHIN 6" OF THE EDGE OF THE CONCRETE PAD. ANCHOR BOLTS ARE NOT INCLUDED WITH THE VICTOR STANLEY DESIGN SHOWN HERE.
- 5. BIKE RACKS SHALL BE INSTALLED A MINIMUM OF 2' FROM THE FACE OF CURB.
- 6. POWDER COATING IS TO BE RAL COLOR 6012 BLACK GREEN, GALVANIZED OR STAINLESS STEEL.
- 7. THIS PRODUCT MUST BE PERMANENTLY AFFIXED TO THE GROUND. CHECK LOCAL CODES FOR REGULATIONS.
- 8. ALL FABRICATED METAL COMPONENTS ARE STEEL SHOTBLASTED, ETCHED, PHOSPHATIZED, PREHEATED, AND ELECTROSTATICALLY POWDER-COATED WITH T.G.I.C. POLYESTER POWDER COATINGS. PRODUCTS ARE FULLY CLEANED AND PREHEATED, PREHEATED AND COATED WHILE HOT TO FILL CREVICES AND BUILD COATING FILM. COATED PARTS ARE THEN FULLY CURED TO COATING MANUFACTURER'S SPECIFICATIONS. THE THICKNESS OF THE RESULTING FINISH AVERAGES 8-10 MILS (200-250 MICRONS).
- 9. DRAWINGS NOT TO SCALE. DO NOT SCALE DRAWINGS.
- 10. DESIGN AND MANUFACTURER SHALL BE IN ACCORDANCE WITH THE AMERICAN INSTITUTE OF STEEL CONSTRUCTION (AISC).
- 11. INVERTED-U SHAPE SHALL BE FORMED FROM ONE SEGMENT OF STEEL PIPE USING METHODOLOGY THAT MAINTAINS THE STRUCTURAL INTERGRITY OF THE STEEL PIPE.

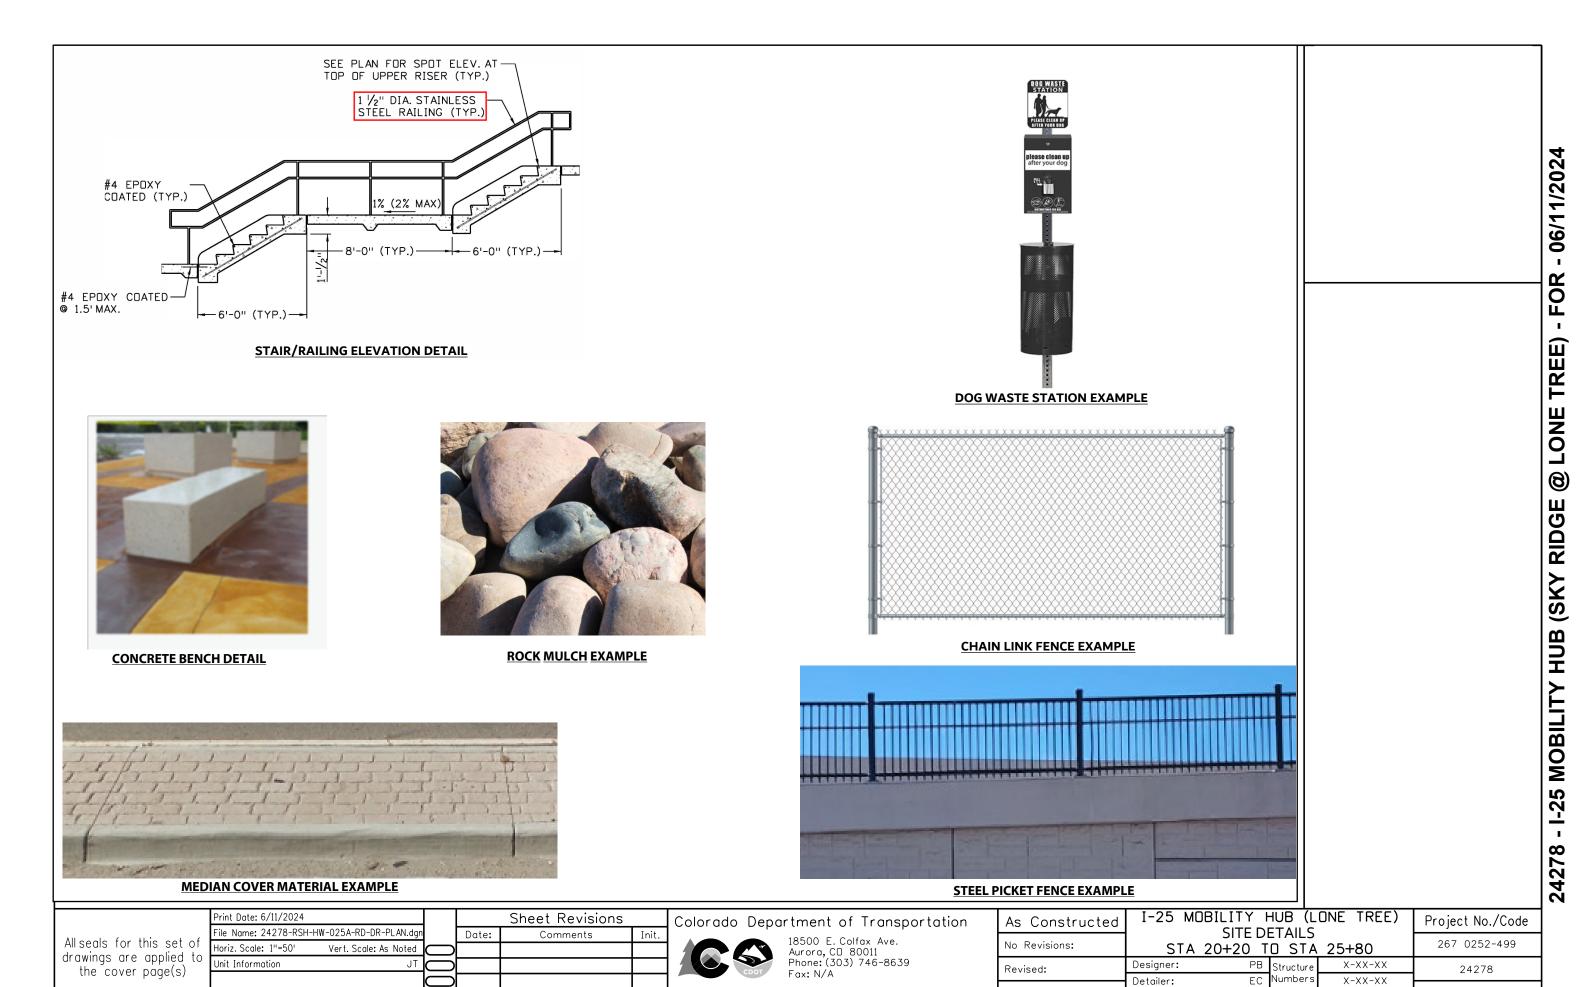L	Computer File Information			Sheet Revisions	Colorado Department of Transportation		STANDARD PLAN NO.
-	Print Date: 6/6/2024		Date:	Comments	2829 West Howard Place	DIVE DACK DETAILS	MOBILITY HUBS DRAFT
	ile Name: 60699717-06_MH	n (R-X)			CDOT HQ, 3rd Floor	BIKE RACK DETAILS	MODILIT I HUBS DKAFT
		\mathbb{R} -X			Denver, CD 80204 Phone: 303-757-9021 FAX: 303-757-9868		PLAN 4-1
	Detailer Initials:	\mathbb{R} -X					1211(11
	CAD Ver.: OPENROADS Scale: Not to Scale Units: English	R-X			DIVISION OF TRANSIT & RAIL	DRAFT - MOBILITY HUB STANDARDS DEVELOPED 2024	



MULTIPLE VIEWS - BENCH




1' OFFSET FROM WALL OR FENCE

PLACEMENT OF BENCH

NOTES:

- 1. BASIS OF DESIGN SHOWN IS VICTOR STANLEY STEELSITES RB COLLECTION. THIS DESIGN OR APPROVED EQUAL IS PERMITTED.
- 2. MINIMUM PAD THICKNESS FOR SURFACE MOUNTING IS 6".
- 3. ANCHOR BOLTS SHALL NOT BE INSTALLED WITHIN 6" OF THE EDGE OF THE CONCRETE PAD.
- 4. CLEAR ZONE OF 1.5'IN FRONT OF THE BENCH MUST BE CLEAR OF ALL OBSTRUCTIONS.
- 5. CLEARANCE OF 3' SHALL BE MAINTAINED BETWEEN FURNITURE/FIXTURES.
- 6. BENCH SHALL HAVE A MINIMUM OFFSET OF 2'FROM FACE OF CURB.
- 7. BENCHES SHALL BE OFFSET A MINIMUM OF 12" WHEN DIRECTLY ADJACENT TO A BUILDING, WALL, BARRIER, OR SOLID FENCE TO PERMIT TRASH AND SNOW REMOVAL.
- 8. 6'BENCH LENGTH SHOWN. OTHER STANDARD LENGTHS (4'OR 8') AVAILABLE AND MAY BE PERMITTED IF APPROVED.
- 9. POWDER COATING IS TO BE RAL COLOR XXX.
- 10. ALL FABRICATED METAL COMPONENTS ARE STEEL SHOTBLASTED, ETCHED, PHOSPHATIZED, PREHEATED, AND ELECTROSTATICALLY POWDER-COATED WITH T.G.I.C. POLYESTER POWDER CDATINGS. PRODUCTS ARE FULLY CLEANED AND PRETREATED, PREHEATED AND COATED WHILE HOT TO FILL CREVICES AND BUILD COATING FILM. COATED PARTS ARE THEN FULLY CURED TO COATING MANUFACTURER'S SPECIFICATIONS. THE THICKNESS OF THE RESULTING FINISH AVERAGES 8-10 MILS (200-250 MICRONS).
- 11. THIS PRODUCT MUST BE PERMANENTLY AFFIXED TO THE GROUND. CONSULT LOCAL CODES FOR REGULATIONS.
- 12. DRAWINGS NOT TO SCALE. DO NOT SCALE DRAWINGS.


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Print Date: 6/6/2024		Date:	Comments	2829 West Howard Place	DENGH	MODILITY HIDE DDAET
File Name: 60699717-19_MH DTR_PED_bench.dgn	R-X			CDDT HQ, 3rd Floor	BENCH	MOBILITY HUBS DRAFT_
	(R-X)			Denver, CD 80204 Phone: 303-757-9021 FAX: 303-757-9868		PLAN 7-6
Detailer Initials:	R-X					TEATI TO
CAD Ver.: OPENROADS Scale: Not to Scale Units: English	R-X			DIVISION OF TRANSIT & RAIL	DRAFT - MOBILITY HUB STANDARDS DEVELOPED 2024	

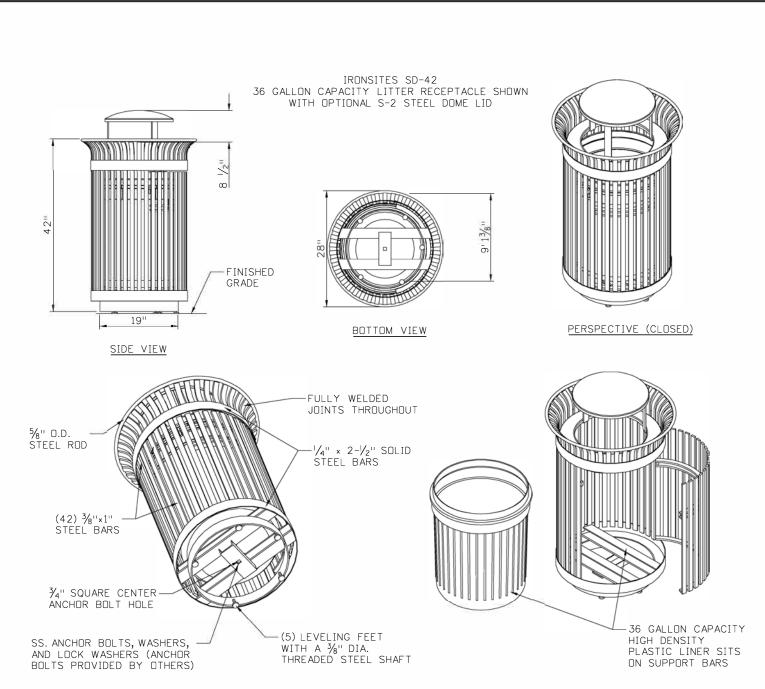

PERSPECTIVE (OPEN)

MULTIPLE VIEWS - LITTER RECEPTACLE

UNDER VIEW

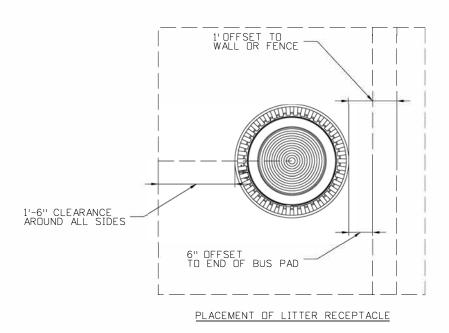

NOTES:

- 1. BASIS OF DESIGN SHOWN IS VICTOR STANLEY IRONSITES COLLECTION. THIS DESIGN OR APPROVED EQUAL IS PERMITTED.
- 2. MINIMUM PAD THICKNESS FOR SURFACE MOUNTING IS 6".
- 3. ANCHOR BOLTS SHALL NOT BE INSTALLED WITHIN 6" OF THE EDGE OF THE CONCRETE PAD.
- 4. TRASH RECEPTACLES SHALL HAVE A MINIMUM OFFSET OF 2'FROM FACE OF CURB.
- 5. TRASH RECEPTACLES SHALL BE OFFSET A MINIMUM OF 12" WHEN DIRECTLY ADJACENT TO A BUILDING, WALL, BARRIER, OR SOLID FENCE.
- 6. LID SHALL BE STANDARD TAPERED FORMED LID. AVAILABLE WITH OPTIONAL DOME LID.
- 7. OIL IMPREGNATED BRONZE BUSHINGS AND STAINLESS STEEL PIVOT PINS FOR DOOR MOVEMENT, STANDARD $\frac{3}{6}$ " SOLID STEEL LATCH ASSEMBLY OR OPTIONAL PATENTED STAINLESS STEEL KEYED LOCK ASSEMBLY.
- 8. POWDER COATING IS TO BE RAL COLOR XXX.
- 9. ALL FABRICATED METAL COMPONENTS ARE STEEL SHOTBLASTED, ETCHED, PHOSPHATIZED, PREHEATED, AND ELECTROSTATICALLY POWDER-COATED WITH T.G.I.C. POLYESTER POWDER COATINGS. PRODUCTS ARE FULLY CLEANED AND PRETREATED, PREHEATED AND COATED WHILE HOT TO FILL CREVICES AND BUILD COATING FILM. COATED PARTS ARE THEN FULLY CURED TO COATING MANUFACTURER'S SPECIFICATIONS. THE THICKNESS OF THE RESULTING FINISH AVERAGES 8-10 MILS (200-250 MICRONS).

10. PLASTIC INNER LINERS ARE MOLDED ON TOOLING DESIGNED FOR AND OWNED BY VICTOR STANLEY, INC. THEY OFFER MAXIMUM CAPACITY AND STRENGTH WITH LIGHTWEIGHT CONSTRUCTION USING CRITICAL MOLDED RIBS, INTEGRAL HANDHOLDS, AND HIGH-STRENGTH MATERIALS. THIS MINIMIZES HANDLING DIFFICULTY AND FACILITATES EASY EMPTYING AND STORAGE WHILE AFFORDING LONG SERVICE LIFE.

11. FOR HIGH SALT ABUSIVE CLIMATES, HOT-DIP GALVANIZING INCLUDES AN AGGRESSIVE PRE-TREATMENT AND IMMERSION IN A TANK OF CHARGED LIQUID ZINC AT OR AROUND 860°F (460°C). THE REULTING SURFACE IS RESISTANT TO RUST BUT HAS SOME UNEVENNESS RESULTING FROM THE BONDING OF THE ZINC TO THE STEEL SURFACE. AS A RESULT, THE POWDER-COATING SURFACE FINISH OVER THAT GALVANIZED SURFACE MAY EXHIBIT BUMPS, UNEVENNESS, AND MAY NOT BE AS SMOOTH AS THE STANDARD FINISH; THIS UNEVEN AND INCONSISTENT FINISH IS NORMAL FOR GALVANIZING. CONTACT MANUFACTURER FOR DETAILS.

- 12. THIS PRODUCT MUST BE PERMANENTLY AFFIXED TO THE GROUND. CONSULT LOCAL CODES FOR REGULATIONS.
- 13. DRAWINGS NOT TO SCALE. DO NOT SCALE DRAWINGS.

Computer File Information			Sheet Revisions	Colorado Department of Transportation		STANDARD PLAN NO.
Print Date: 6/6/2024		Date:	Comments	2829 West Howard Place CDUT HQ, 3rd Floor Denver, CD 80204 Phone: 303-757-9021 FAX: 303-757-9868	TRASH RECEPTACLE	MODILITY HIDE DDAET
File Name: 60699717-20_MH DTR_PED_trash.dgn	R-X					MOBILITY HUBS DRAFT
	(R-X)					PLAN 7-7
Detailer Initials:	R-X					
CAD Ver.: DPENRDADS Scale: Not to Scale Units: English	(R-X)		- -	DIVISION OF TRANSIT & RAIL	DRAFT - MOBILITY HUB STANDARDS DEVELOPED 2024	